Bloomington Historic Preservation Commission Showers City Hall McCloskey Room, Thursday March 28, 2019, 5:00 P.M. AGENDA

#### I. CALL TO ORDER

#### II. ROLL CALL

#### III. APPROVAL OF MINUTES A. March 14, 2019 Minutes

#### IV. CERTIFICATES OF APPROPRIATENESS

**Staff Review** 

A. COA 19-14
606 W. Howe (Greater Prospect Hill Historic District)
Petitioner: Lindsey Muller
Build 6' vertical plank privacy fence to replace existing chainlink fence.

#### **Commission Review**

A. COA 19-09 1111 E. Wylie (Continuation from 2/28/19 Meeting) Petitioner: Malcolm Dalglish Widen driveway, relocate retaining wall, and construct shed roof attachment on east elevation of the home **B.** COA 19-11 (Continuation from 2/28/19 Meeting) 512 W. Howe (Greater Prospect Hill Historic District) Petitioner: Matthew Francisco & Selma Sabanovic Construct 400sqft garage with a 322sqft ADU unit on the second floor C. COA 19-12 1003 W. Howe (Greater Prospect Hill Historic District) Petitioner: Chris Sturbaum (Golden Hand) Two additions to the rear of the home. D. COA 19-13 221 E. Kirkwood (Victoria Towers) Petitioner: Tim Cover (Studio 3 Design, Inc) Add second floor to the one-story addition on north side of property; raise the wall and a portion of the flat roof on a block building addition on the west side; add skylights to roof of original building; restorative work on Kirkwood façade.

#### V. DEMOLITION DELAY

#### VI. NEW BUSINESS

A. Notification of demolition on N. Madison. Presented by Philippa Guthrie

#### VII. OLD BUSINESS

#### VIII. COMMISSIONER COMMENTS

#### IX. PUBLIC COMMENTS

#### X. ANNOUNCEMENTS

#### XII. ADJOURNMENT

Auxiliary aids for people with disabilities are available upon request with adequate notice. Please call 812-349-3429 or email, <u>human.rights@bloomington.in.gov.</u> Next meeting date is April 11, 2019 at 5:00 P.M. in the McCloskey Room. **Posted:** 3/21/2019

## Bloomington Historic Preservation Commission Showers City Hall McCloskey Room, Thursday March 14, 2019, 5:00 P.M. MINUTES

#### I. CALL TO ORDER

Meeting was called to order by Jeff Goldin, @ 5pm.

#### II. ROLL CALL

#### Commissioners

John Saunders Lee Sandweiss Deb Hutton Jeff Goldin Leslie Abshier Susan Dyer Chris Sturbaum Sam DeSollar

#### Advisory

Duncan Campbell Ernesto Casteneda Jenny Southern 5:05

Absent Doug Bruce Derek Richey

#### Staff

Conor Herterich, HAND Eddie Wright, HAND Eric Sader, HAND

**Guests** Clayton Nunes Landon Feree

#### III. APPROVAL OF MINUTES

A. February 28, 2019 Minutes

**Deb Hutton** made a motion to approve February 28, 2019 Minutes, **Lee Sandweiss** seconded. **Motion carried 6-0-2 (Yes-No-Abstain)** 

#### IV. CERTIFICATES OF APPROPRIATENESS

#### **V. DEMOLITION DELAY**

#### **Commission Review**

A. Demo Delay 19-04614 N. GrantPetitioner: Clayton NunesEnclose porch to create living space.

Conor Herterich gave presentation. See packet for details.

Discussion ensued

**Chris Sturbaum** asked if more windows were considered to make it look more like a sun porch. **Sam DeSollar** asked about the placement of the door, 3 foot landing and a light outside the door.

John Saunders agreed with Chris about more windows in the front.

John Saunders made a motion to waive and release the demo delay period, Chris Sturbaum seconded. Motion carried 8-0-0.

**B. Demo Delay 19-05** 717 E. Hunter Petitioner: Landon Feree Construction Large addition to the rear of the home.

Conor Herterich gave presentation. See packet for details.

Discussion ensued

**Chris Sturbaum** asked about the pitch on the drawing and the changes being made. **Landon Feree** explained that they were expanding the bedrooms. **Chris** asked if the ridge of the addition was visible from the street, if the structure was zoned multi-family, and the dimension of the siding. **Landon Feree** replied that the ridge would be visible, the structure is zoned multi-family, and the siding is to be 4 inches all the way around the house. **Landon Feree** also stated that he is also saving the windows to be reused on the addition and is putting down hardwood floors throughout the house. **Jenny Southern** suggested that he might consider placing the windows on the opposite side of the house. **Sam DeSollar** suggested they use something between changes siding changes so it's not so obvious.

John Saunders made a motion to waive and release the demo delay period, Deb Hutton seconded. Motion carried 7-0-1.

VI. NEW BUSINESS

#### VII. OLD BUSINESS

#### VIII. COMMISSIONER COMMENTS

**Sam DeSollar** suggested they solicit the trades for individuals who have skills pertaining to working on historic structures. This would have to be approved by City Legal and would not be an endorsement by the Commission of the people on the list. **Conor Herterich** stated that he would be giving a presentation to the Builders Association of South Central Indiana and he would mention this to them and give the opportunity to be on this list.

#### IX. PUBLIC COMMENTS

#### X. ANNOUNCEMENTS

**Conor Herterich** mentioned he is working with Mallory Rickbeil, the City of Bloomington Bicycle and Pedestrian coordinator on a historic bike tour. The theme would be African-American history. This is just in the early planning stages at this point but will not be based upon any existing tour brochures but could become a brochure in the future.

#### XII. ADJOURNMENT

Meeting was adjourned by Jeff Goldin @ 5:20 pm.

#### **END OF MINUTES**

## **COA: 19-14**

Address: <u>606 W. Howe</u> Petitioner: Lindsey Muller Parcel #: 53-08-05-104-004.000-009

Property is Contributing

Circa. <u>1930</u>



- *Background:* Built circa 1930 in the Greater Prospect Hill Historic District, the structure is a slightly altered front gabled Bungalow.
- *Request*: Remove exisiting chain-link fence and replace with a 6' privacy fence. The new fence will be dog picket vertical planks of treated wood .

Staff Decision: Staff approves COA 19-14 for the following reasons:

 The privacy fence does not obscure the street facing façade of the structure.
 The proposed fencing material and style is compatible with other fences found in Greater Prospect Hill Historic District.

(Staff Review)

#### APPLICATION FORM CERTIFICATE OF APPROPRIATENESS

Case Number:	9-	14
Date Filed:	3/14	110
Scheduled for Hearing	:	3/28/19

******
Address of Historic Property: 606 W. Howe St.
Petitioner's Name: Undsay & Pariel Muller
Petitioner's Address: 606. W. Howe St.
Phone Number/e-mail: (812)322-4924 lindsey. Kinder@gmail.com
Owner's Name: Undsug & Daniel Muller Owner's Address: same as above
Owner's Address: same as above
Phone Number/e-mail: Same as above

#### Instructions to Petitioners

The petitioner must attend a preliminary meeting with staff of the Department of Housing and Neighborhood Development during which the petitioner will be advised as to the appropriateness of the request and the process of obtaining a Certificate of Appropriateness. The petitioner must file a "complete application" with Housing and Neighborhood Department Staff no later than seven days before a scheduled regular meeting. The Historic Preservation Commission meets the second Thursday of each month at 5:00 P.M. in the McCloskey Room. The petitioner or his designee must attend the scheduled meeting in order to answer any questions or supply supporting material. You will be notified of the Commission's decision and a Certificate of Appropriateness will be issued to you. Copies of the Certificate must accompany any building permit application subsequently filed for the work described. If you feel uncertain of the merits of your petition, you also have the right to attend a preliminary hearing, which will allow you to discuss the proposal with the Commission before the hearing during which action is taken. Action on a filing must occur within thirty days of the filing date, unless a preliminary hearing is requested.

Please respond to the following questions and attach additional pages for photographs, drawings, surveys as requested.

A "Complete Application" consists of the following:
1. A legal description of the lot. Parent ID: 53-08-05-104-004,000-009
2. A description of the nature of the proposed modifications or new construction: Privacy fence for buckyurd to replace existing /rusted chain link fence
Standard 6' vertical planks Gencept portion in Front will be 4' high
2 gates : one by buck portion in front will be 4' high 3. A description of the materials used. Wood / treated
U" x y" wood posts 3 x 2xy"(per section)
fence fastered w/ screws
· · · · · · · · · · · · · · · · · · ·

4. Attach a drawing or provide a picture of the proposed modifications. You may use manufacturer's brochures if appropriate.

5. Include a scaled drawing, survey or geographic information system map showing the footprint of the existing structure and adjacent thoroughfares, Geographic Information System maps may be provided by staff if requested. Show this document to Planning Department Staff in order to ascertain whether variances or zoning actions are required.

6. Affix at least three photographs showing the existing full facade at each street frontage and the area of modification. If this petition is a proposal for construction of an entirely new structure or accessory building, include photographs of adjacent properties taken from the street exposure.


#### \*\*\*\*\*

If this application is part of a further submittal to the Board of Zoning Appeals for a Conditional Use or development standard variance, please describe the use proposed and modification to the property which will result.



#### P.O. Box 1452 • Bloomington, Indiana • 47402 Phone# 812-824-1427 • Fax 812-824-9976 michaelsterrett@yahoo.com affordablefence.org

		Name	Lindsey	Muller	Address	Leale W	Howe St
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IMG\_2149.JPG
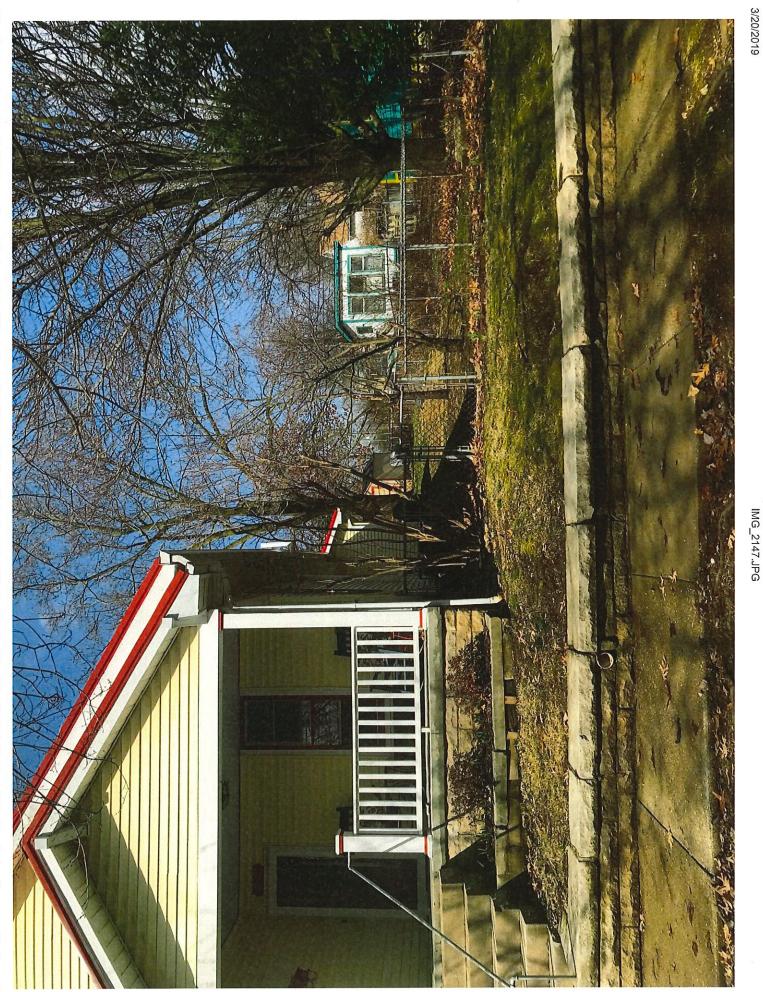
# COA: 19-11 *(continued)*

Address: <u>1111 E. Wylie</u> Petitioner: Malcolm Dalglish Parcel #: 53-08-04-117-004.000-009

## Property is **Contributing**

Circa. <u>1925</u>





*Background:* A limestone Tudor Revival style home located in the local Elm Heights historic district.

*Request*: Modifications as follows:
1.Widen driveway
2.Relocate the retaining wall to accommodate the wider driveway.
3.Construct a 15' X 9' shed roof attachment with translucent roof to create a protected space for a charging station on the east elevation of the home.


Staff Decision: Staff recommends approval of COA 19-09 for the following reasons:

- 1. The petitioner has provided the details on the railing material and design. (see packet)
- 2. The petitioner has modified the design to accommodate the feedback of the HPC:
  - Shed roof addition will be made from steel posts and box beam so structure has a thinner appearance than previous design. Will be painted dark brown to match trim on the house.
  - Corner brackets were removed from the design.
  - Corrugated polycarbonate material chosen for roofing material. (see packet)

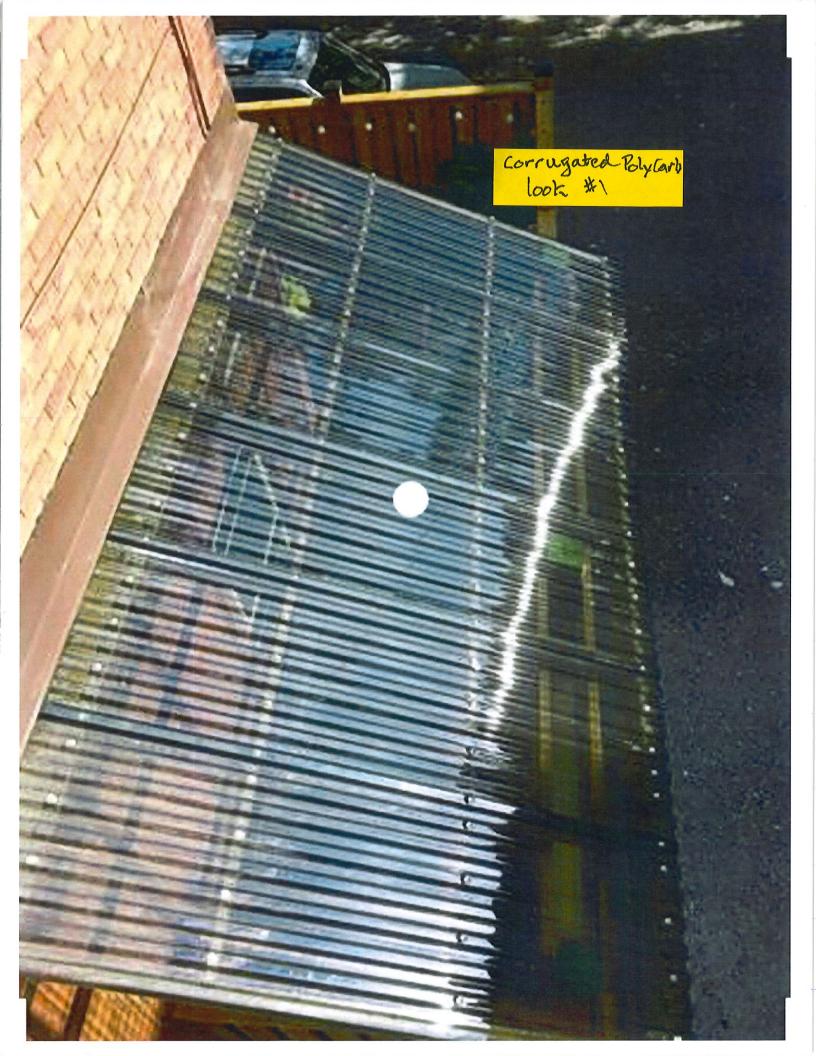

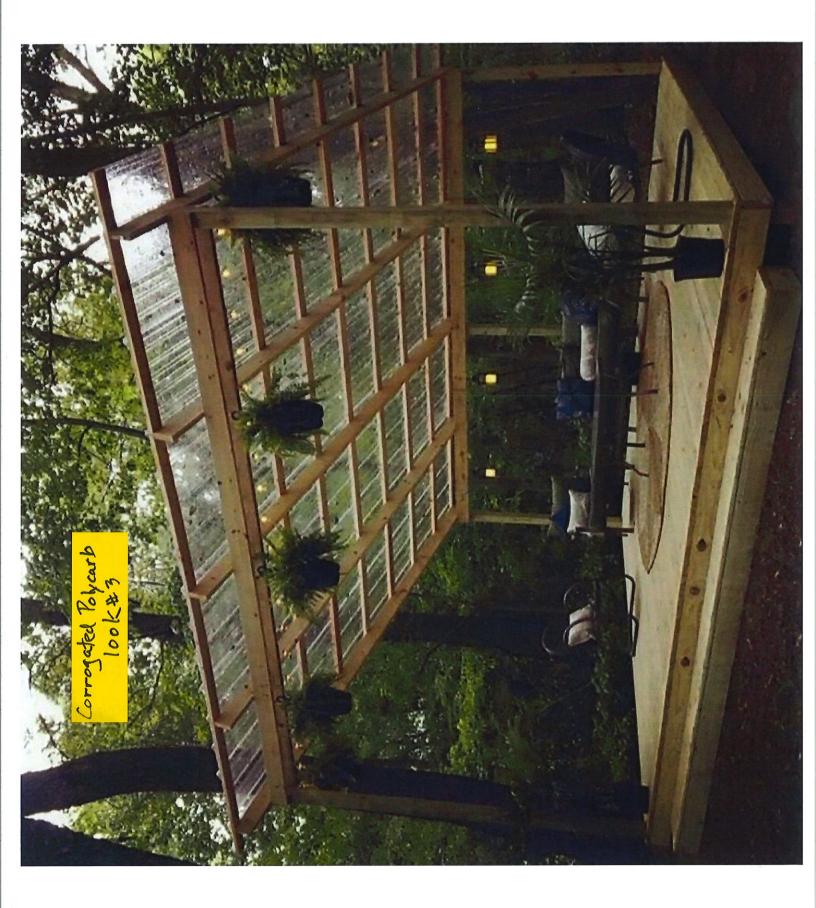



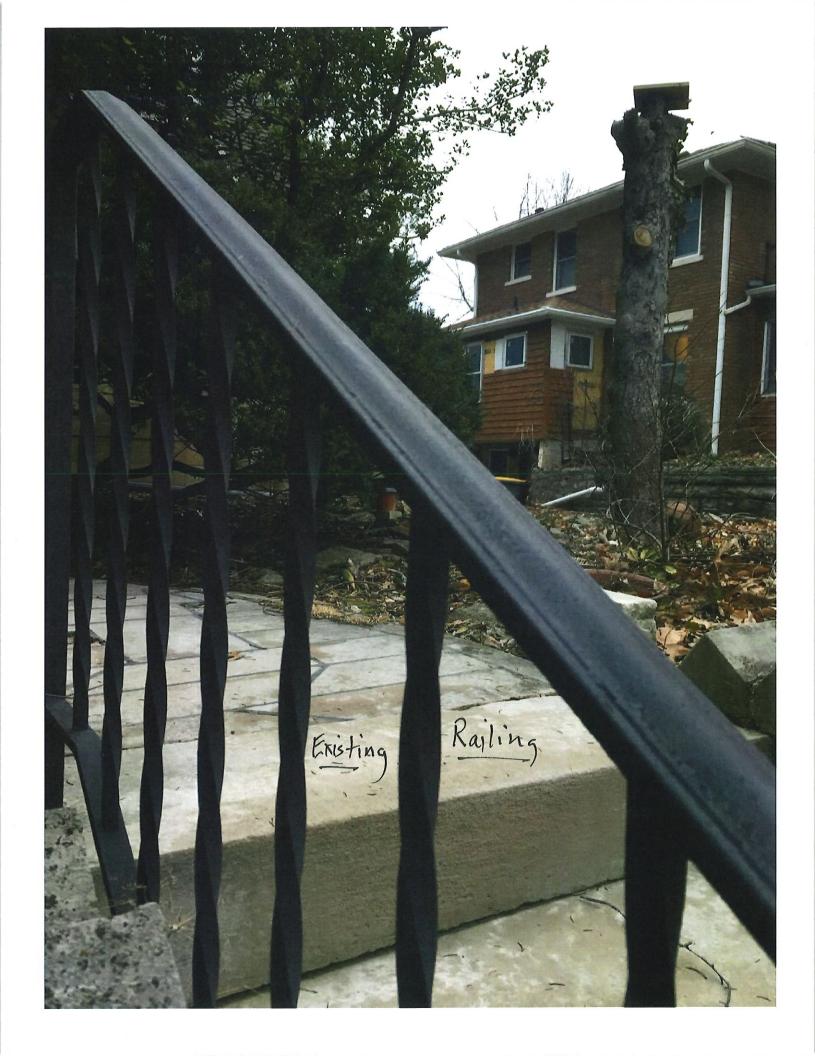



#Zof3 BACK Ground Reading for HPC !

#### Petition for Variance revised 2/2/19

Malcolm Dalglish & Judy Klein 1111 East Wylie St. (015-03940-00 Hawthorne Lot 6)

#### 1. Setback code

**2. Non-permitted roofing material** for 25 foot long open pergola like awning designed **to** provide cover for a car, bikes an outdoor basement stairway on the east side of our residence, as well as allow light to the first floor of our house and the plantings in the garden at the end of our shared driveway.

#### Goal / Overview:

We are seniors wanting to grow old in this our home of over 30 years. We've chosen this design to provide the following necessities:

• Safety & Accessibility The current shared 8 foot wide driveway is useless. There is high risk of scraping the sides of our compact car and no room for car doors to be opened nor the passage of a bicycle past a car parked in the driveway. There is an extremely steep descent down to the only secure bike storage, the basement. It's treacherous even when not covered by ice or snow and quite hazardous for an elderly person. This design would alleviate these factors.

• **Proper Drainage** from 3 neighboring houses- the 100 year floods that are now occurring frequently throughout the year cause the water from 3 adjacent houses to flow into our driveway and into our basement. This design proposed along with water deviations in our backyard will greatly alleviate this problem.

• Historical Preservation & Ecology- We live in a neighborhood in which bicycles easily provide 60% of our in-town travel. We own one small car and plan to utilize, when feasible, a plug-in low emission vehicle. An old coal shoot would be repurposed as a charging station. Our aesthetic in our 30+ years of ownership of this home has been to restore and preserve the historical integrity of its original design; elements such as the original double hung windows, storms, floors & moldings, and lath plaster walls. In keeping with the times though, we have made quite a few environmental upgrades not available in 1927; such as foam insulation, safer and more energy efficient utilities, improved kitchen & bathroom and more

• Beauty-Privacy and Light As we age, and spend more time indoors, natural light, with privacy is extremely important to our wellbeing. Transforming an unsharable useless ugly narrow driveway into a pergola rock garden sheltered safe space for gatherings, tricycles, bicycles, where small cars from both homeowners have equal access and passage to off street parking...It's a beautiful project, that will allow us to age in our home.

#### 1. Setback Variance:

We would widen the driveway on our side and relocate our wall to provide space for our car, bicycles, as well as a sheltered basement stairway entrance. We'd need a support post 3 feet 9 inches from the property line rather than the 6 foot requirement. Our proposed support post would not be any closer to the property line than the existing masonry walls on both sides of the shared driveway. The current masonry retaining wall on our side of the driveway serves no function and is crumbling.

#### 2. Non-permitted roofing material:

We've been told by the Historic Preservation Committee that this pergola needs to be a non-permanent structure that will in no way compromise the integrity of the original exterior of the house when removed. All the permitted roofing options are non-recyclable and would end up in a land fill once removed. They are also opaque and if used, would darken all the windows on the east side of our house and block all the morning light coming through those windows, a prospect that would be unacceptable for age in place livability of the ground floor of our house. Our only viable options for a translucent cover would be a polycarbonate roof. We would like a translucent PC material for the following reasons:

• New improved polycarbonate technology is not only recyclable, one can sell it, as it is easily reconstituted back into usable PC. This roofing material has a life span of 10-25 years depending on its manufacture, design, usage and installation technique. It's got a wide temperature range and is easier and cheaper to install, maintain, replace or remove than asphalt shingles, thereby facilitating any historic restoration a future owner may have.

• Natural light: The material would not only allow light and the changing colors of trees to come into our living room, but the distortion would offer our downstairs bedroom an acceptable amount of privacy from our driveway sharing neighbor's windows just 20 feet away. The driveway ends in a rock garden. Plantings there and hanging from the pergola would be allowed to thrive with plenty of sunlight.

• Neighborhood Aesthetics The transparent nature of the material would also allow neighbors to enjoy the sturdy timber joinery of the open pergola lattice structure. (See curated example images) Our neighborhood has many shoddy looking temporary structures and carports. The inspiration for our structure came from a beautiful side-of-the-house project across the street on the east side of an equally old historic designated house.

• **Safety** In low light periods of the day, it would be easier to see our way around without lightbulbs.

•Importance of Translucence We feel that the semitransparency of this covering is a keystone requirement in the design of this entire project. We would not be able to give up the morning light coming into our home and would cancel this age-in-place scheme of ours if we were required to use the opaque nonrecyclable permitted roofing materials on this awning structure.

Polycarb vs Tempered glass for this application?	Background Reading for HPC	
Translucent Polycarbonate	Tempered Glass	Asphalt Shingle
More Resilient impact, weather tree limbs, cantilever	Less Resilient unsafe	same
Stronger flexible	Weaker, brittle shatter or crack	same
Light weight	Неаvy	heavier
Aging properties (yellows under constant UV light after 10 yrs maybe(non issue) but far better than	Remains clear	longer
fiber/plexiglass/ABS/PVC .Yellow= litmus indicator (does not turn green.)		
Polycarb is a sellable recyclable material	Pyrex and other types of tempered glass are not recyclable.	landfill
Easy to work with, install, remove, and replace	Difficult	Difficult
similar maintenance and cleaning with available	vith available hose down	Difficult
allows light, true colors, distorted translucence	allows light translu.only film gass gives	opaque
privacy	privacy	
safer to work with walk on with plywood if needed	unsafe work with to walk on	safe

roofing panels easy to acquire

difficult

easy

specialist

requires specialist

DIY friendly

Background Reading for HPC

Asa Palley & Charlotte Agger 1113 E. Wylie St. Bloomington IN 47401

Jan 15, 2019 City of Bloomington Planning Dept Board of Zoning Appeals atn: Amelia Lewis 401 N. Morton Str. Suite #130 Bloomington, IN 47404

re: A variance from side yard setback standards for an attached carport & a variance from architectural standards to allow for a polycarbonate roof.

To whom it may concern:

We are the owners and residents of the home sharing the driveway which will be impacted by this carport construction project, and have received notice of the hearing at 5:30 pm on February 21, 2019 in the common council Chambers Room #115 of the City Hall Building at 401 N. Morton.

We have reviewed the drawings, site plan, and, variance petition statement submitted by our driveway-sharing neighbors to the west of us, Malcolm Dalglish & Judy Klein, 1111 East Wylie St. (015-03940-00 Hawthorne Lot 6)

We have had many a brainstorm with experts consulting over a variety of driveway plans this past year addressing problems with drainage, safety, driveway width, age-in-place accessibility and aesthetics. We are very much in support of this project and stand to benefit immensely for the following reasons:

-Our useless shared narrow driveway will be widened allowing passage of vehicles and bicycles from both houses to and from the street without being blocked or incurring damage to our vehicles.

-We will both have off street parking and theirs will be sheltered adding safety to their elderly years.


-The new grade and design will divert drainage from our driveway and 3 neighboring houses rather than into our basements.


-The translucent polycarbonate roofing they propose will be a far more attractive than looking down from our windows on asphalt shingles or glaring metal. This material offers visibility to the beautifully crafted substructure as well as sunlight to the plantings in the rear of the driveway.

-Our houses are very close to each other and yet this design does not impinge upon our space any more than their current rock retaining wall. We appreciate that despite this close proximity, we may both enjoy privacy and natural light without darkening our homes with opaque roofing or window curtains.


Lastly we love having Judy and Malcolm as neighbors and are grateful to them for this ingenious design that we may both enjoy for many years to come.


Sincerely, Norlott Asa Palley and Charlotte Agger

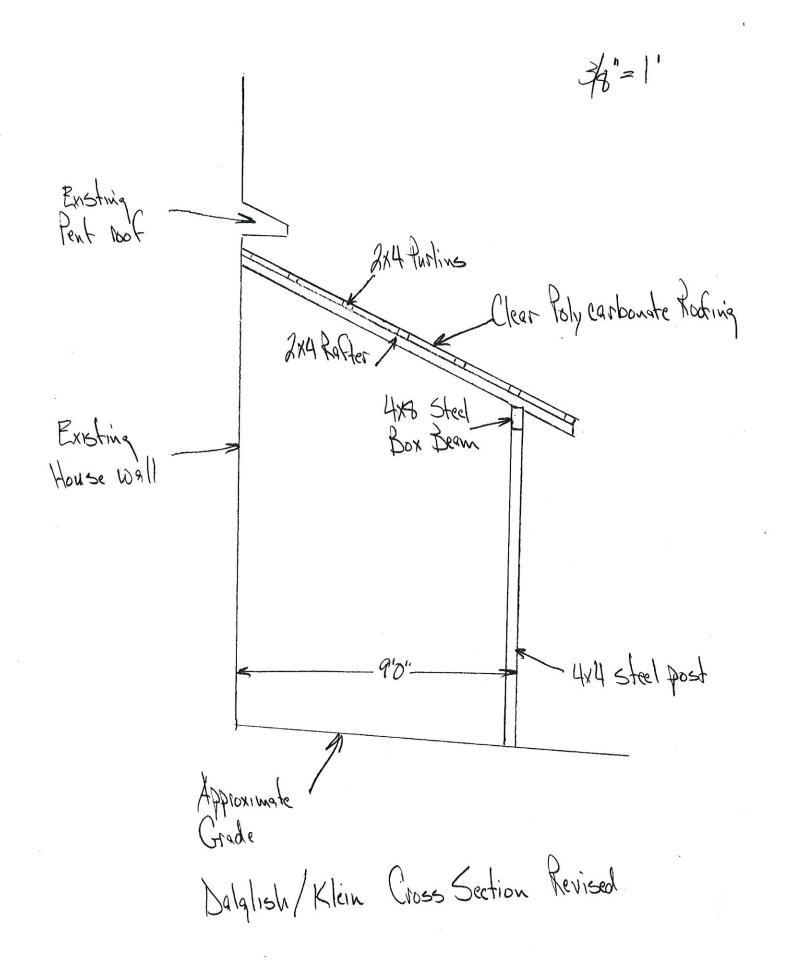


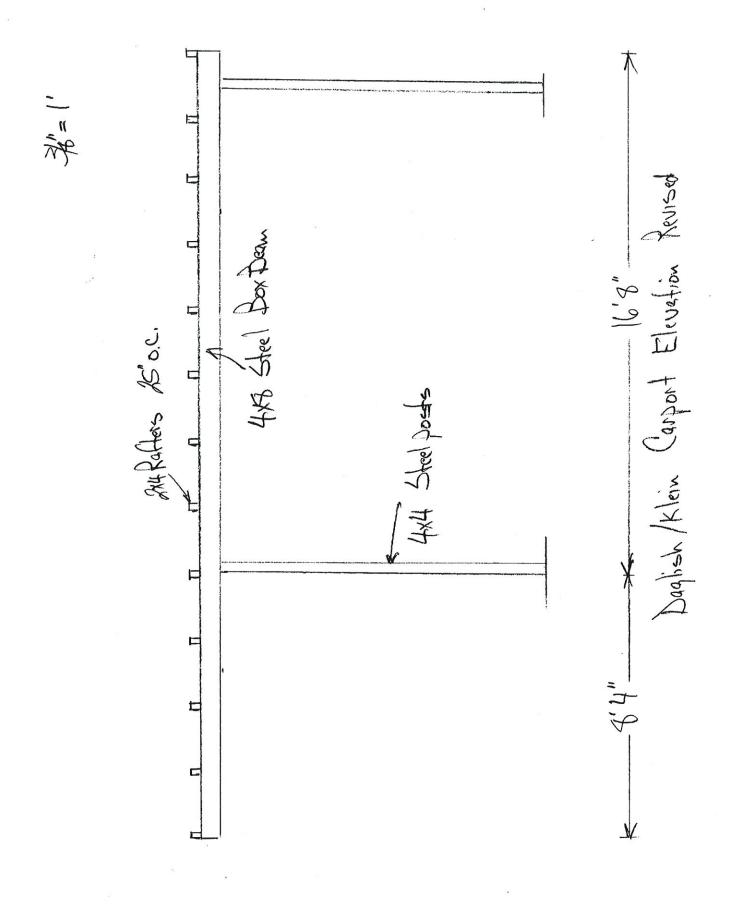

a.

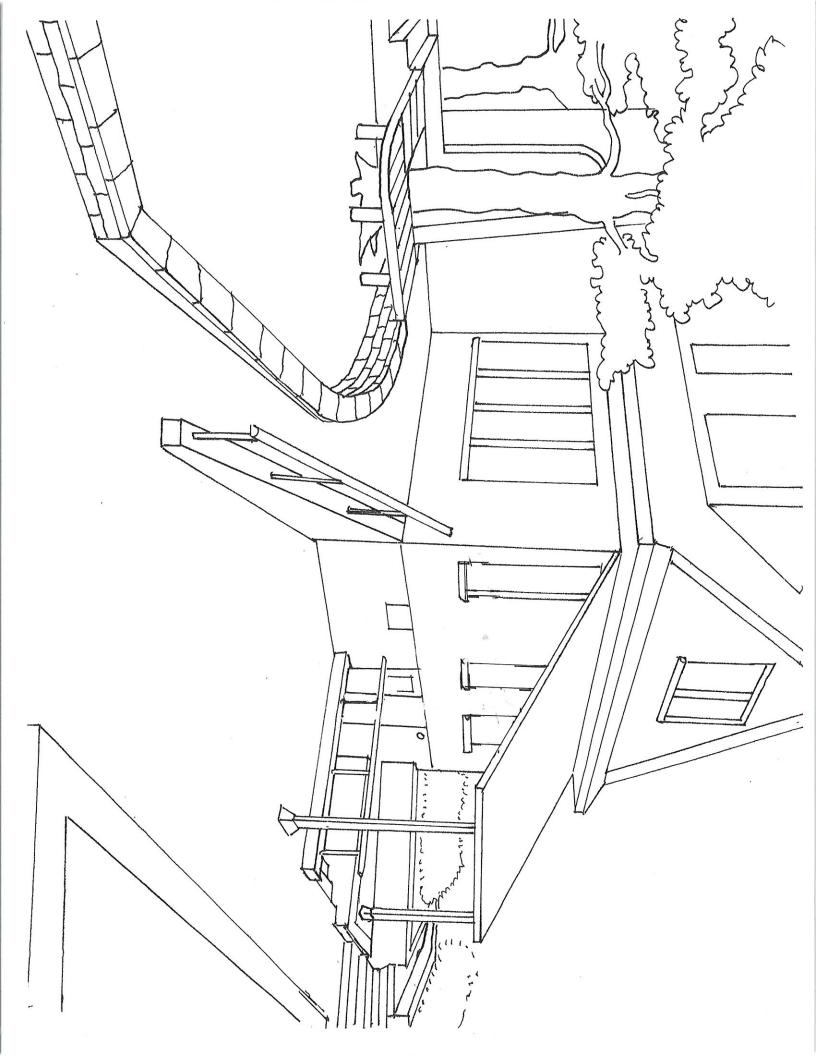

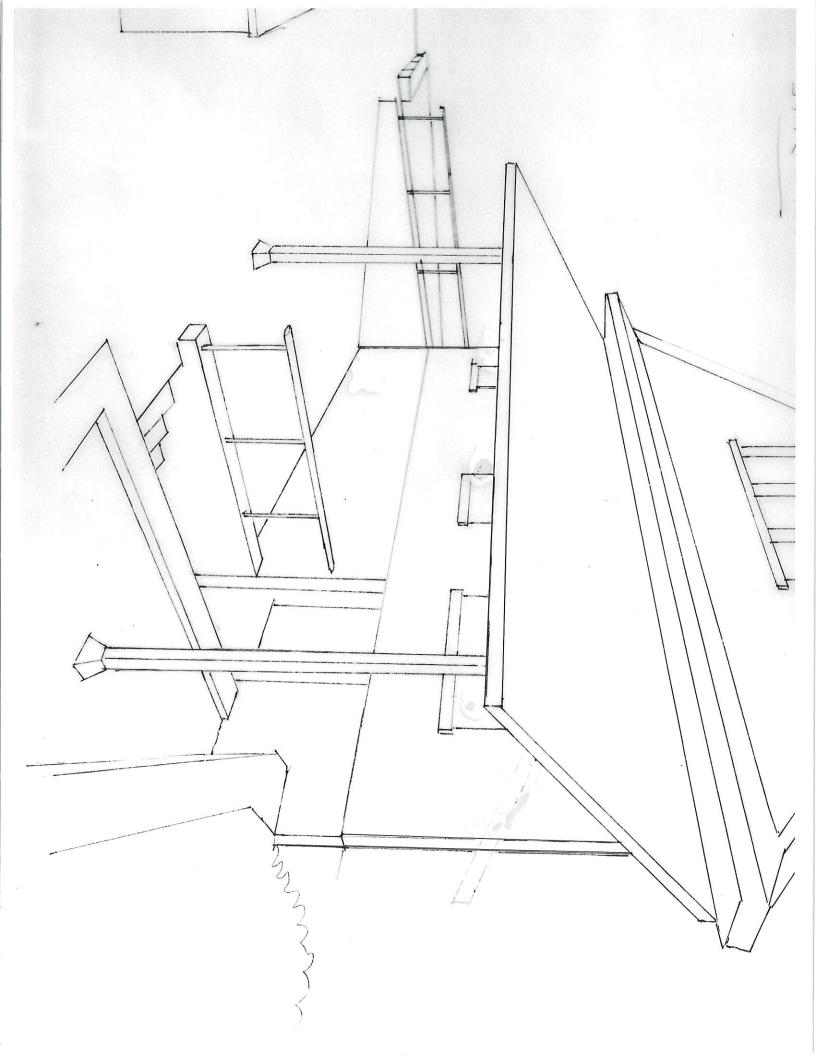

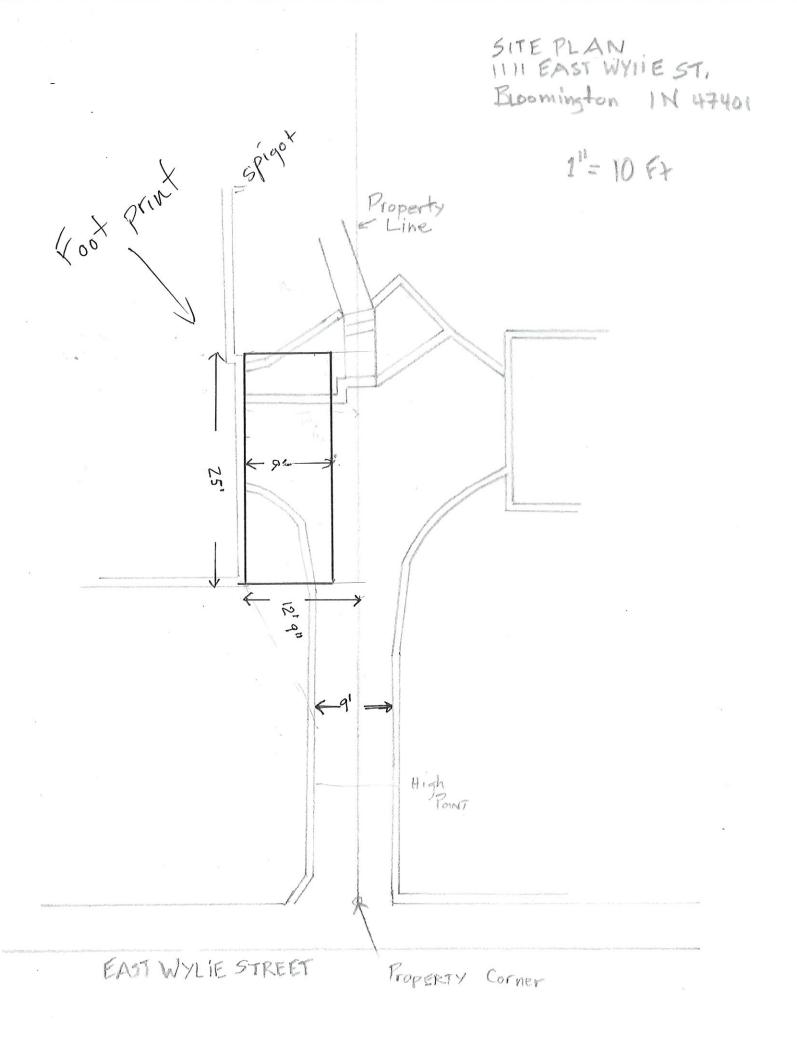

# COA: 19-11

(continued)

Address: <u>512 W. Howe</u> Petitioner: Matthew Francisco & Selma Sabanovic Parcel #: 53-08-04-117-004.000-009

## Property is New Infill

Circa. 2011



- *Background:* Built in 2011 in the Greater Prospect Hill Historic District, the primary structure on this lot was designed to reflect the Gable Ell form.
- *Request*: Construct a 400sqft garage with a 322sqft ADU unit on the second floor. This will be sited on the back of the lot with a gravel driveway connecting the structure to W. Smith Avenue.

## Staff Decision: Staff recommends approval of COA 19-11 for the following reasons:

- 1. The petitioner has addressed the concerns raised by the HPC at the 2/28/19 These changes are reflected in the new design. (see packet)
- 2. The north elevation (facing Smith Ave) now has the appearance of a house front.
- 3. The structure has been moved 2ft to the east.





519 W Smith East Elevation View - Looking from ADU/Garage Site


3-15-2019





519 W Smith 3-15-2019 View from North - Looking from Smith Ave @ East Property Line

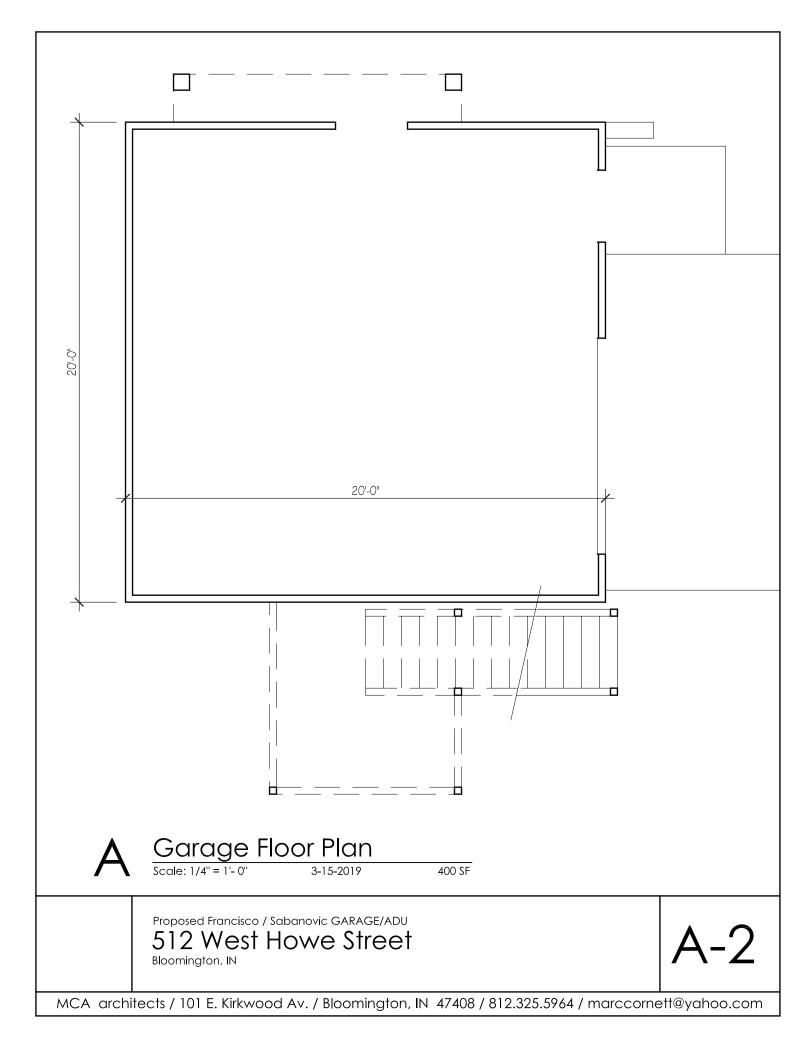

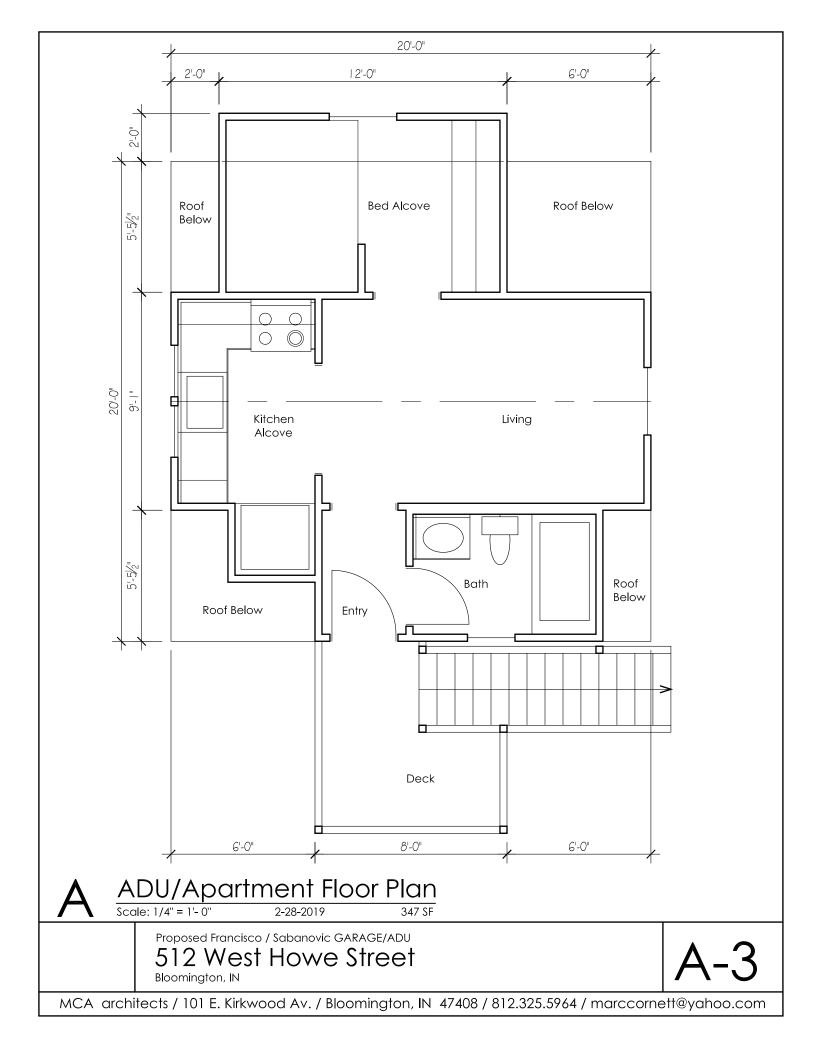

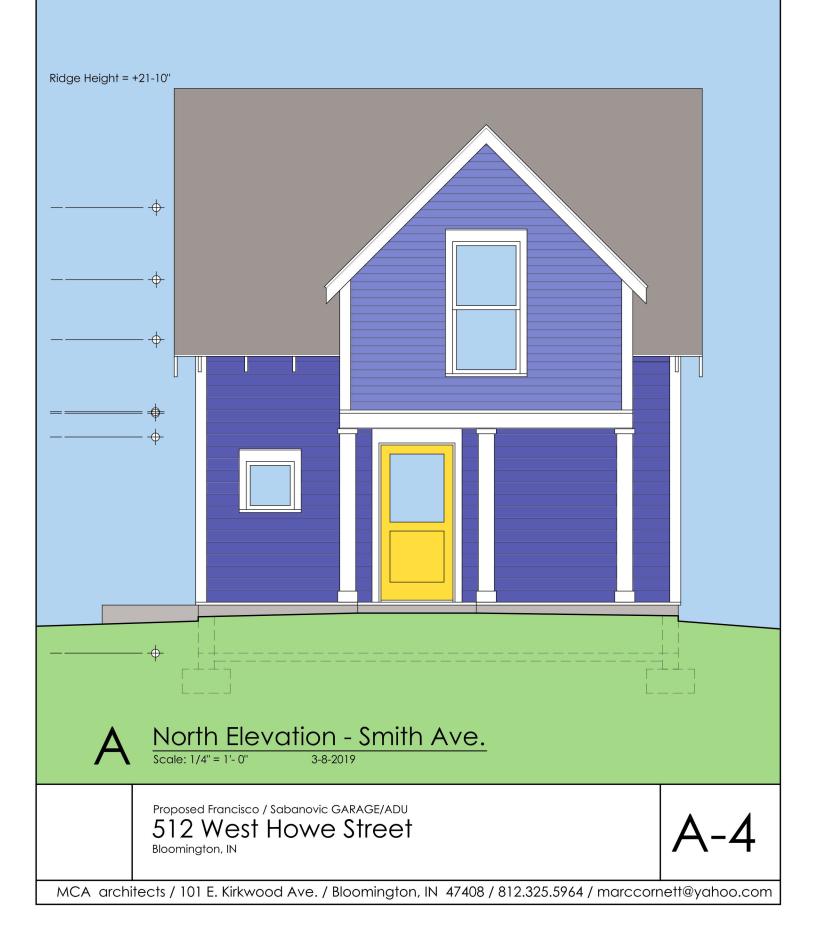

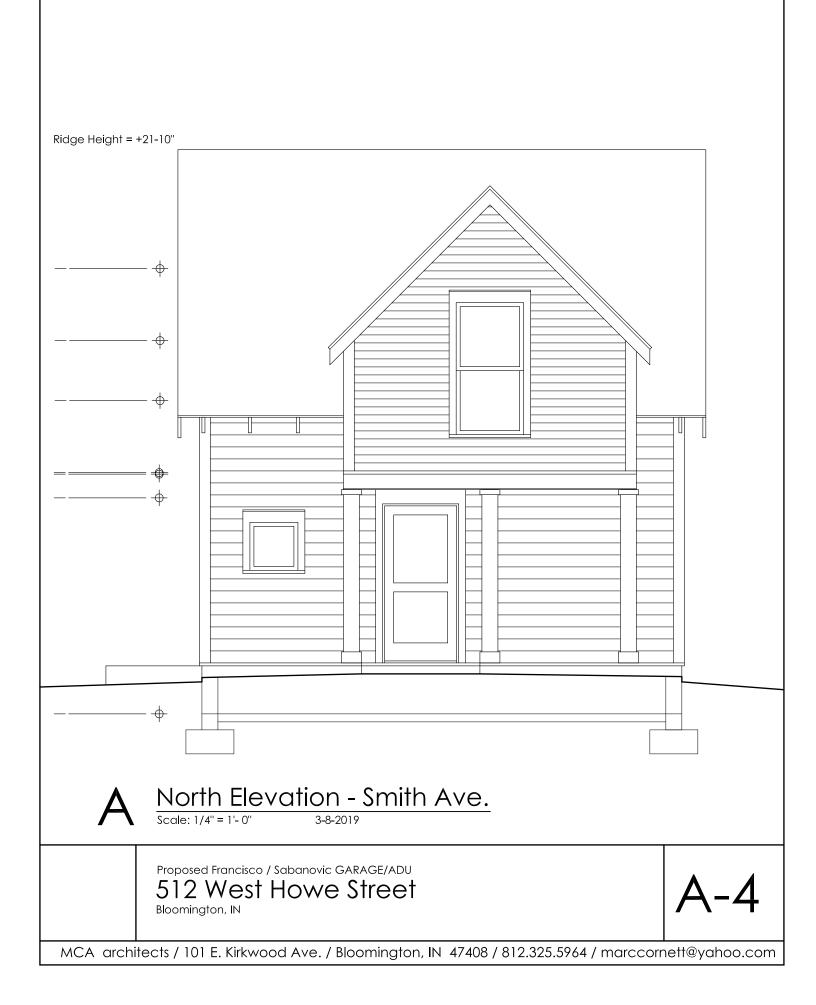

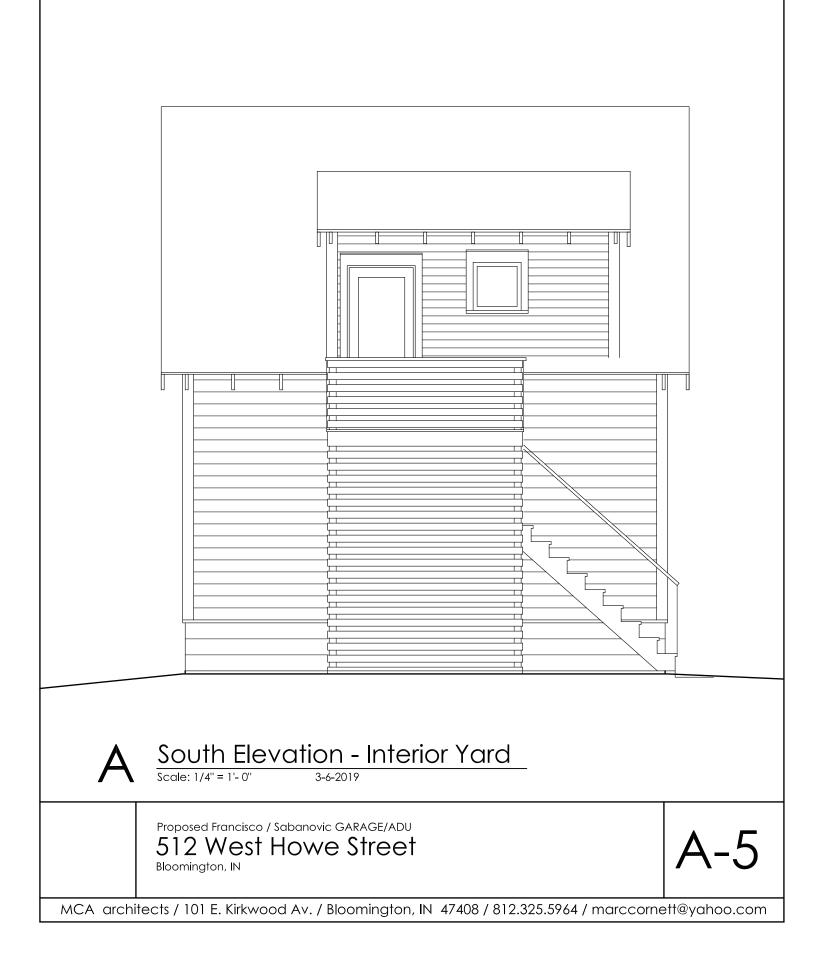



Foundation: 8" CMU block, to match main house Siding: Cement composite lap siding, painted, 4" and 6" exposure, to match main house Trim: Composite or cedar, painted, 4" and 6" profiles, to match main house Windows: Double-hung and Awning, to match main house Doors: to match main house Stairwell: KDAT treated wood or cedar, painted, (corn-crib skip board look) Exposed Rafter Tails: KDAT or cedar, to match main house Roofina: Asphalt Shinales, 3-tab, to match main house


Proposed Grade

Scale: 1/4" = 1'- 0" 3-6-2019


Proposed Francisco / Sabanovic GARAGE/ADU 512 West Howe Street Bloomington, IN


A-7

MCA architects / 101 E. Kirkwood Av. / Bloomington, IN 47408 / 812.325.5964 / marccornett@yahoo.com

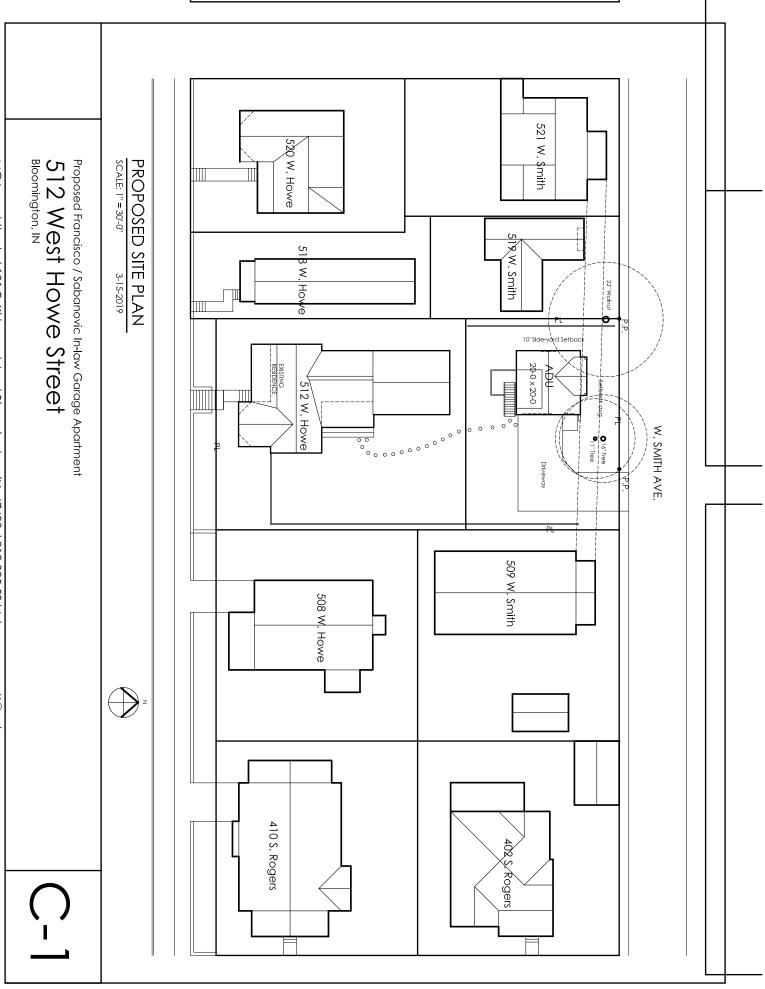

MCA architects / 101 E. Kirkwood Av. / Bloomington, IN 47408 / 812.325.5964 / marccornett@yahoo.com

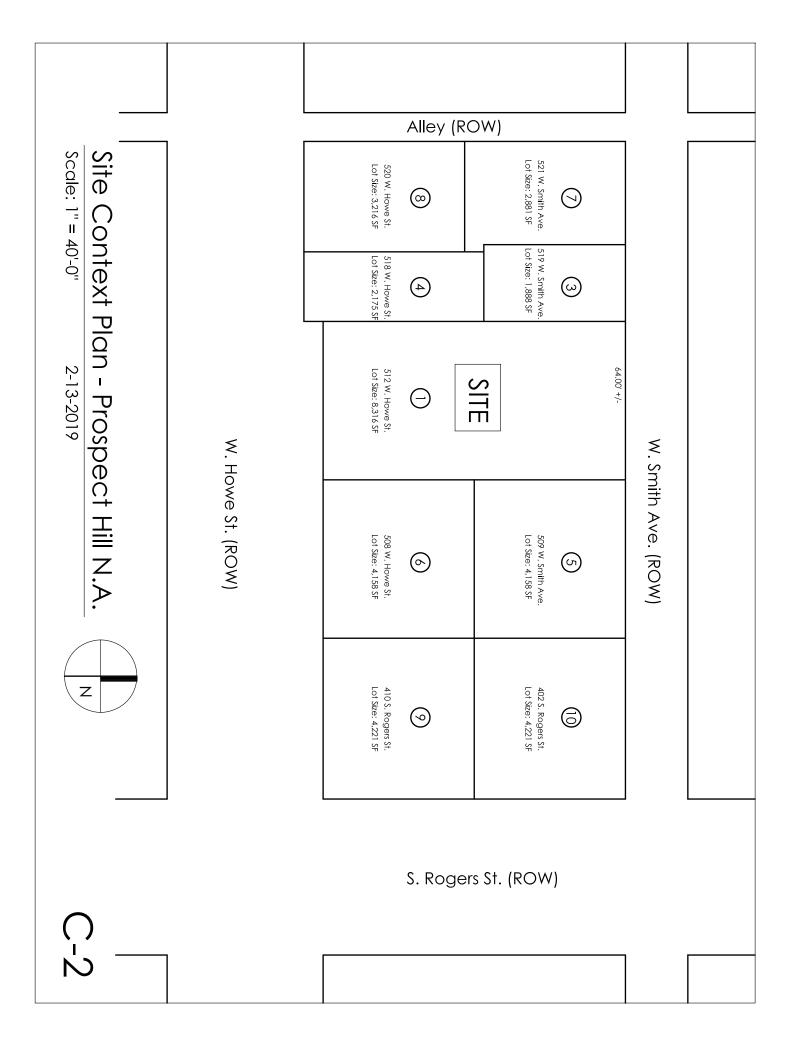

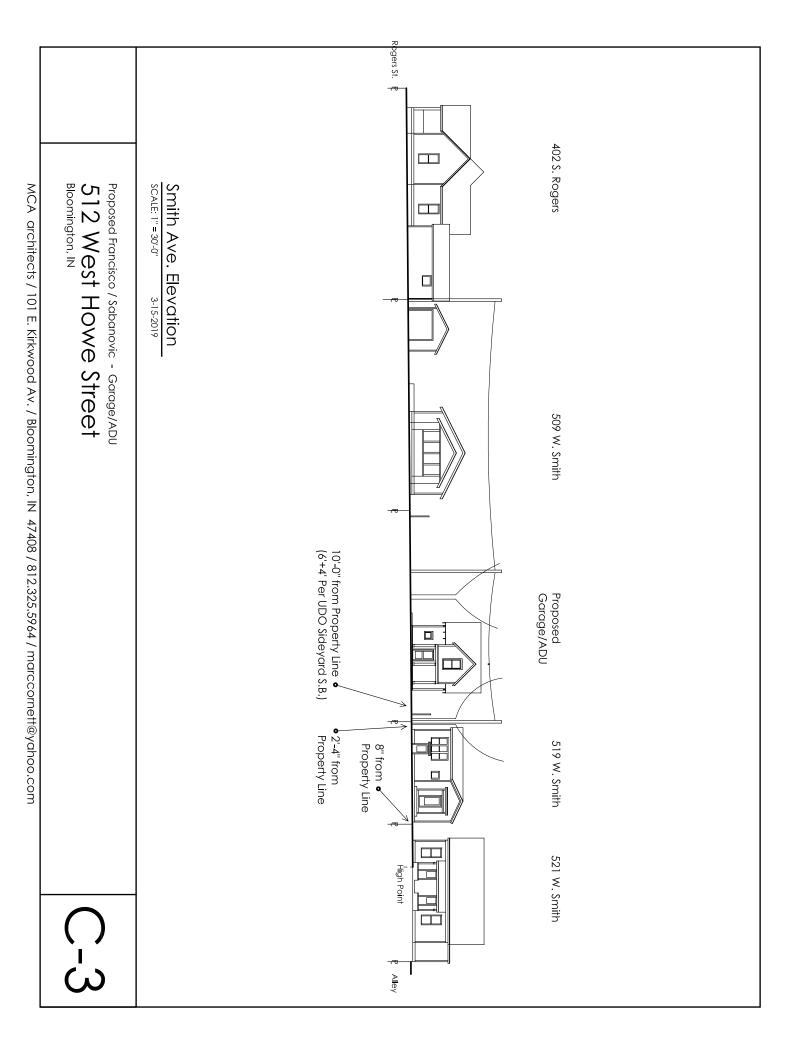

## COA: 19-12

Address: <u>1003W. Howe</u> Petitioner: Chris Sturbaum (Golden Hands Construction) Parcel #: 53-08-05-111-019.000-009

### Property is **Contributing**

Circa. <u>1905</u>



- *Background:* Built circa 1905 in the Greater Prospect Hill Historic District, this is a slightly altered T-Plan Cottage.
- *Request*: Add two one story additions to the rear of the house. One addition will provide added living space while the other is a garage. Both additions roughly 500sqft.
- Guidelines Greater Prospect Hill Design Guidelines pg. 23 Additions Guidelines follow the New Construction Guidelines with the following exceptions:
  - 1. Materials Exception: Use of materials currently on the existing structure can be continued on the Addition.
  - 2. Building Outline and Mass Exception: Excessive impact to the public way façade should be discouraged.
  - 3. Fenestration\* Exception: Increased design flexibility for additions on nonpublic way façades may be considered.

### Staff Decision: Staff recommends approval of COA 19-12 for the following reasons:

- 1. The additions, while large, are to the rear of the home. Excluding alleys, the addition will only be visible from one vantage point on 2nd Street.
- 2. Both the siding and the roof silhouette on the addition are compatible with the primary structure.

#### APPLICATION FORM CERTIFICATE OF APPROPRIATENESS

Case Number:	COA	19-12	75
Date Filed:	3,	16/19	
Scheduled for Hearin	g:?	128/19	

#### Instructions to Petitioners

The petitioner must attend a preliminary meeting with staff of the Department of Housing and Neighborhood Development during which the petitioner will be advised as to the appropriateness of the request and the process of obtaining a Certificate of Appropriateness. The petitioner must file a "complete application" with Housing and Neighborhood Department Staff no later than seven days before a scheduled regular meeting. The Historic Preservation Commission meets the second Thursday of each month at 5:00 P.M. in the McCloskey Room. The petitioner or his designee must attend the scheduled meeting in order to answer any questions or supply supporting material. You will be notified of the Commission's decision and a Certificate of Appropriateness will be issued to you. Copies of the Certificate must accompany any building permit application subsequently filed for the work described. If you feel uncertain of the merits of your petition, you also have the right to attend a preliminary hearing, which will allow you to discuss the proposal with the Commission before the hearing during which action is taken. Action on a filing must occur within thirty days of the filing date, unless a preliminary hearing is requested.

Please respond to the following questions and attach additional pages for photographs, drawings, surveys as requested.

A "Complete Application" consists of the following:

1. A legal description of the lot. Lo # Weavers Addition

2. A description of the nature of the proposed modifications or new construction:

3. A description of the materials used.


4. Attach a drawing or provide a picture of the proposed modifications. You may use manufacturer's brochures if appropriate.

5. Include a scaled drawing, survey or geographic information system map showing the footprint of the existing structure and adjacent thoroughfares, Geographic Information System maps may be provided by staff if requested. Show this document to Planning Department Staff in order to ascertain whether variances or zoning actions are required.


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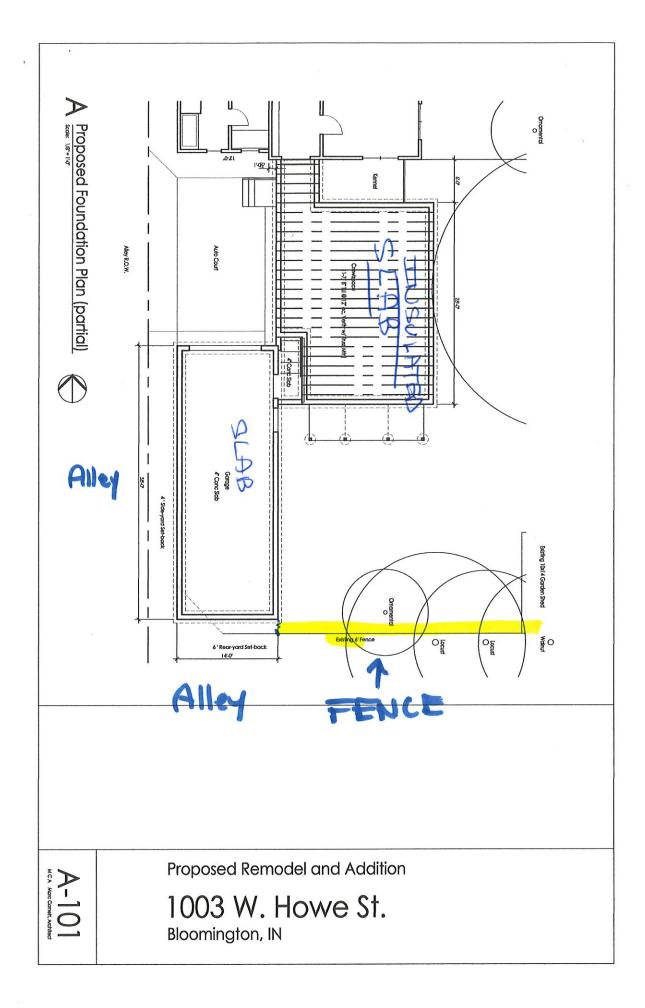
#### \*\*\*\*\*\*

If this application is part of a further submittal to the Board of Zoning Appeals for a Conditional Use or development standard variance, please describe the use proposed and modification to the property which will result.




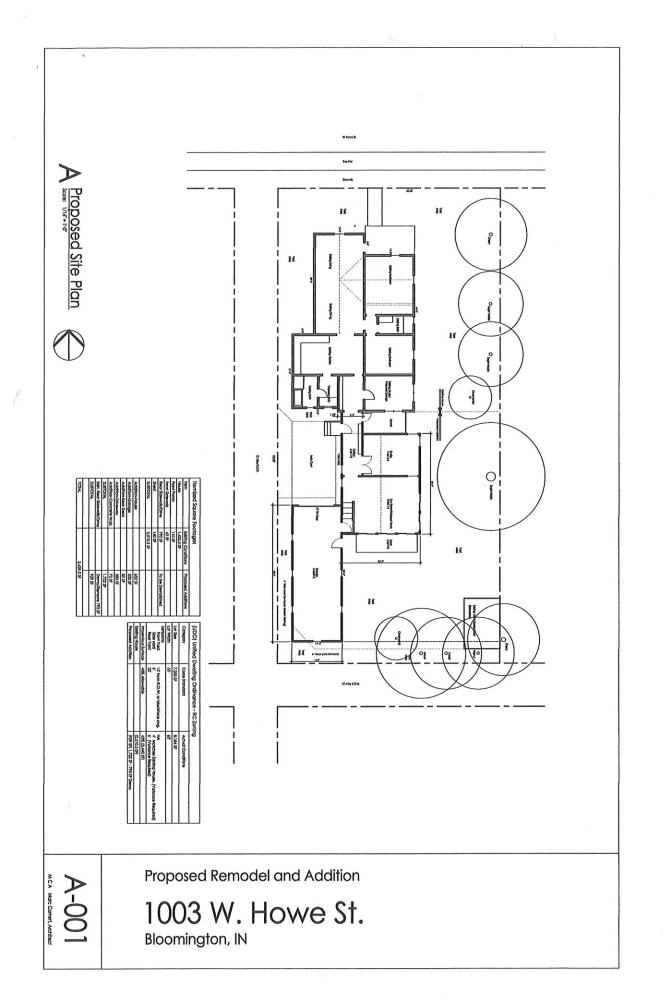




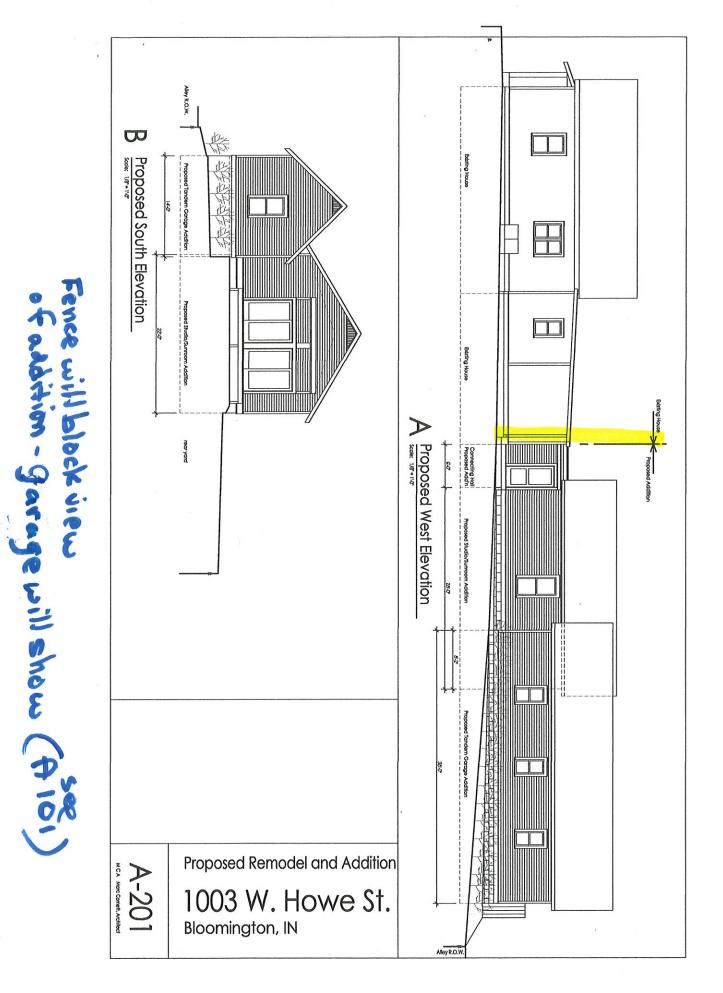



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### LINE ITEM QUOTES

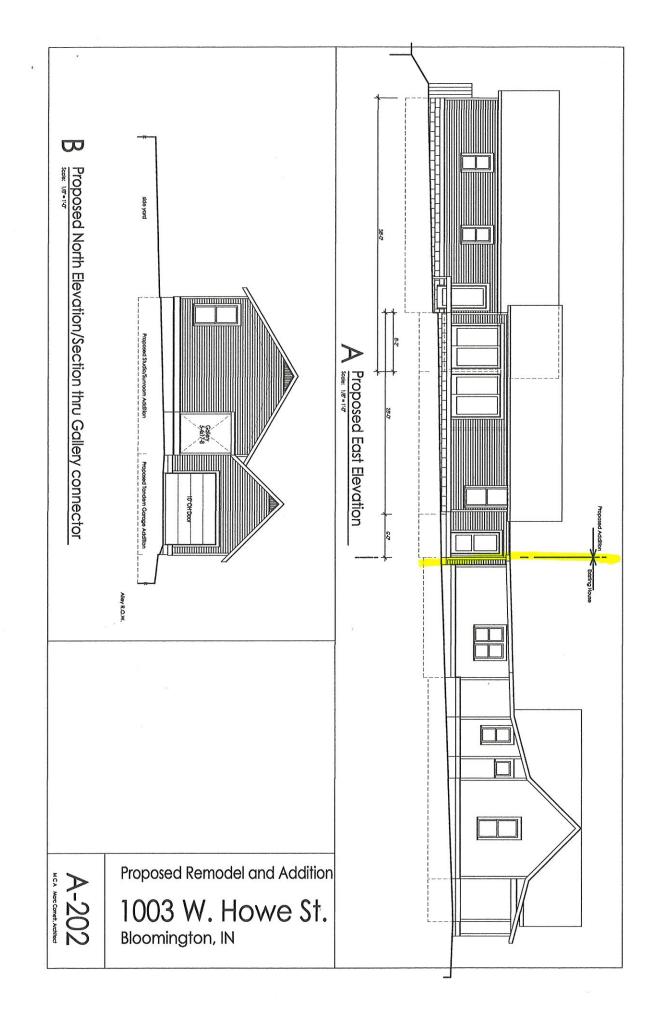The following is a schedule of the windows and doors for this project. For additional unit details, please see Line Item Quotes. Additional charges, tax or Terms and Conditions may apply. Detail pricing is per unit.


	Not Driver		567.60
Mark Unit: 3060 DH-EXTERIOR WALL	Net Price:		2,270.40
Stone White Exterior	EXI. Net Price.	030	2,270.40
Bare Pine Interior	••••••	•••••	
Stone White Ext - White Int Bottom Sash IG		•••••	53.54
GBG Rectangular - Standard Cut 3W3H Stone White Ext - White Int Almond Frost Sash Lock			
he Stone White Surround Charcoal Fiberglass Mesh			
Nailing Fin	•••••	•••••	31.61
	Net Price:		536.00
Stone White Exterior	Ext. Net Price: j	050	1,072.00
Bare Pine Interior Integrity Traditional Double Hung Wood-Ultrex CN 3672 Rough Opening 36 1/2" X 72 1/4" Top Sash IG Low E2 w/Argon GBG Rectangular - Standard Cut 3W3H Stone White Ext - White Int Bottom Sash IG Low E2 w/Argon GBG Rectangular - Standard Cut 3W3H Stone White Ext - White Int Almond Frost Sash Lock			53.54
	Integrity Traditional Double Hung Wood-Ultrex CN 3672 Rough Opening 36 3/4" X 72 3/8" Top Sash IG Low E2 w/Argon GBG, Rectangular - Standard Cut 3W3H Stone White Ext - White Int Bottom Sash IG Low E2 w/Argon GBG, Rectangular - Standard Cut 3W3H Stone White Ext - White Int Almond Frost Sash Lock Exterior Aluminum Screen, Nailing Fin ***Note: Divided lite cut alignment may n your local representative for exact specifica Mark Unit: 3060 DH-INTERIOR WALLS Stone White Exterior Bare Pine Interior Integrity Traditional Double Hung Wood-Ultrex CN 3672 Rough Opening 36 1/2" X 72 1/4" Top Sash IG Low E2 w/Argon GBG, Rectangular - Standard Cut 3W3H Stone White Ext - White Int Bottom Sash IG Low E2 w/Argon GBG, Rectangular - Standard Cut 3W3H Stone White Ext - White Int Bottom Sash IG Low E2 w/Argon GBG, Rectangular - Standard Cut 3W3H Stone White Ext - White Int Bottom Sash IG Low E2 w/Argon GBG, Rectangular - Standard Cut 3W3H Stone White Ext - White Int Bottom Sash IG Low E2 w/Argon GBG, Rectangular - Standard Cut 3W3H Stone White Ext - White Int Bottom Sash IG Low E2 w/Argon GBG, Rectangular - Standard Cut 3W3H Stone White Ext - White Int Bottom Sash IG Low E2 w/Argon GBG, Rectangular - Standard Cut 3W3H Stone White Ext - White Int Almond Frost Sash Lock Exterior Aluminum Screen, Stone White Surround	Bare Pine Interior Integrity Traditional Double Hung Wood-Ultrex         CN 3672         Rough Opening 36 3/4" X 72 3/8" Top Sash IG         Top Sash IG         Not E2 w/Argon         GBG         Rectangular - Standard Cut 3W3H Stone White Ext - White Int Bottom Sash IG         IG         Low E2 w/Argon         GBG         Cow E2 w/Argon         GBG         Low E2 w/Argon         GBG         Netter Standard Cut 3W3H Stone White Ext - White Int Almond Frost Sash Lock         Exterior Aluminum Screen,         Naling Fin         ****Note: Divided lite cut alignment may not be accurately represente your local representative for exact specifications.         Mark Unit: 3060 DH-INTERIOR WALLS       Net Price: Ext. Net Price:         Stone White Exterior Bare Pine Interior Integrity Traditional Double Hung       Wood-Ultrex         CN 3672       Rough Opening 36 1/2" X 72 1/4" Top Sash IG       IG         Low E2 w/Argon       GBG, Low E2 w/Argon       GBG, Rectangular - Standard Cut 3W3H Stone White Ext - White Int Bottom Sash IG         Low E2 w/Argon       GBG, Low E2 w/Argon       GBG, Low E2 w/Argon         GBG,       Low E2 w/Argon       GBG, Low E2 w/Argon         GBG,       Low E2 w/Argon       GBG, Low E2 w/Argon         GBG,	Stone White Exterior Bare Pine Interior Integrity Traditional Double Hung Wood-Ultrex CN 3672 Rough Opening 36 3/4" X 72 3/8" Top Sash G Low E2 w/Argon GBG

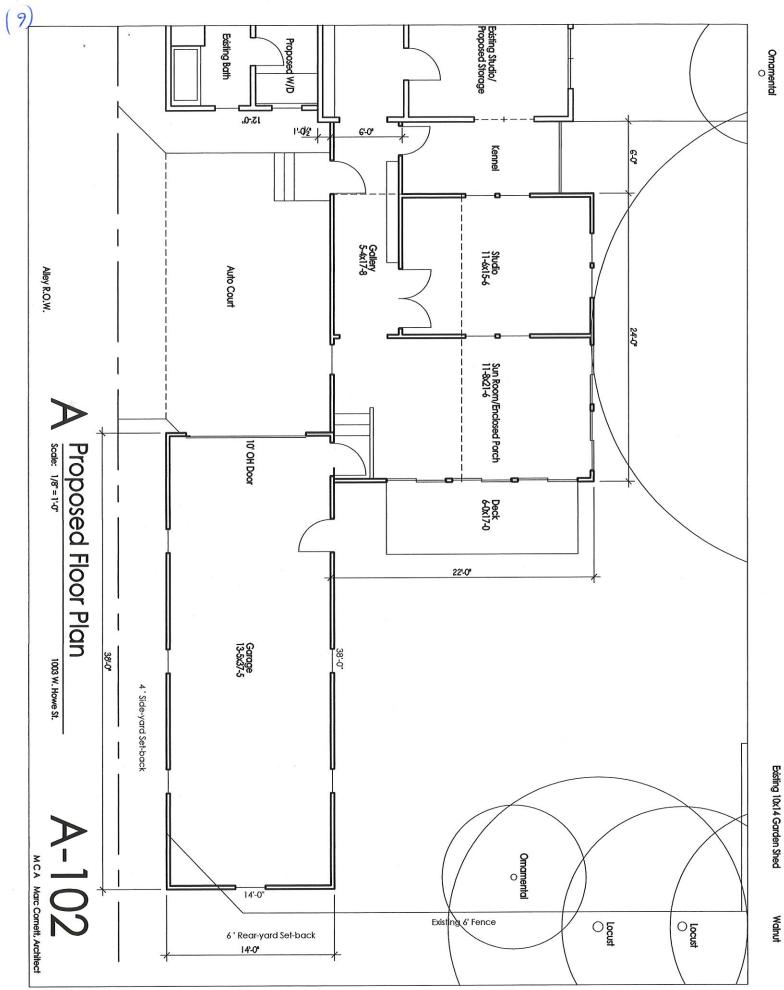Line #3	Mark Unit: B AWNING	Net Price:		305.08
Qty: 2		Ext. Net Price:	USD	610.16

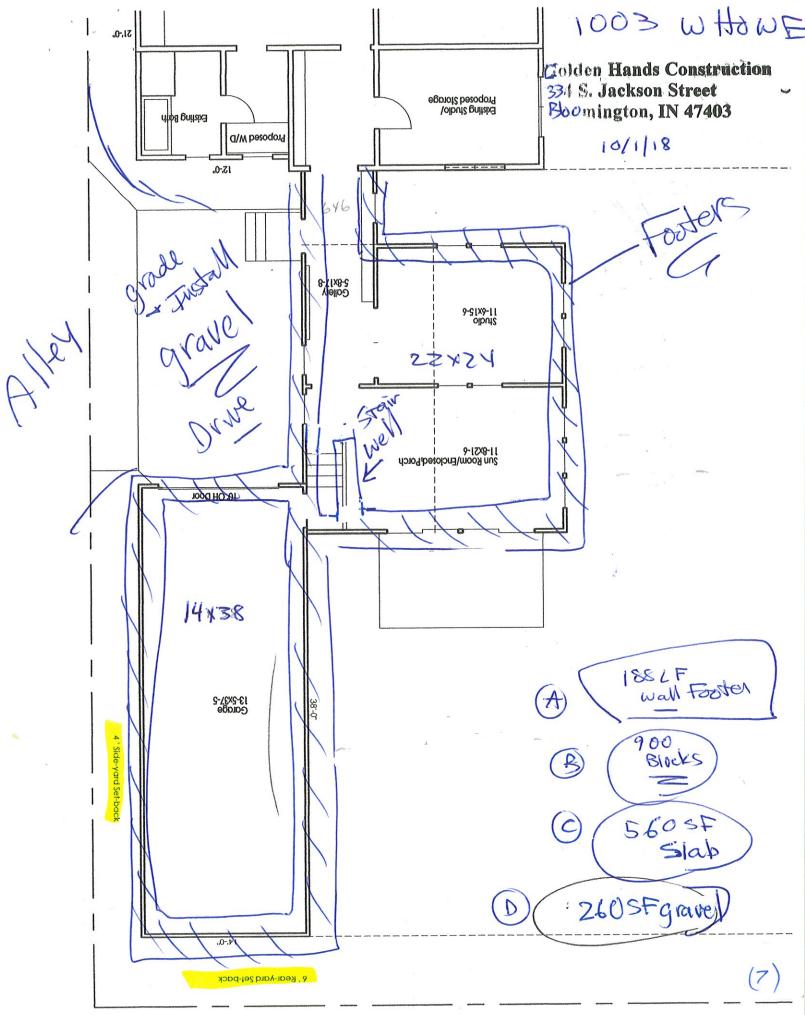OMS Ver. 0002.22.00 (Current)

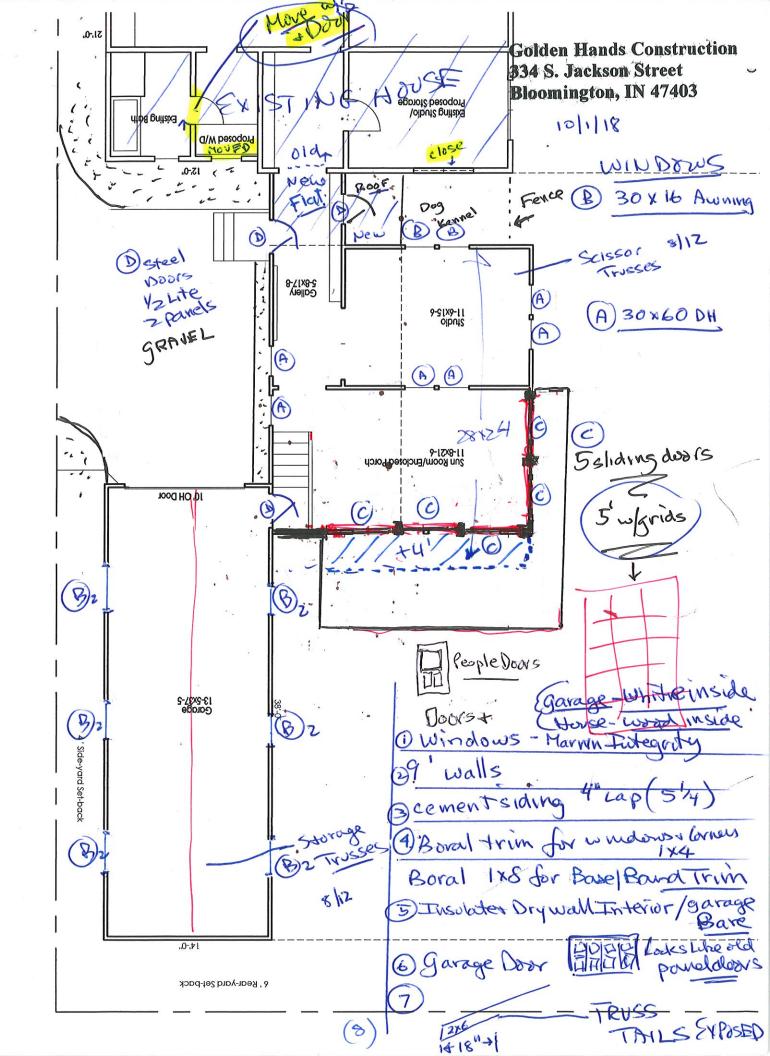Page 2 of 5

OMS Ver. 0002.22.00 (Current) Product availability and pricing subject to change.

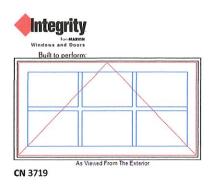

Stone White Exterior
Bare Pine Interior
Integrity Awning - Roto Operating 236.72
Wood-Ultrex
CN 3719
Rough Opening 37" X 19 5/8"
IG
Low E2 w/Argon
GBG
Rectangular - Standard Cut 3W2H
Stone White Ext - White Int
Almond Frost Folding Handle
Interior Aluminum Screen
Charcoal Fiberglass Mesh
Almond Frost Surround
6 9/16" Jambs
Nailing Fin

Nailing Fin \*\*\*Note: Divided lite cut alignment may not be accurately represented in the OMS drawing. Please consult your local representative for exact specifications.

Line #4	Mark Unit: GARAGE AWNINGS	Net Price:		323.79
Qty: 6		Ext. Net Price:	USD	1,942.74
Untegrity	Stone White Exterior White Interior Integrity Awning - Roto Operating Wood-Ultrex			
	CN 3719 Rough Opening 37" X 19 5/8" IG Low E2 w/Argon			
	GBG Rectangular - Standard Cut 3W2H Stone White Ext - White Int White Folding Handle			
As Viewe CN 3719	ed From The Exterior Charcoal Fiberglass Mesh	••••••	• • • • • • • • • •	
	White Surround 4 9/16" Jambs Nailing Fin			
	***Note: Divided lite cut alignment ma	v not be accurately represente	d in the OMS	drawing. Please consult

Divided lite cut alignment may not be accurately represented in the OMS drawing. Please consult Note: your local representative for exact specifications.

(		
Line #5	Mark Unit: 5/0 SLIDING DOORS	Net Price: 1,385.46
Qty: 5		Ext. Net Price: USD 6,927.30
	Stone White Exterior Bare Pine Interior	
Windows and Doors	Integrity Sliding Patio Door - O Wood-Ultrex	DX964.28
Built to perform:	CN 5068	
	Rough Opening 60 1/4" X 82 5 Left Panel	5/8"
	IG Tompered Low 52 w	ul Argon
<	Tempered Low E2 w, GBG Rectangular - Standard Stone White Ext - White	89.66 Cut 3W5H
	Right Panel	
	IG	
	Tempered Low E2 w/	v/Argon
	GBG	89.66
	Rectangular - Standard (	Cut 3W5H
	Stone White Ext - White	
Stationary Prin	nary Cambridge SPD Handle Sat	atin Nickel PVD Exterior Primary Handle Set
As Viewed From		atin Nickel PVD Interior Primary Handle Set
	Exterior briding server.	
Exterior CN 5068	Stone White Surround	
BF 59" X 82"	Charcoal Fiberglass Mesh ***Screen/Combo Ship Loo	
DF 33 A 62	Beige Ultrex Sill / Beige Wo	
OMS Ver. 0002.22	00 (Current) Processed on: 10/1/20	2018 12:34:09 PM Page 3 of 5

## **COA: 19-13**

Address: 221 E. Kirkwood

Petitioner: Tim Cover 9 (Studio 3 Design) Parcel #: 53-05-33-310-337.000-005

Property is Contributing

Circa. 1900



- *Background:* Built in the late 1890's, this Queen Anne home has been adapted and used to serve various commercial purposes since the 1930s. The structure was locally designated as a single property historic district in 2000.
- *Request*: 1. Add second story to the one story addition on the north side of the property.2. Raise the wall on the block building addition on the west elevation by 3'.
  - 3. Add seven skylight windows to the existing structure.
  - 4. Fish scale style shingles will replace current shingles on the structure.

5. Repaint cornice frieze and ornamentation on Kirkwood façade and repaint EIFS.

### Staff Decision: Staff approves COA 19-13 for the following reasons:

1. The primary façade on Kirkwood is not being altered with the exception of adding two skylight windows (which staff does not approve).

2. The major proposed alteration to Victoria Towers (addition of one story to existing rear addition) is only visible from Lincoln St. and does not alter the primary façade along Kirkwood. The addition differentiates itself without compromising compatibility. (Similar material pattern to the primary structure but designed to look like carriage house)

3. The addition is subordinate to the primary structure in size and massing.

4. Staff does have concerns about the two proposed skylights on the south elevation.

#### APPLICATION FORM CERTIFICATE OF APPROPRIATENESS

. De

Case Number:	COA	19-13	
Date Filed:	31	12/19	
Scheduled for Hea	ring:	3/28/10	
		*****	
Address of Histori	c Property	". <mark>221 E. K</mark> i	rkwood, Bloomington In.
Petitioner's Name:	Tim (	Cover	
			ad, Indianapolis, In suite 330
Phone Number/e-r	<sub>nail:</sub> 317	7-572-1236,	tcover@studio3design.net
Owner's Name: C	ederv	iew Manag	gement
Owner's Address:	601 N	. College,	Ste 1A, Bloomington, in
Phone Number/e-n	<sub>nail:</sub> 812	2-339-8777	7
	-11		

#### Instructions to Petitioners

The petitioner must attend a preliminary meeting with staff of the Department of Housing and Neighborhood Development during which the petitioner will be advised as to the appropriateness of the request and the process of obtaining a Certificate of Appropriateness. The petitioner must file a "complete application" with Housing and Neighborhood Department Staff no later than seven days before a scheduled regular meeting. The Historic Preservation Commission meets the second Thursday of each month at 5:00 P.M. in the McCloskey Room. The petitioner or his designee must attend the scheduled meeting in order to answer any questions or supply supporting material. You will be notified of the Commission's decision and a Certificate of Appropriateness will be issued to you. Copies of the Certificate must accompany any building permit application subsequently filed for the work described. If you feel uncertain of the merits of your petition, you also have the right to attend a preliminary hearing, which will allow you to discuss the proposal with the Commission before the hearing during which action is taken. Action on a filing must occur within thirty days of the filing date, unless a preliminary hearing is requested.

Please respond to the following questions and attach additional pages for photographs, drawings, surveys as requested.

#### A "Complete Application" consists of the following:

1. A legal description of the lot. 221 E. Kirkwood, Bloomington Indiana. See attached Survey

2. A description of the nature of the proposed modifications or new construction:

The Structure is listed as "notable on Bloomington's locally designated list.

The building currently houses a restaurant on level1 and multiple retail and office uses on level 2

The buildig has been added onto 4 times and the interior has been completely modified for current uses.

We are proposing to modify level 2 and the attic to create 6 apartment units.

We are adding a second floor over a one story addition on the north side of the property

We are raising a portion of a flat roof on a block building addion on the west side approx. 3' to improve interior head height.

We are adding skylights to the roof of the original building to provide natural light for the attic apartments.

3. A description of the materials used.

Cementious wood siding to compliment the existing building, replace existing asphalt shingle

Roofing with new asphalt shinle roofing in similar profile and color (double butt) shingle

Caulk and repaint exterior

and a section

New EPDM rubber roof to replace existing EPDM rubber roofing on flat roof areas.

New vinyl windows at addition level 2, new storefront windows at Level 1 of addition.

New aluminum and glass skylights on roof

See attached drawings and renderings.

4. Attach a drawing or provide a picture of the proposed modifications. You may use manufacturer's brochures if appropriate.

5. Include a scaled drawing, survey or geographic information system map showing the footprint of the existing structure and adjacent thoroughfares, Geographic Information System maps may be provided by staff if requested. Show this document to Planning Department Staff in order to ascertain whether variances or zoning actions are required.

6. Affix at least three photographs showing the existing full facade at each street frontage and the area of modification. If this petition is a proposal for construction of an entirely new structure or accessory building, include photographs of adjacent properties taken from the street exposure.


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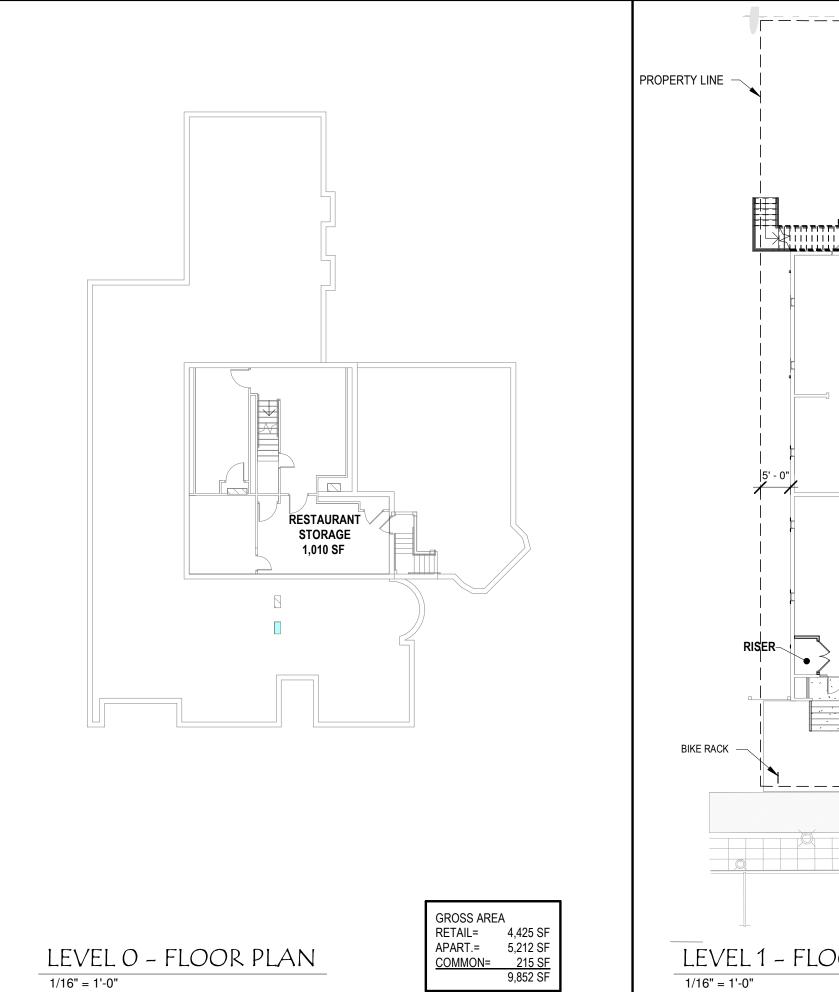













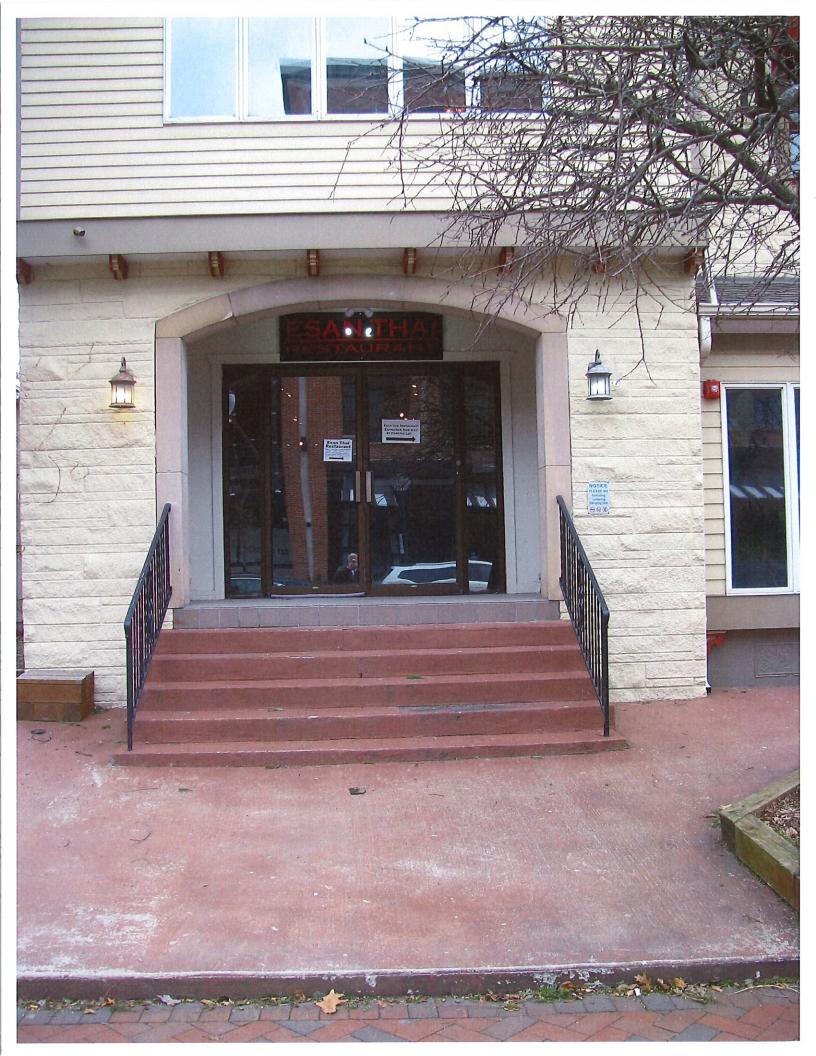

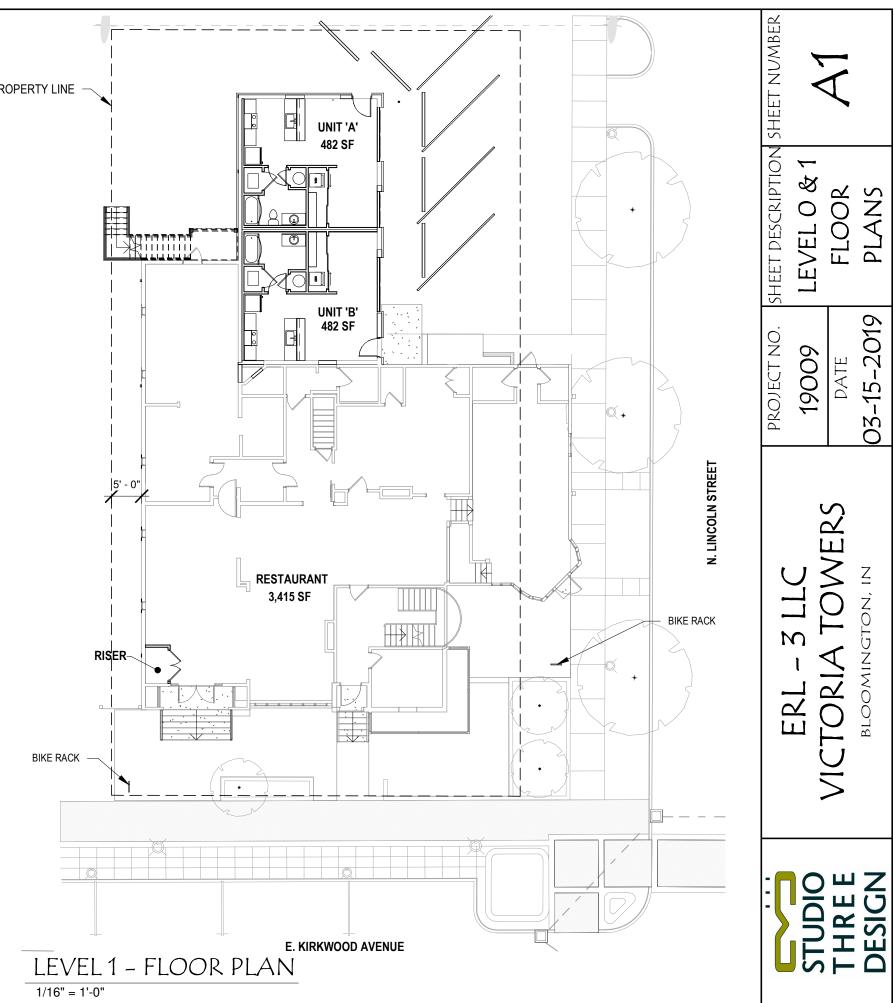


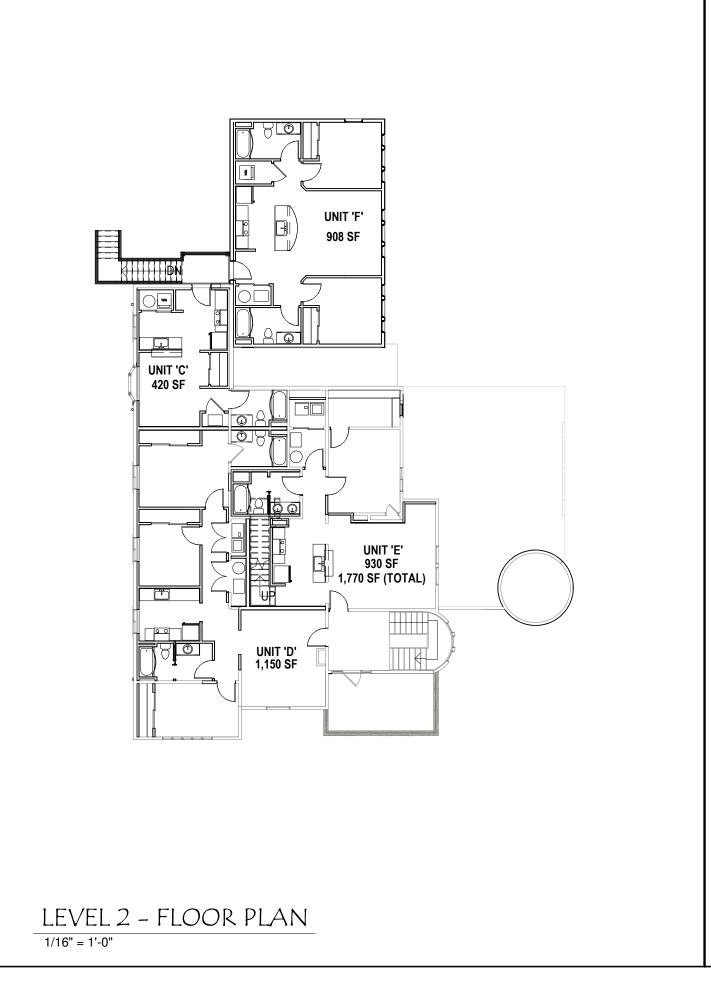

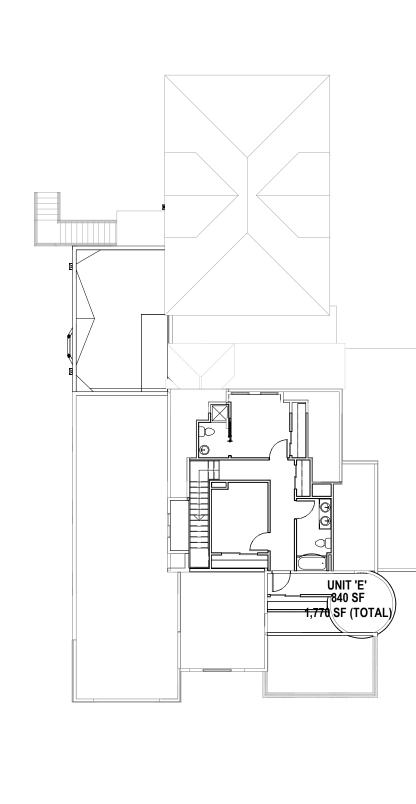


LEVEL 3 - FLOOR PLAN 1/16" = 1'-0"

sheet number A2
PROJECT NO. SHEET DESCRIPTION SHEET NUMBER 19009 LEVEL 2 & 3 DATE FLOOR 3-15-2019 PLAN
PROJECT NO. 19009 DATE 03-15-2019
ERL - 3 LLC VICTORIA TOWERS BLOOMINGTON, IN
STUDIO THREE DESIGN

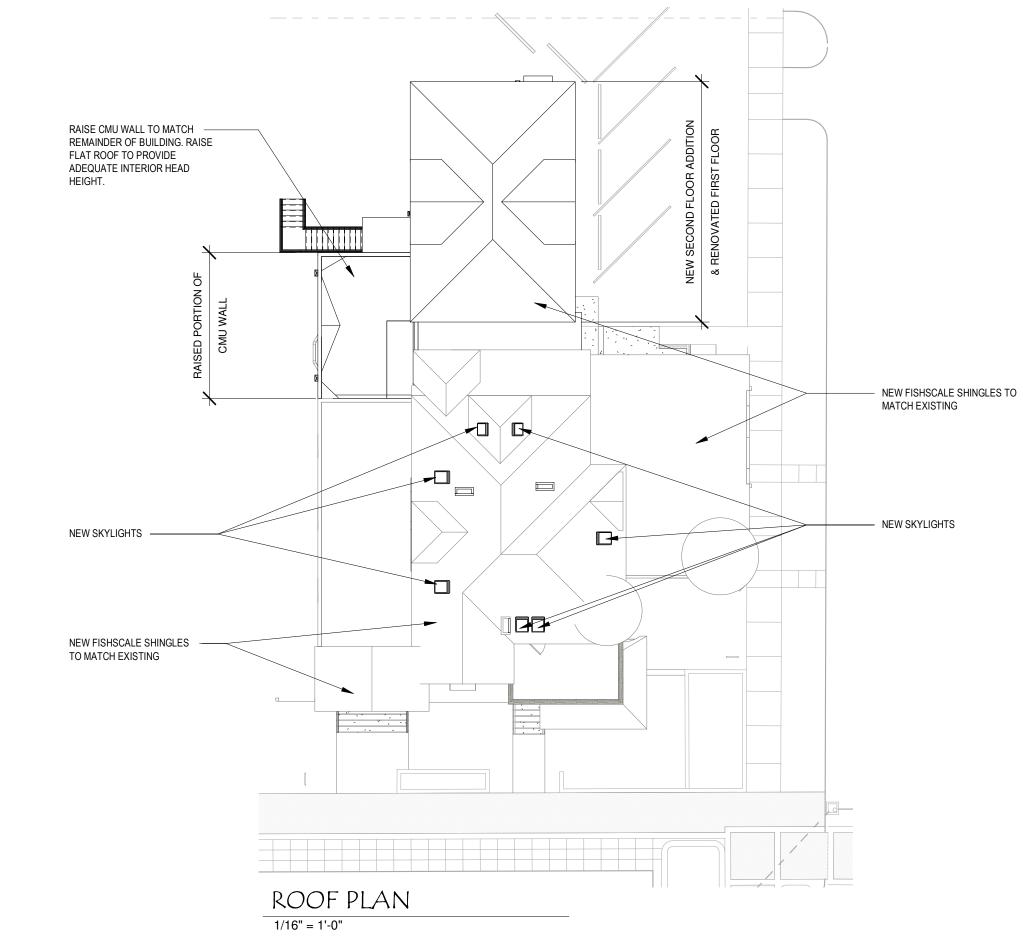


		PROJECT NO.	PROJECT NO. SHEET DESCRIPTION SHEET NUMBER	HEET NUMBER
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THREE	VICIORIA IOWERS	DATE		CK
DESIGN	BLOOMINGTON, IN	03-15-2019		

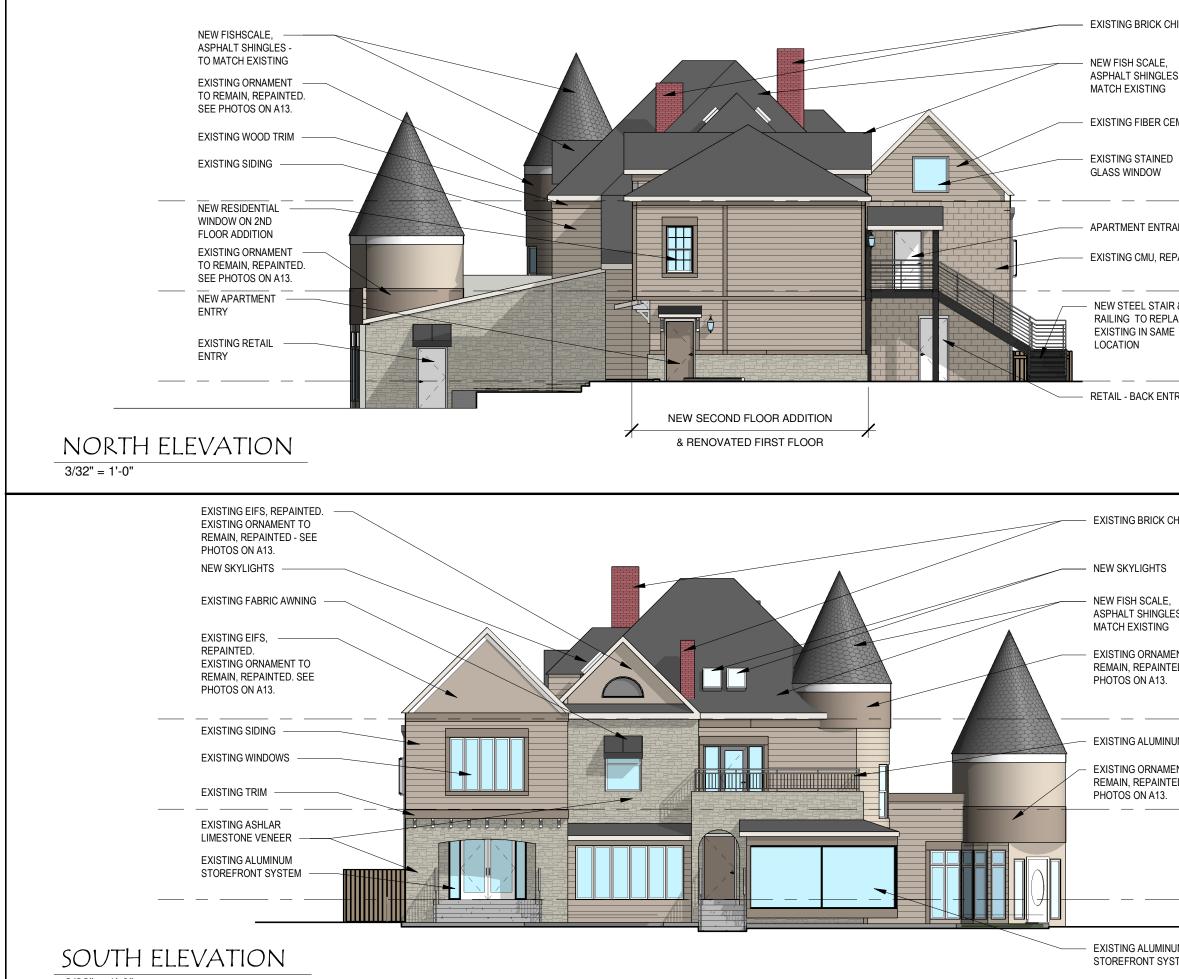


3/32" = 1'-0"

IIMNEY S TO	HEET NUMBER	~ ~	A4	
$\frac{\text{LEVEL 3}}{20' - 0''} \bigoplus$ ANCE PAINTED $\frac{\text{LEVEL 2}}{10' - 0''} \bigoplus$	SHEET DESCRIPTION SHEET NUMBER	NORTH &	SOUTH	03-15-2019   ELEVATIONS
10' - 0"	PROJECT NO.	19009	DATE	03-15-2019
HIMNEY ES TO ENT TO ED. SEE UM RAILING ENT TO ED. SEE				BLOOMING ION, IN
$\underline{LEVEL}_{10'-0"}  $		STUDIO	THREE	DESIGN

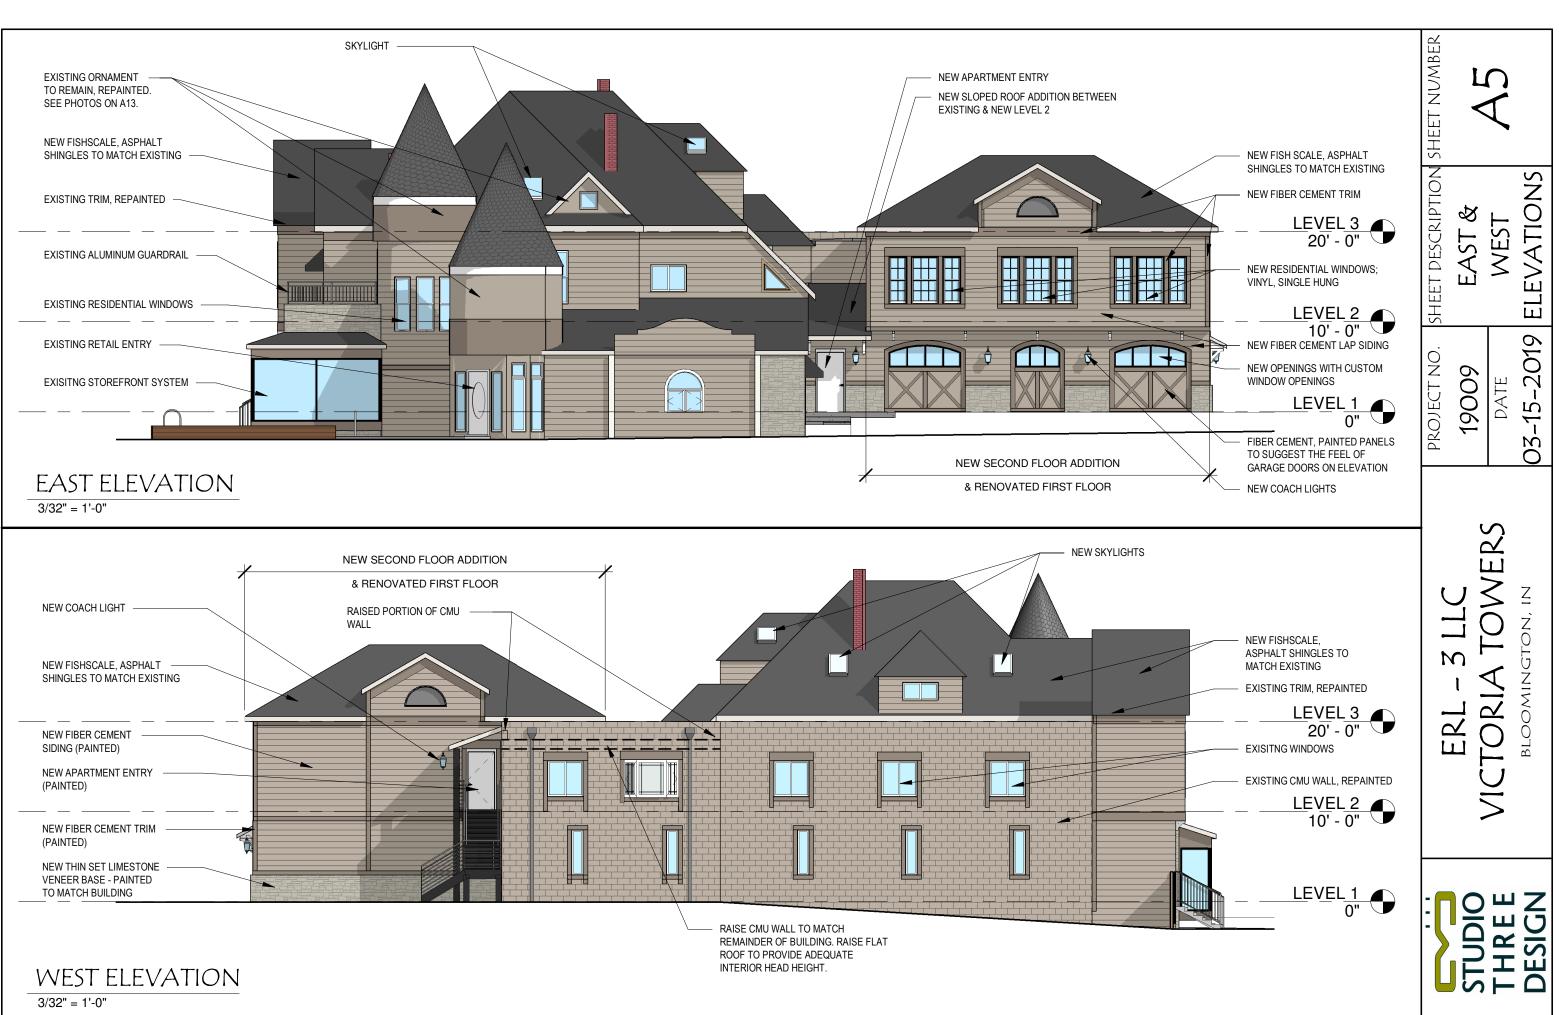



## SE PERSPECTIVE VIEW

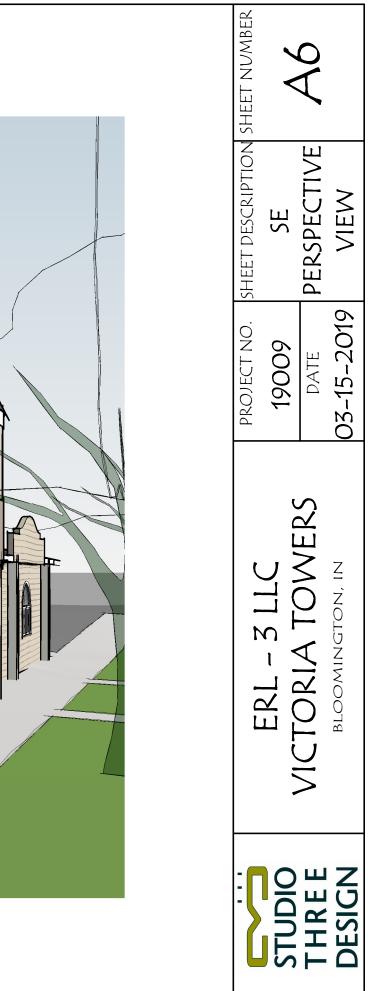



## SW PERSPECTIVE VIEW

	PROJECT NO. SHEET DESCRIPTION SHEET NUMBER		PERSPECTIVE A
	PROJECT NO. SHEET	19009	DATE PER 03-15-2019
			VICIURIA IUWEKS BLOOMINGTON, IN
	-	STUDIO	THREE DESIGN



NE PERSPECTIVE VIEW

HEET NUMBER
PROJECT NO. SHEET DESCRIPTION SHEET NUMBER 19009 NE DATE PERSPECTIVE AB 3-15-2019 VIEW
PROJECT NO. 19009 DATE 03-15-2019
ERL – 3 LLC VICTORIA TOWERS BLOOMINGTON, IN
STUDIO THREE DESIGN






## NW PERSPECTIVE VIEW


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PROJECT NO. 19009 DATE 03-15-2019
ERL – 3 LLC VICTORIA TOWERS BLOOMINGTON, IN
STUDIO THREE DESIGN



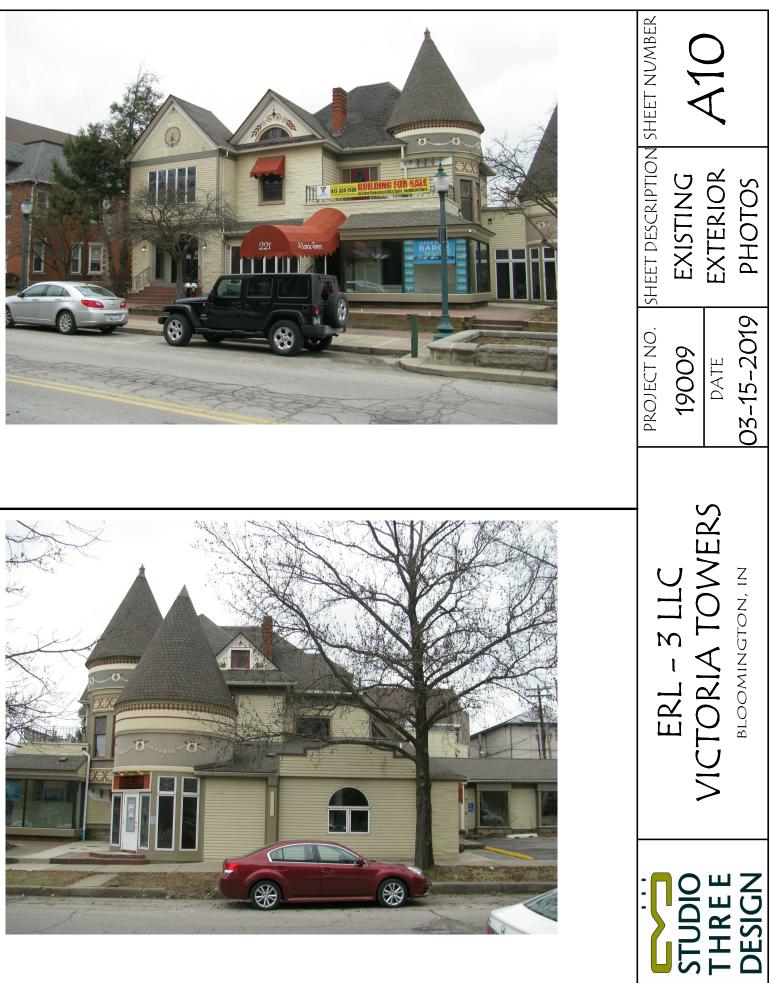


# **EXISTING SOUTH ELEVATION PHOTOS**



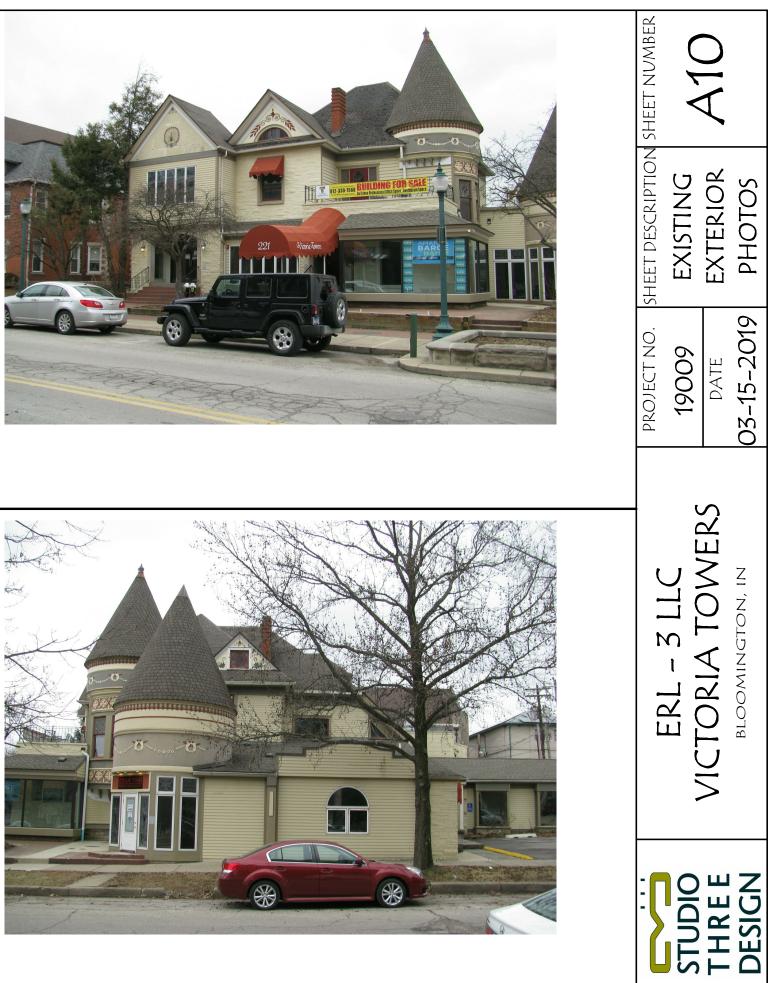

# **EXISTING EAST ELEVATION PHOTOS**

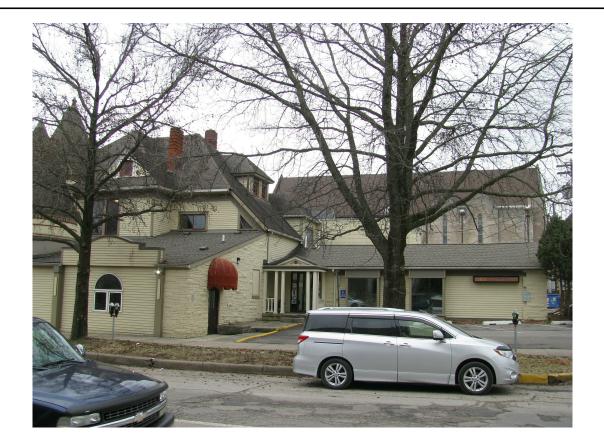








# EXISTING NORTH ELEVATION PHOTOS

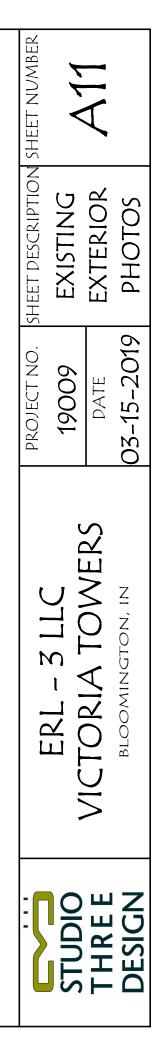





# EXISTING WEST ELEVATION PHOTOS



