

CITY OF BLOOMINGTON PLANNING AND TRANSPORTATION DEPARTMENT

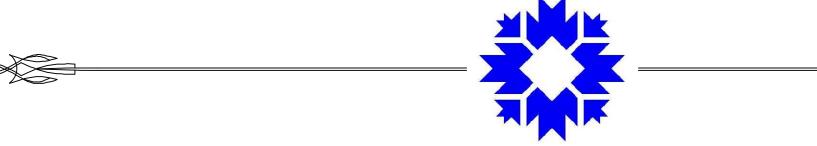

SOUTH SARE ROAD CROSSWALK ISLANDS

ROUTE: 2700 BLOCK SOUTH SARE ROAD AND 2900 BLOCK SOUTH SARE ROAD

SIDEWALKS, CENTER ISLANDS AT THE INTERSECTIONS OF SARE-WINSTON AND SARE-SPICEWOOD

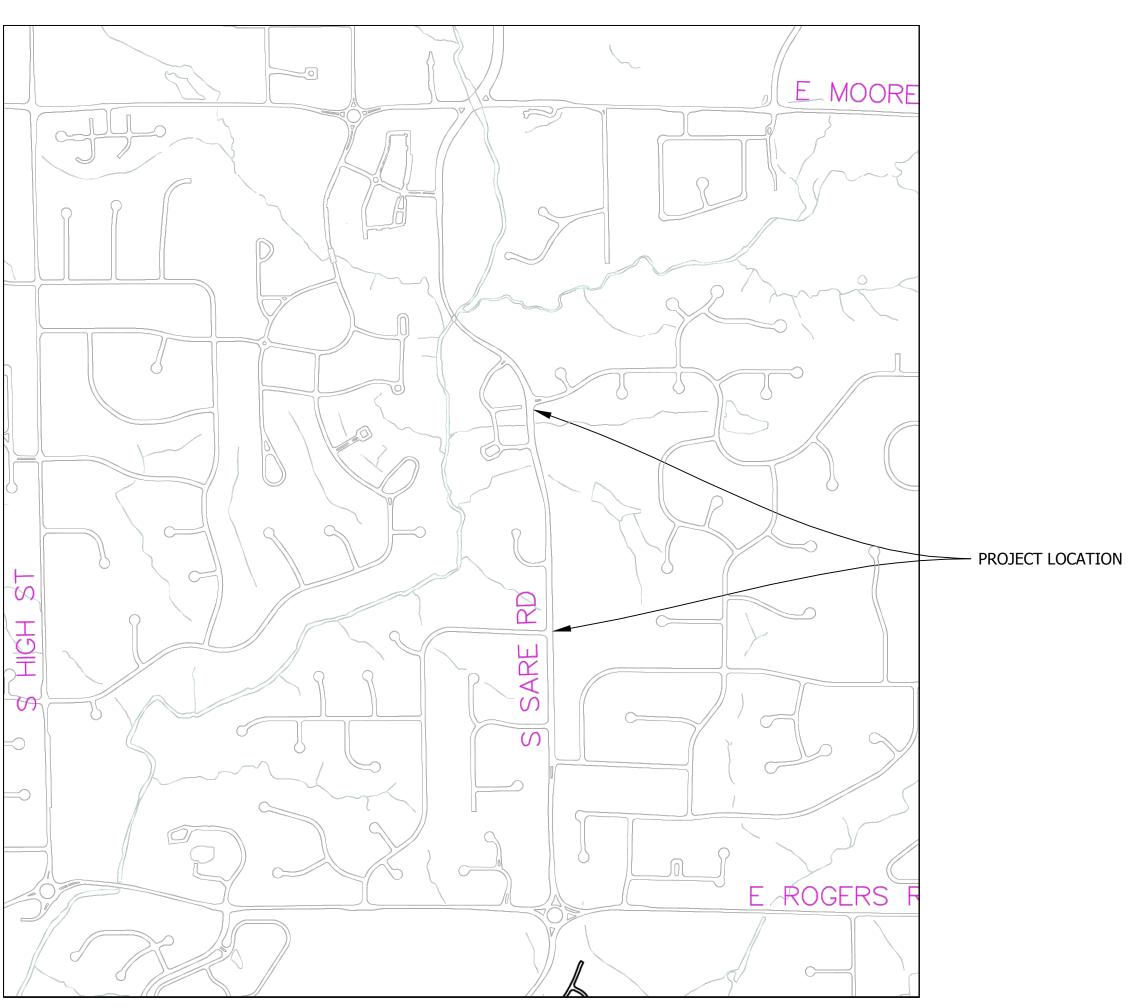

CITY OF BLOOMINGTON MONROE COUNTY INDIANA

INDIANA DEPARTMENT OF TRANSPORTATION STANDARD SPECIFICATIONS DATED 2018 AND CURRENT SUPPLEMENTS THERETO, TO BE USED WITH THESE PLANS

DATA

S SARE ROAD

13506

8.00%

40 MPH

S SARE ROAD

PEDESTRIAN

SIDEWALK

LEVEL

URBAN COLLECTOR

TRAFFIC DATA

DESIGN DATA

AADT (2015)

TRUCKS

AADT (2014 PROJECTED

DHV (2035 PROJECTED)

85TH PERCENTILE

DESIGN SPEED

RURAL/URBAN


ACCESS CONTROL

TERRAIN

DIRECTIONAL DISTRIBUTION

PROJECT DESIGN CRITERIA

FUNCTIONAL CLASSIFICATION

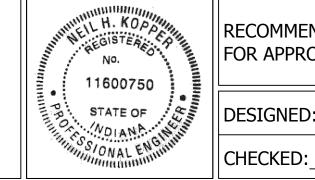

RECOMMENDED FOR APPROVAL	This Type 11/16/2017			
	PROJEC	CT ENGINE	ER	DATE
DECICNED. NIV / DA		DRAWN:	DΛ	
DESIGNED: NK / RA		DKAWN:_	RA	

CHECKED: NK

	CITY OF BLOOMINGTON PLANNING AND TRANSPORTATION DEPARTMEN
_	SOUTH SARE ROAD CROSSWALK ISLANDS

	HORIZONTAL SCALE	IZONTAL SCALE BRIDGE FILE	
г	VERTICAL SCALE	DESIGNATION	
•			
==			
	SURVEY BOOK	SHEETS	
		1 of 5	
	CONTRACT	PROJECT	

SOUTH S CROSSWA

UTILITIES

City of Bloomington Parking Enforcement 401 N Morton Street

Suite #120 Raye Ann Cox 812-349-3436

Water and Sewer City of Bloomington Utility Department 600 E Miller Drive Bloomington, IN 47401 Jane Fleig

Electricity Duke Energy 1100 West 2nd Street Bloomington, IN 47403 Kerry Ducker

812-339-1444

812-337-3035

City of Bloomington Street Department 1981 South Henderson St Joe Vandeventer 812-349-3448

Gas Vectren 205 S Madison St Bloomington, IN 47404 812-330-4009

- (C4) SIDEWALK, CONCRETE, 4IN.
- ©18 CURB AND GUTTER, CONCRETE
- (8) STANDING CURB, CONCRETE
- © CURB RAMP WITH DETECTABLE ELEMENTS, CONCRETE
- (s) SODDING NURSERY
- (CT) CURB TRANSITION, CONCRETE
- A PAVEMENT PATCH, 1.5" HMA SURFACE ON 9" PCCP
- M24 TRANSVERSE MARKING, THERMOPLASTIC, CROSSWALK LINE, 24 IN.
- (MS) TRANSVERSE MARKING, THERMOPLASTIC, STOP LINE, 24 IN.
- (M2) DOUBLE LINE, THERMOPLASTIC, YELLOW, 4 IN.
- M4) LINE, THERMOPLASTIC, WHITE, 4 IN.
- M8) CHEVERON, THERMOPLASTIC, WHITE, 8 IN.
- (S31) CROSSWALK SIGN ASSEMBLY, SEE DETAIL
- (S31) CROSSWALK SIGN ASSEMBLY, SEE DETAIL

	GENERAL NOTES	
**	Existing utilities: Existing buried utilities shown in the plan are shown in accordance with the available records and field information available to the engineer. Other utilities may also be present. It is anticipated that numerous buried utility lines are likely to be encountered during construction. The contractor shall be responsible for field locating and coordinating with the owners of the existing utilities to determine the location of their buried facilities. The contractor shall contact City Engineering of any conflicts between existing utilities and proposed work.	
**	Maintenance of traffic (vehicular and pedestrian): Continuous maintenance of access to business and residences shall be provided along with protection of the public from construction activities at all times. Temporary traffic control shall be provided by the contractor and in accordance with the latest addition of the Indiana MUTCD. Contractor shall be responsible for keeping the project site in a neat and safe condition at all times.	
**	The contractor shall submit for approval a Maintenance of Traffic plan (MOT).	
**	Contractor shall provide all materials, equipment, tools and labor with the exception of: The City of Bloomington shall provide the proposed brick pavers. The contractor shall be responsible for installing the brick pavers in accordance to the manufacturer's recommendations. The contractor shall be responsible for delivery of the brick pavers from the Winston Thomas storage site to the project site.	
**	All permits are to be obtained by the contractor prior to the start of construction.	
**	All sidewalks, curb ramps, and pedestrian places shall be constructed to PROWAG standards.	
**	The contractor shall provide all necessary erosion control measures.	

** All disturbed areas shall be repaired with sod in accordance with INDOT SS Section 621.

** REPRESENTS GENERAL NOTES REQUIRED

	REVISIONS	
SHEET NO.	DATE	REVISED
SHEET INU.	DATE	KEA12ED

INDEX TO SHEETS

DRAWING INDEX

SHEET NO.

1 TITLE SHEET

3 DETAILS

2 INDEX AND GENERAL NOTES

4 SITE PLAN WINSTON

5 SITE PLAN SPICEWOOD



RECOMMENDED FOR APPROVAL



DESIGNED: NK / RA

CITY OF BLOOMINGTON PLANNING AND TRANSPORTATION DEPARTMENT


SOUTH SARE ROAD ISLANDS GENERAL NOTES


BRIDGE FILE HORIZONTAL SCALE VERTICAL SCALE DESIGNATION SHEETS SURVEY BOOK 2 of 5 PROJECT CONTRACT


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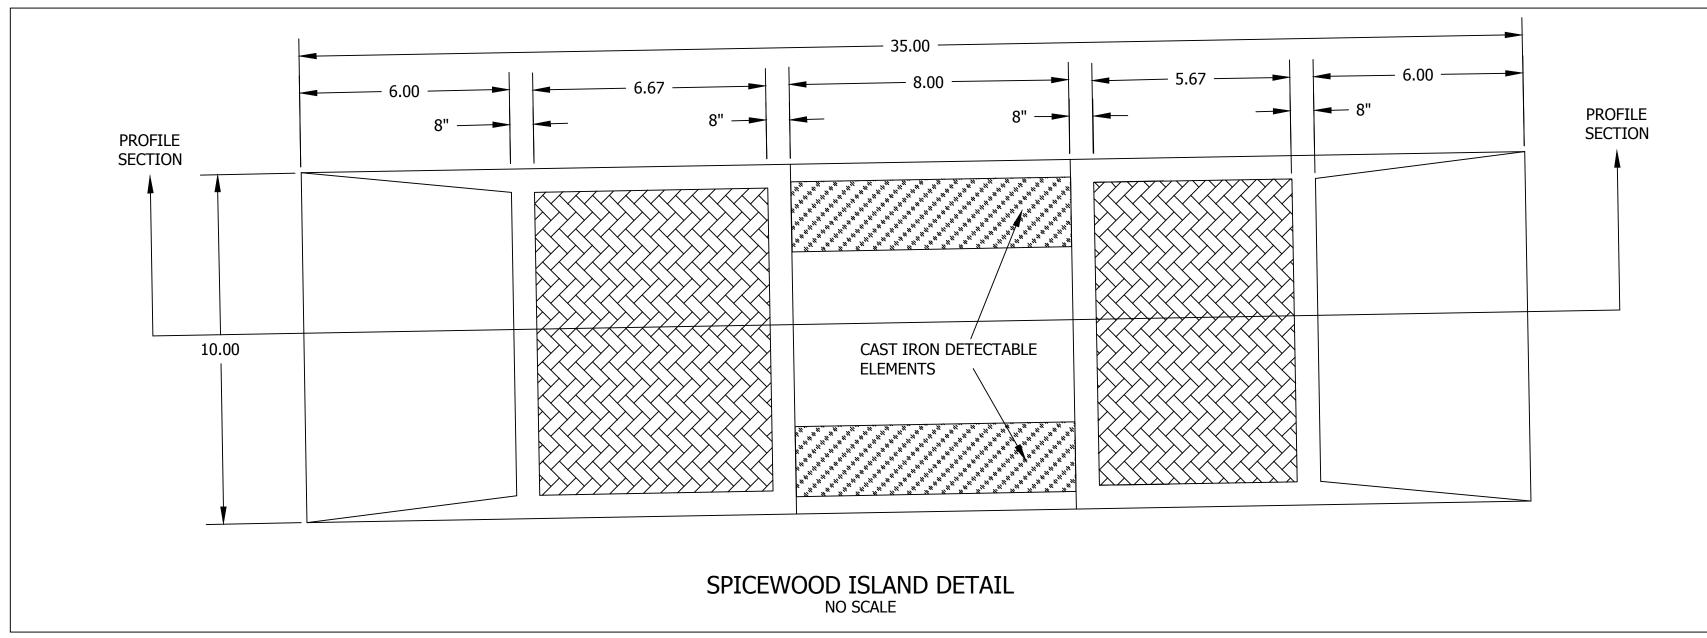
DRAWN: RA


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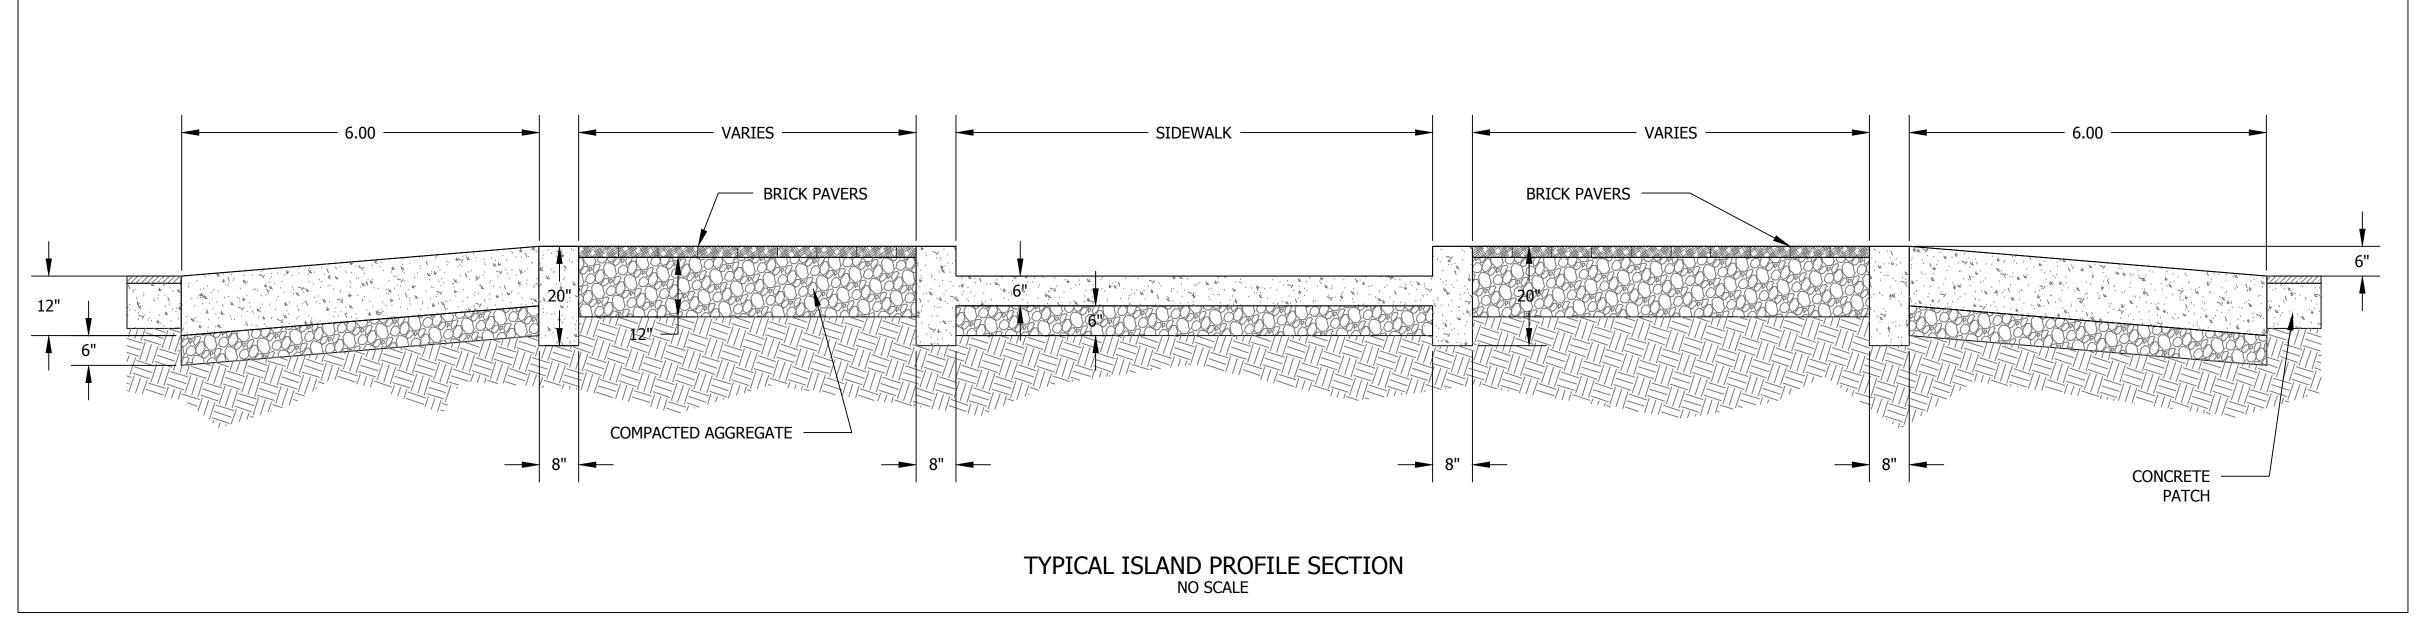




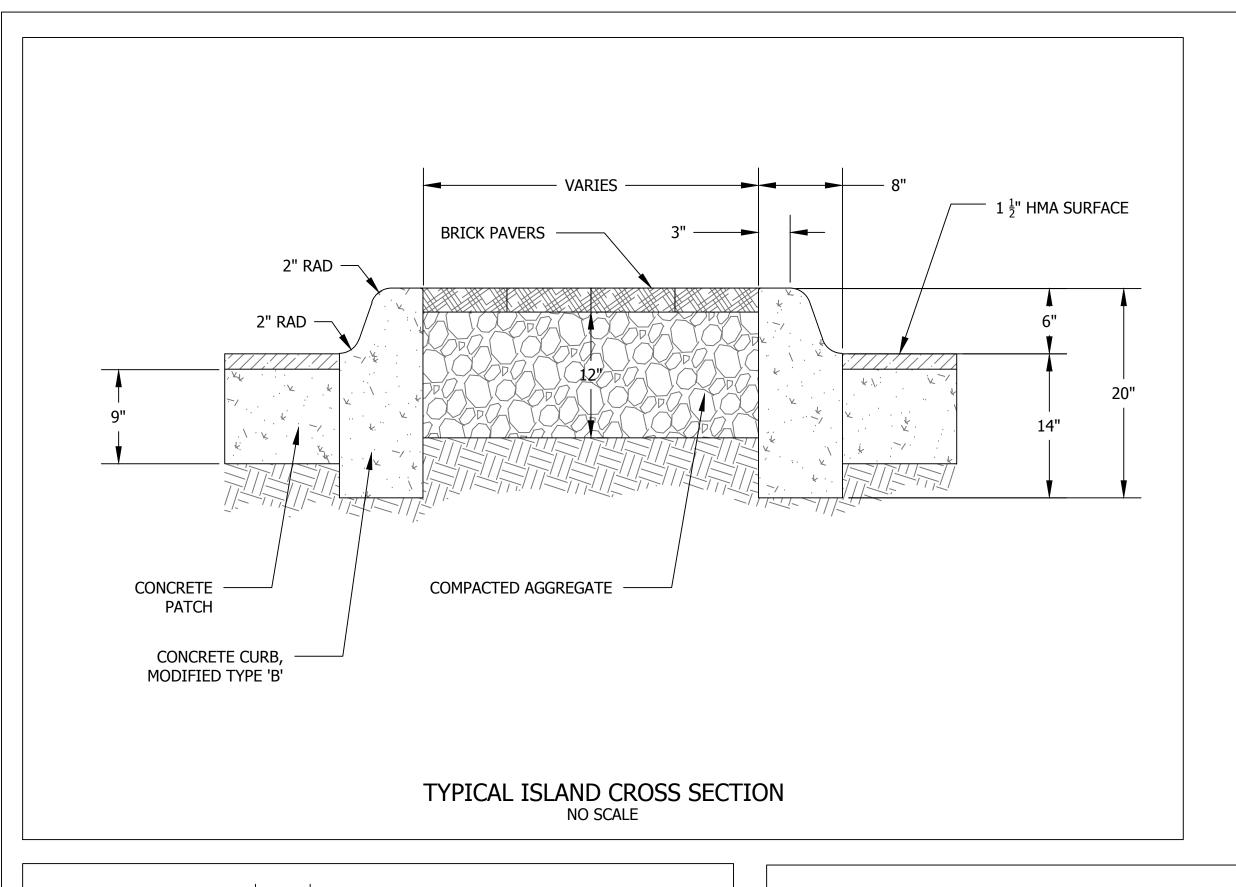

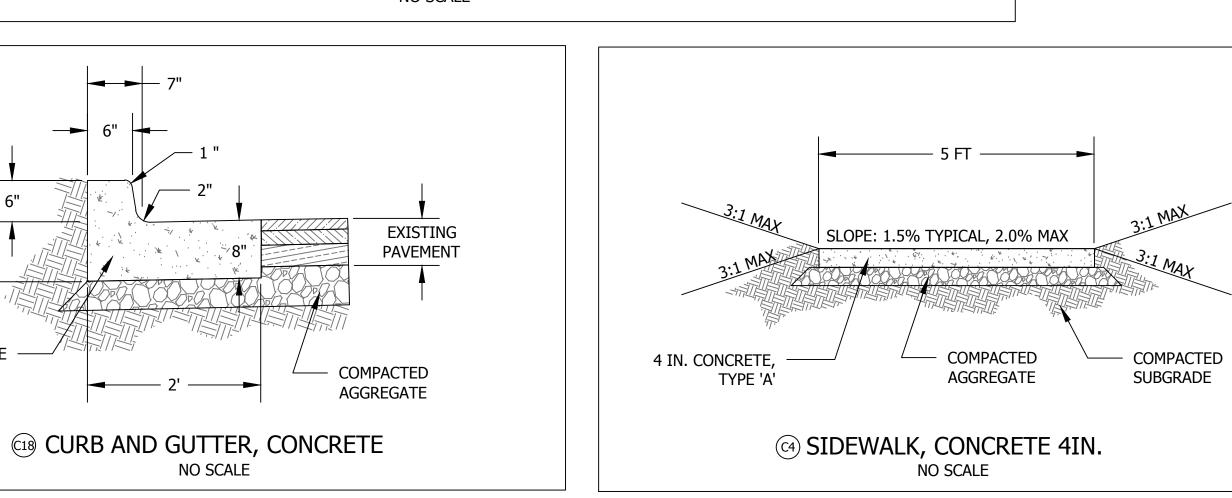

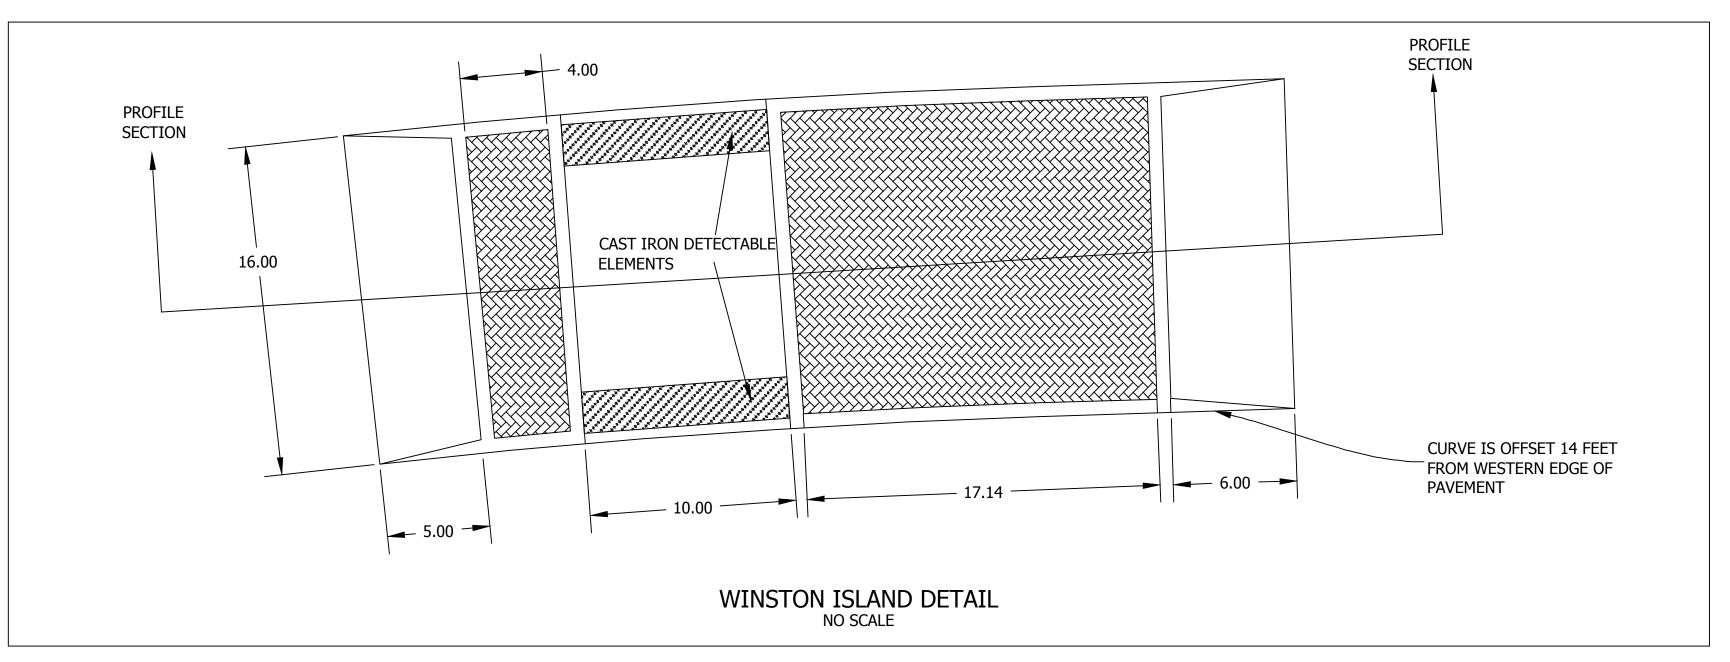

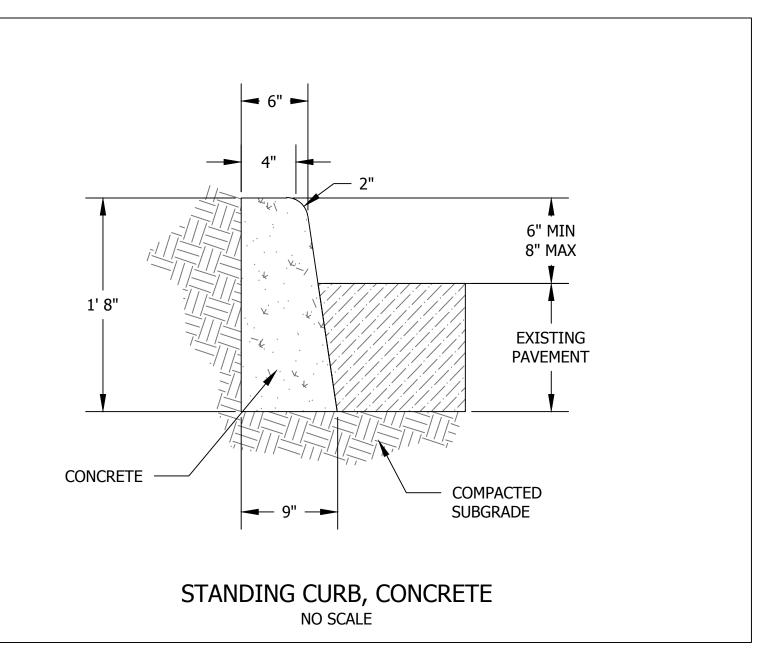

(c4) SIDEWALK, CONCRETE, 4IN.

CONCRETE

- ©18 CURB AND GUTTER, CONCRETE
- (8) STANDING CURB, CONCRETE
- (C6) CURB RAMP WITH DETECTABLE ELEMENTS, CONCRETE
- (12) 4" WHITE THERMOPLASTIC

- 12) 4" WHITE THERMOPLASTIC
- (12) 4" WHITE THERMOPLASTIC
- (12) 4" WHITE THERMOPLASTIC
- 12) 4" WHITE THERMOPLASTIC (M2) DOUBLE LINE, THERMOPLASTIC, YELLOW, 4 IN.
- M24 TRANSVERSE MARKING, THERMOPLASTIC, CROSSWALK LINE, 24 IN.
- (M8) CHEVERON, THERMOPLASTIC, WHITE, 8 IN.
- (M4) LINE, THERMOPLASTIC, WHITE, 4 IN.
- (\$30) CROSSWALK SIGN ASSEMBLY, SEE DETAIL (S31) CROSSWALK SIGN ASSEMBLY, SEE DETAIL
- 11600750 STATE OF

RECOMMENDED FOR APPROVAL PROJECT ENGINEER DATE

DRAWN: RA DESIGNED: NK / RA CHECKED: CHECKED: NK

CITY OF BLOOMINGTON PLANNING AND TRANSPORTATION DEPARTMENT

SOUTH SARE ROAD ISLANDS DETAILS

HORIZONTAL SCALE BRIDGE FILE 1" = 10' VERTICAL SCALE DESIGNATION SURVEY BOOK SHEETS 3 of 5 PROJECT CONTRACT

