

ADDENDUM NO. 2
TO THE
DRAWINGS AND SPECIFICATIONS
FOR THE
Hopewell Phase 1 East Demolition Project

Issued From: The City of Bloomington
Engineering Department
Post Office Box 100
401 North Morton Street, Suite #130
Bloomington, Indiana 47402

Issue Date: June 1st, 2022

Letting Date: June 6th, 2022

This Addendum No.2 to the drawings and specifications shall supplement, amend and become a part of the Bid documents, plans, and specifications for the Hopewell Phase 1 East Demolition Project. All bids and construction contracts shall be based on these modifications to the original contract documents. Bidders shall acknowledge receipt of this Addendum on the Bid Form. Failure to do so may subject the Bidder to disqualification.

Item No. 1: Revised Plan Set

A revised plan set has been issued. The revised plan set is attached to the addendum.

Item No. 2: Revised Soil Management Plan

A revised Soil Management Plan has been issued. The revised plan is attached to the addendum.

Item No. 3: Underground Storage Tank

The underground storage tank at 640 S. Morton Street is scheduled to be removed by another contractor from June 13th, 2022, through June 17th, 2022.

Item No. 4: Chain Link Fence

The 72" Chain Link Security Fence shall be Temporary Fencing.

	CERTIFIED BY: <u>Andrew Cibor</u> ANDREW CIBOR DIRECTOR OF ENGINEER CITY OF BLOOMINGTON, IN
--	---

Acknowledge receipt of the addendum by representing it on the Bid Form in Section B and submitting a signed copy with your bid proposal.

RECEIVED BY: CONTRACTOR (FIRM AND ADDRESS)

SIGNATURE: _____

DATE: _____

PRINTED NAME: _____

TITLE: _____



March 31, 2022

Karen Valiquett, PE
Senior Project Manager
Shrewsberry & Associates, LLC
7321 Shadeland Station, Suite 160
Indianapolis, Indiana 46256

**RE: SOIL MANAGEMENT PLAN
BLOOMINGTON HOSPITAL REUSE PROJECT PHASE I EAST
HOPEWELL PROJECT
BLOOMINGTON, MONROE COUNTY, INDIANA
METRIC FILE NO. 21-0098**

Dear Ms. Valiquett:

Metric Environmental, LLC (Metric) developed a Soil Management Plan (SMP) for the Bloomington Hospital Reuse Project Phase I East (Hopewell) located northwest corner of South Morton Street and West 1st Street. The SMP was developed as a component of Reuse Planning, to outline guidance and requirements for contaminated soil handling and disposal needed for redevelopment of the property. Enclosed is a copy of the Soil Management Plan.

Should you have any questions or comments regarding our findings, please do not hesitate to contact us.

METRIC ENVIRONMENTAL, LLC

Pat Likins
Senior Project Manager

Enclosures

SOIL MANAGEMENT PLAN

BLOOMINGTON HOSPITAL REUSE PROPERTY PHASE I EAST
HOPEWELL PROJECT
BLOOMINGTON, MONROE COUNTY, INDIANA

PREPARED FOR:

SHREWSBERRY & ASSOCIATES, LLC

MARCH 31, 2022

Prepared by:



Complex Environment. Creative Solutions.

6958 Hillside Court
Indianapolis, IN 46256
Telephone: 317.400.1633
www.metricenv.com

SIGNATURES OF ENVIRONMENTAL PROFESSIONALS
SOIL MANAGEMENT PLAN
BLOOMINGTON HOSPITAL REUSE PHASE I EAST PROPERTY
HOPEWELL PROJECT
BLOOMINGTON, MONROE COUNTY, INDIANA

This Soil Management Plan was prepared by Metric Environmental, LLC (Metric) for Shrewsberry & Associates, LLC (Shrewsberry).



QA/Technical Reviewer:
Vince Epps
Vice President/Senior Environmental Scientist

March 30, 2022_____
Date



Project Manager:
Pat Likins
Assessment-Remediation Senior Project Manager

March 30, 2022_____
Date

Prepared by:
Joe Brodowski, LPG
Assessment-Remediation Senior Project Manager

March 30, 2022_____
Date

TABLE OF CONTENTS

SIGNATURES OF ENVIRONMENTAL PROFESSIONALS	I
TABLE OF CONTENTS.....	II
1.0 INTRODUCTION.....	1
2.0 BACKGROUND.....	2
3.0 SUMMARY OF INVESTIGATION AND REMOVAL ACTIONS.....	4
4.0 EXTENT OF SOIL IMPACTS.....	6
5.0 SOIL MANAGEMENT.....	7
5.1 DUST CONTROL	7
5.2 EROSION CONTROL.....	7
5.3 REUSE OR DISPOSAL OF EXCAVATED SOIL.....	7
6.0 RELEVANT SOIL MANAGEMENT CONCENTRATION TRIGGER LEVELS.....	9
7.0 SAMPLING PROCEDURES.....	11
8.0 NOTIFICATION AND REPORTING	12
9.0 REFERENCES	13

Appendices

Appendix A – Definitions and Acronyms

Appendix B –Exhibits

- Exhibit 1 – Property Vicinity Map
- Exhibit 2 – Parcel Depiction Layout
- Exhibit 3 – Soil Boring Locations
- Exhibit 4 – SMP Area

1.0 INTRODUCTION

Metric Environmental, LLC (Metric) has developed this Soil Management Plan (SMP) for the Hopewell Property located on the northwest corner of South Morton Street and West 1st Street in Bloomington, Monroe County, Indiana (the Site). A property vicinity map is included as Exhibit 1 in Appendix B. The properties included in the SMP are:

	Property Address	Parcel Number
B	605 S Madison, Bloomington, IN 47403	53-08-05-100-129.000-009
C	409 W 2 nd St., Bloomington, IN 47403	53-08-05-100-081.000-009
D	407 W 2 nd St., Bloomington, IN 47403	53-08-05-100-047.000-009
E	313 W 2 nd St., Bloomington, IN 47403	53-08-05-100-118.000-009
F	311 W 2 nd St., Bloomington, IN 47403	53-08-04-200-182.000-009
G	303 W 2 nd St., Bloomington, IN 47403	53-08-04-200-136.000-009
H	301 W 2 nd St., Bloomington, IN 47403	53-01-55-251-000.000-009
I	411 W 2 nd St., Bloomington, IN 47403	53-08-05-100-048.000-009
J	403 W 2 nd St., Bloomington, IN 47403	53-08-05-100-053.000-009
K	401 W 2 nd St., Bloomington, IN 47403	53-08-05-100-069.000-009
L	321 W 2 nd St., Bloomington, IN 47403	53-08-05-100-052.000-009
M	W 2 nd St., Bloomington, IN 47403	53-08-05-100-130.000-009
N	W 2 nd St., Bloomington, IN 47403	53-01-56-030-000.000-009
O	635 S Rogers St., Bloomington, IN 47403	53-08-05-100-056.000-009
P	407 W 2 nd St., Bloomington, IN 47403	53-08-05-100-128.000-009
Q	640 S Morton St., Bloomington, IN 47403	53-08-05-100-113.000-009
R	400 W 1 st St., Bloomington, IN 47403	53-08-05-100-017.000-009
S	410 W 1 st St., Bloomington, IN 47403	53-08-05-100-094.000-009
T	653 S Rogers St., Bloomington IN 47403	53-08-05-100-034.000-009

Proposed redevelopment plans include a mixture of “greenspace” and commercial development.

Two on-site subsurface investigations were conducted, and contaminant exposure pathways were identified. The results of the investigations will require the establishment of Environmental Restrictive Covenants (ERCs) for the properties following rezoning of the property parcels.

2.0 BACKGROUND

The properties associated with this SMP encompass approximately 7.26 acres of the northwest corner of the West 1st Street and S Morton Street intersection properties (the SMP Area). A map showing the associated properties/parcels is included as Exhibit 2 in Appendix B. A map showing the SMP Area is included as Exhibit 4 in Appendix B.

The Properties along W 2nd Street at the north perimeter of the SMP Area are historically residential. Parcel L, 411 W 2nd Street, is currently commercial office space.

The eastern portion of the SMP Area (605 S Madison, 640 S Morton and W. 2nd Street Parcel No. 53-01-56-030-000.000-009) was utilized as bulk oil facilities and an auto repair shop between 1927 and 1976. The central portion of the SMP Area, 635 S Rogers, was utilized as automotive repair, painting, and other maintenance-related work.

The Property at 630 S Morton Street (formerly 605 S Madison Street) was historically the location of various oil companies from circa 1960 until circa 1969. Since circa 1974 the Property has had one occupant (JC Dotson) circa 2000 to circa 2004. The Property has had no listing since 2010. The Property building currently is used for storage of paper records.

The Property at 400 W 1st Street includes three addresses: 320, 324, and 400 W. 1st Street. The portion of the Property identified as 320 W. 1st Street was used as residential housing from 1922 until circa 1990. The portion of the Property identified as 324 W. 1st Street, has had a variety of uses including residential (1913 – 1964). In the late 1960s it was an Apostolic Temple and in the 1970s it was used as a Martial Arts Center. The portion identified as 400 W 1st Street, was used as residential from 1916 until circa 1917. The Property was the site of a machine shop from circa 1929 until circa 1946. A day care occupied the site in 1969. The Property is currently a parking lot.

The central portion of the SMP Area, Property at 635 S Rogers, and 407 W 2nd Street, was reported in the 2018 August Mack Phase I as having been developed with the Indiana University Hospital Services Building and Carpenter Shop. It has been used as a maintenance/automotive repair shop since at least 1963. The August Mack Phase I reported a drain in the ambulance service area previously discharged to a dry well in the current parking area north of the building, which was subsequently filled, the area of the dry well was reportedly excavated, however; no excavation records of confirmatory sampling was available for review. The Property was owned and operated circa 1927 by Indiana Lime Stone Bowman Mill, and circa 1947 the Public School Service Building.

The Property at 653 S Rogers Street was 416 W 1st Street. Current tax records indicate the property now shares the address of 653 S Rogers with the adjoining west property. The Property was the location of various Bloomington Hospital facilities. The Property has been used as residential housing since at least 1945.

The following reports are available which document the results of investigations performed at or in the vicinity of the Site:

- *Phase II Subsurface Investigation – Indiana University Health Bloomington Hospital Campus* (2019 Phase II SI), dated May 28, 2019, prepared by August Mack Environmental (Project Number JS1901.740) (VFC# 83312739)
- *Phase I Environmental Site Assessment, Indiana University Health Bloomington Hospital Campus, Parcels A, B, C, & D, Bloomington, Indiana*, – prepared by August Mack September 28, 2018 (VFC# 83312742)
- *Phase I Environmental Site Assessment Report – 653 S Rogers Street* (2021 Phase I ESA), dated November 12, 2021, prepared by Metric Environmental, LLC (Metric) (Project Number #21-0098) (VFC# 83312746)
- *Phase I Environmental Site Assessment Report – 630 S Morton Street* (2021 Phase I ESA), dated July 16, 2021, prepared by Metric Environmental, LLC (Metric) (Project Number #21-0098) (VFC# 83312748)
- *Phase I Environmental Site Assessment Report – 400 W 1st Street* (2021 Phase I ESA), dated July 16, 2021, prepared by Metric Environmental, LLC (Metric) (Project Number #21-0098) (VFC# 83312752)
- *Phase II Limited Subsurface Investigation* (2021 Phase II LSI), dated November 22, 2021, prepared by Metric Environmental, LLC (Metric) (Project Number #21-0098) (VFC# 83312755)

3.0 SUMMARY OF INVESTIGATION AND REMOVAL ACTIONS

2019 Phase II Subsurface Investigation

During September and November 2018, August Mack performed a Phase II SI at the Bloomington Hospital Reuse Project Phase I East site. Soil borings SB-5 through SB-22 and SB-25 through SB-30 were advanced across the northern and eastern portions of the SMP project site. Soil boring locations are depicted on Exhibit 3 in Appendix B. The results of the investigation identified the following:

Soils

- Arsenic:
 - Concentrations detected in samples SB-10 (10-12), SB-14 (4-6), and SB-21 (2-4), exceeded the RCG Migration to Groundwater (MTG) SL
 - Concentrations detected in samples SB-10 (10-12) exceeded the Residential Direct Contact (RDC) SL .
- VOCs:
 - The concentration of benzene detected in samples SB-20 (2-4), SB-25 (2-4), SB-26 (2-4), SB-27 (2-4 and 6-7), and SB-28 (2-4 and 6-8) exceeded the RCG MTG SL.
 - The concentrations of 1,2,4-trimethylbenzene and 1,3,5-trimethylbenzene detected in sample SB-20 (2-4) exceeded the RCG MTG SL.
 - The concentration of n-propylbenzene in sample SB-25 (2-4) and SB-27 (2-4) exceeded the RCG MTG SL.
- PAHs:
 - The concentrations of naphthalene, 1-methylnaphthalene, and/or 2-methylnaphthalene were detected in samples SB-5 (2-4), SB-20 (2-4), SB-25 (2-4), SB-26 (2-4), SB-27 (2-4 and 6-7), SB-28 (2-4 and 6-8), SB-29 (2-4), and SB-30 (4-6) exceeded the RCG MTG SL.

2021 Phase II Limited Subsurface Investigation

On October 18th and 19th, 2021, Metric performed a Phase II LSI at the Bloomington Hospital Reuse Project Phase I East site located at 630 S Morton, 653 S Rogers and 400 W 1st Street, Bloomington, Monroe County, Indiana (the Site). Seven (7) soil borings were advanced at the Site and soil samples were collected, which were analyzed for BTEX/MTBE, PAHs, and RCRA 8 Metals. The boring locations are depicted in Exhibit 3 – Soil Boring Locations, located in Appendix B.

Soils

- Arsenic:
 - Concentrations detected in samples BL-SB-01 (3-5), BL-SB-02 (9-10), BL-SB-03 (9-10), and BL-SB-06 (5-7) exceed the RCG Migration to Groundwater (MTG) SL
 - Concentrations detected in samples BL-SB-01 (7-9), BL-SB-03 (3-5), BL-SB-04 (8-10), BL-SB-04 (14-15), BL-SB-06 (9-10), and BL-SB-07 (4-6) exceed only the RCG MTG and Residential Default Closure (RDC) SLs; and BL-SB-07 (4-6) exceed the RCG MTG and Residential Direct Contact (RDC) SLs.
 - Concentrations detected in samples BL-SB-05(8-10), BL-SB-05 (14-15), and BL-SB-07 (8-9) exceed the RCG MTG, RDC, and Commercial/Industrial Direct Contact (CDC) SLs but do not exceed the Excavation Direct Contact (EDC) SL.
- Cadmium:
 - The concentration detected in sample BL-SB-01 (3-5) exceeds the RCG MTG SL.
- PAHs:
 - The concentration of 1-methylnaphthalene detected in sample BL-SB-01 (7-9) exceeds the RCG MTG SL (1.2 mg/kg).
 - The concentration of naphthalene detected in sample BL-SB-01 (7-9) exceeds the RCG MTG SL (0.11 mg/kg).

4.0 EXTENT OF SOIL IMPACTS

The Contaminant of Concern is Arsenic in soil because only arsenic has been detected above RCG direct contact screening levels at the Site. The potential exposure pathway is direct contact with soil by residents, commercial/industrial workers, and excavation workers. Soil direct contact occurs via one or more of the following absorption routes:

- Absorbing chemicals through the skin when touching soil
- Inhaling vapors while in direct contact with potentially contaminated soil
- Inhaling potentially contaminated soil particles (e.g., dust)
- Ingesting potentially contaminated soil

Potential receptors include people who live in the area and construction workers.

5.0 SOIL MANAGEMENT

Soils contaminated with arsenic have been identified in the SMP Area. The arsenic detections are identified in Exhibit 3, located in Appendix B.

Because future development could occur in the SMP Area, IDEM requires that all activities be performed in accordance with applicable federal, state, and local laws and regulations.

5.1 Dust Control

Contractor shall prepare a Dust Control Plan in accordance with the Specifications provide by the City of Bloomington. The contractor shall take the following measures to ensure that dust is not created during excavation and handling of contaminated soils.

Dust and odor control monitoring and suppression, if necessary, should be in place during all soil excavation activities. Dust and odor suppression controls may include:

- Reduction of on-site vehicle speeds
- Minimizing drop heights to material haulers from soil loaders
- Considering timing of excavation activities and prevalent wind direction(s) and speed
- Use of odor suppressants like BioSolve®, if necessary
- Regular watering of haul roads and soil stockpiles, if necessary
- Revegetating/stabilizing/covering exposed excavations as soon as practicable

5.2 Erosion Control

A Stormwater and Erosion Control Plan will be developed in compliance with applicable federal, state and local regulations (e.g. NDPS permitting, the IDEM Construction Stormwater General Permit (CSGP), formerly "Rule 5", and Chapter 600 Erosion and Sediment Control) prior to initiation of site work.

Excavated soil shall be managed in a way that will not cause sediment to enter storm water runoff. Excavated soil that is suspected or known to be contaminated shall be placed in sealed containers or stockpiled and covered. Best management practices shall be applied to any excavation or construction work in the SMP Area.

5.3 Reuse or Disposal of Excavated Soil

All disturbed soil from the SMP Area will be sampled and disposed offsite. *Once excavation activities are completed, confirmatory soil samples will be collected for analysis of arsenic to determine that remaining soil concentrations are below applicable and respective RCG screening levels.* It will be the responsibility of the Contractor to develop a Soil Sampling Plan. Sampling results should be reviewed, and soils must be disposed of in an appropriate solid waste landfill

unless sampling results indicate the soils may be used in an unrestricted way in accordance with the IDEM non rule policy document *Uncontaminated Soil Policy* (Waste 0064).

If soil from within the SMP Area is determined to be hazardous and requires offsite disposal, it must be treated to RCRA Universal Treatment Standards prior to disposal in a RCRA Subtitle C landfill.

6.0 RELEVANT SOIL MANAGEMENT CONCENTRATION TRIGGER LEVELS

Table 2 below lists the levels of Arsenic detected in 2019 and 2021 and the relevant IDEM RCG Screening Levels – Direct Contact.

**TABLE 2 - Bloomington Hospital Reuse Phase I East
 2021 Soil Concentrations Exceeding Applicable
 IDEM RCG Screening Levels**

Sample		Contaminant Detected and Concentration (parts per million (ppm))
ID	Depth (feet bgs)	Arsenic
SB-10 *	10-12	13.4
BL-SB-01	7-9	15.5
BL-SB-03	3-5	11.9
BL-SB-04	8-10	26.3
	14-15	27.3
BL-SB-05	8-10	<i>50.5</i>
	14-15	<i>31.3</i>
BL-SB-06	9-10	27.8
BL-SB-07	4-6	17.3
	8-9	<i>52.4</i>
Calculated Average		27.4
RDCSL		9.5
CDCSL/IDCSL		30
EX DCSL		920

Notes: * August Mack 2019 – all remaining results Metric 2021
bold = above RCG Residential Direct Contact Screening Level
italics = above RCG Commercial/Industrial Direct Contact Screening Level
underline = above RCG Excavation Worker Direct Contact Screening Level
 bgs = below ground surface
 IDCSL = Industrial Direct Contact Screening Level
 EX DCSL = Excavation Direct Contact Screening Level

In addition, the IDEM RCG established the Soil Migration to Groundwater (MTG) Screening Level. The IDEM non-rule policy document (NPD) titled *Uncontaminated Soil Policy* (Waste-0064, effective April 10, 2015), aids in determining when soil containing detectable levels of human introduced chemicals is considered ‘uncontaminated’. The lower of the two residential screening levels in RCG Table A-6; the “Migration to Groundwater” (MTG) and the RDCSLs must be used. Soils with concentrations of human introduced chemicals exceeding RCG residential screening levels are considered contaminated and should be disposed in a permitted RCRA

Subtitle D landfill. The MTG SLs are as follows:

Metal	MTG SL
Arsenic	5.9 ppm

For the purpose of land disposal, if total analysis results are equal to more than 20 times the TCLP limits as listed below, the waste may be a hazardous waste and should be assumed as such until further testing, using the TCLP analysis, confirms the waste's toxicity characteristic results.

Metal	TCLP Limit	20 x TCLP Limit
Arsenic	5.0 mg/L	100 mg/L

7.0 SAMPLING PROCEDURES

Sampling and analysis should be performed to ensure that samples are collected in conformance with EPA data-quality requirements and meet the needs of the waste disposal facility in the case of off-site disposal.

Any sampling conducted in association with soil management at the Site should be conducted in accordance with the *Test Methods for Evaluating Solid Waste: Physical/Chemical Methods* (SW-846), by qualified personnel who are appropriately trained and medically monitored under the Hazardous Waste Operations and Emergency Response Standard (HAZWOPER). All samples should be collected and transported under chain of custody to a National Environmental Laboratory Accreditation Program (NELAP) certified accredited laboratory for analysis. Samples should be analyzed for arsenic. Laboratory reporting limits should be less than appropriate regulatory screening values as described in **Section 6.0**.

8.0 NOTIFICATION AND REPORTING

IDEM should be notified if any activities undertaken under this SMP result in a new release or encounter a previously unknown release. To report such a release, call IDEM's 24-Hour Emergency Spill Line toll free at (888) 233-7745 or (317) 233-7745.

9.0 REFERENCES

Indiana Department of Environmental Management (IDEM) (2015). *Uncontaminated Soil Policy* (Waste-0064). Indianapolis, IN

Indiana Department of Environmental Management (IDEM) (2021 as amended). *Remediation Closure Guide* (Waste-0046-R1). Indianapolis, IN

APPENDIX A - DEFINITIONS AND ACRONYMS

DEFINITIONS

Activity and Use Limitations – legal or physical restrictions or limitations on the use of, or access to, a site or facility: 1) to reduce or eliminate potential exposure to hazardous substances or petroleum products in the soil or groundwater on the Property or 2) to prevent activities that could interfere with the effectiveness of a response action, in order to ensure maintenance of a condition of no significant risk to public health or the environment.

Actual Knowledge – the knowledge actually possessed by an individual who is a real person, rather than an entity.

Adjoining Properties – any real property or properties the border of which is contiguous or partially contiguous with that of the Property, or that would be contiguous or partially contiguous with that of the Property but for a street, road, etc.

All Appropriate Inquiry – inquiry constituting “all appropriate inquiry into the previous ownership and uses of the Property consistent with good commercial or customary practice” as defined in CERCLA, 42 USC 9601(35)(B).

Contaminant: any solid, semisolid, liquid, or gaseous matter, or any odor, radioactive material, pollutant as defined in the Federal Waste Pollution Control Act, hazardous waste as defined by the Resource Conservation and Recovery Act (42 U.S.C. 6901 et seq.), as amended, or any combination thereof, from whatever source, that: (A) is injurious to human health, plant or animal life, or Property; (B) interferes unreasonably with the enjoyment of life or Property; or (C) is otherwise volatile of this article or rules adopted under this article.

De minimis condition – A condition that generally does not present a threat to human health or the environment and that generally would not be the subject of an enforcement action if brought to the attention of appropriate governmental agencies.

Engineering Controls (EC) – physical modifications to a site or facility (for example, capping, slurry walls, or point of use water treatment) to reduce or eliminate the potential for exposure to hazardous substances or petroleum products in the soil or ground water on the Property.

Environmental Lien – a charge, security, or encumbrance upon title to a Property to secure the payment of a cost, damage, debt, obligation, or duty arising out of response actions, cleanup, or other remediation of hazardous substances or petroleum products upon a Property.

Environmental Professional – a person meeting the education, training, and experience requirements set forth in 40 CFR 312.10(b). The person may be an independent contractor or an employee of the User.

Free Product: the separate phase material present in concentrations greater than a contaminant's residual saturation point.

Fill Dirt/Material – dirt, soil, and, other earth, or material, that is obtained off-site, that is used to fill holes or depressions, create mounds, raise the grade, etc. (does not include limited quantities used for landscaping purposes)

Geophysical techniques: tests (including magnetometer surveys, ground penetrating radar, electrical resistivity, and seismic refraction) used to locate buried metallic objects, such as USTs, and to map groundwater pathways.

Groundwater: subsurface water in a zone of saturation, which can be brought to the surface of the ground or surface waters, through wells, springs, seepage, or other discharge areas. A zone of saturation is where the voids and pore spaces in the rock, soil or geological materials are filled with water.

Hazardous substance: a substance defined as a hazardous substance pursuant to CERCLA 42 U.S.C. §9601(13), as interpreted by EPA regulations and the courts: “A) any substance designated pursuant to section 1231(B)(2)(A) of Title 33, B) any element, compounds, mixture, solution, or substance designated pursuant to section 9602 of this title, C) any *hazardous waste* having the characteristics identified under or listed pursuant to section 3001 of RCRA (1972) as amended, D) any toxic pollutant listed under section 1317(a) of Title 33, E) any hazardous air pollutant listed under section 112 of the Clean Air Act, and F), any imminently hazardous chemical substance or mixture with respect to which the EPA has taken action pursuant to section 2606 of Title 15. The term does not include petroleum products, natural gas, etc.

Institutional Controls (IC) – a legal or administrative restriction (for example, “deed restrictions,” restrictive covenants, easements, or zoning) on the use of, or access to, a site or facility to 1) reduce or eliminate potential exposure to hazardous substances or petroleum products in the soil or groundwater on the Property or 2) to prevent activities that could interfere with the effectiveness of a response action, in order to ensure maintenance of a condition of no significant risk to public health or the environment.

Obvious – that which is plain or evident; a condition or fact that could not be ignored or overlooked by a reasonable observer while visually or physically observing the Property.

Owner – generally the fee owner of record of the Property.

Petroleum: petroleum asphalt and crude oil or any part of petroleum asphalt or crude oil that is liquid at standard conditions of temperature and pressure [sixty (60) degrees Fahrenheit] and fourteen and seven-tenths (14.7) pounds per square inch absolute.

Property – the real Property that is the subject of the environmental site assessment. Real Property includes buildings and other fixtures and improvements located on the Property and affixed to the land.

Reasonably Ascertainable – information that is (1) publicly available, (2) obtainable from its source within reasonable time and cost constraints, and (3) practically reviewable

Recorded Land Title Records – records of historical fee ownership, which may include leases, land contracts, and AULs on or of the Property.

Release: defined by federal and most state laws as any spilling, leaking, pouring, dumping, emitting, discharging, injecting, escaping, leaching, or disposing of hazardous substances or petroleum products into structures, or onto the ground, ground water, or surface water of a Property.

Sump: a pit, cistern, cesspool, or similar receptacle where liquids drain, collect, or are stored.

User – the party seeking to use Practice E 1527 to complete an environmental site assessment of the Property.

Vapor Encroachment Condition – the presence or likely presence of chemicals of concern vapors in the sub-surface of the Property caused by the release of vapors from contaminate soil or groundwater either on or near the Property.

Wetlands: those areas that are inundated or saturated by surface or ground water at a frequency and duration sufficient to support, and that under normal circumstances do support, a prevalence of

vegetation typically adapted to life in saturated soil conditions. Wetlands generally include swamps, marshes, bogs, and similar areas.

ACRONYMS

AAI	All Appropriate Inquiry	DRO	Diesel Range Organics
ACM	Asbestos-Containing Material	EC	Engineering Control
AHERA	Asbestos Hazard Emergency Response Act of 1986, 40 CFR 763	EDC	Excavation Direct Contact
AMSD	Approximate Minimum Search Distances	EPA	United States Environmental Protection Agency
AST	Aboveground Storage Tank	EPCRA	(Federal) Emergency Planning and Community Right-to-Know Act of 1986, (aka Title III of SARA), 42 USC §11001-11050
ASTM	American Society for Testing and Materials	ERC	Environmental Restrictive Covenant
ATSDR	Agency for Toxic Substances and Disease Registry	ERIS	Environmental Risk Inventory System
AUL	Activity Use Limitation	ERNS	Emergency Response Notification System
BDL	Below detection limit	ERO	Extended Range Organics
BGS	Below grade surface	ESA	Environmental Site Assessment
BTEX	Benzene, Toluene, Ethylbenzene, and Total Xylenes	FID	Flame ionization detector
CAA	Clean Air Act (42 USC §7412)	FINDS	Facility Index System
CAP	Corrective Action Plan	FOIA	Freedom of Information Act (5 USC §552 as amended)
CAPR	Corrective Action Progress Report	FR	Federal Register
CERCLA	Comprehensive Environmental Response, Compensation and Liability Act of 1980 (as amended, 42 USC §9601)	GRO	Gasoline Range Organics
CERCLIS	Comprehensive Environmental Response, Compensation and Liability Information System	HCS	(OSHA) Hazard Communication Standard
CESQG	Conditionally Exempt Small Quantity Generator	HREC	Historical <i>Recognized Environmental Condition</i>
CFR	Code of Federal Regulations	HRS	Hazard Ranking System, 29 CFR 300 App. A
COC	Chemical of Concern	IBP	Indiana Brownfields Program
CREC	Controlled <i>Recognized Environmental Condition</i>	ICs	Institutional Controls
CWA	Clean Water Act	IDEM	Indiana Department of Environmental Management
DNAPL	Dense non-aqueous phase liquid	IGS	Indiana Geological Survey
DNR	(Indiana) Department of Natural Resources	INDR	Indiana Department of Natural Resources
DOT	Department of Transportation	LLPs	Landowner Liability Protections under the Brownfields Amendment
DPW	(Indianapolis) Department of Public Works	LNAPL	Light non-aqueous phase liquid
		LQG	Large Quantity Generator


LSI	Limited Subsurface Investigation	RI/FS	Remedial Investigation & Feasibility Study
LUST	Leaking Underground Storage Tank		
MCL	Maximum Contaminant Levels (as defined by EPA under the SDWA)	RPTA	(Indiana) Responsible Property Transfer Act (1990)
MSDSs	Material Safety Data Sheets	RQ	Reportable Quantity
MTBE	Methyl-tertiary-butyl-ether	SAP	Sampling and Analysis Plan
MTG	Migration to Groundwater		
		SARA	(Federal) Superfund Amendment and Reauthorization Act
NFA	No Further Action		
NFRAP	No Further Remedial Action Planned	SBOH	(Indiana) State Board of Health
		SCP	State Cleanup Program
NEPA	National Environmental Policy Act	SDWA	Safe Drinking Water Act
NESHAPS	National Emissions Standards for Hazardous Air Pollutants	SIC	Standard Industrial Classification
		SPCC	Spill Prevention Control and Countermeasure
NPL	National Priorities List		
O&M:	Operations and Maintenance	SPLP	Synthetic Precipitation Leaching Procedure
OSHA	Occupational Health & Safety Administration		
		SQG	Small Quantity Generator
PACM	Presumed Asbestos Containing Material	SVOC	Semi-volatile organic compounds
		SWMU	Solid Waste Management Unit
PAH	Polycyclic aromatic hydrocarbons	SWPPP	Storm Water Pollution Prevention Plan
PCBs	Polychlorinated Biphenyls		
PCE	Perchloroethylene (Tetrachloroethylene)	TCLP	Toxicity Characteristic Leaching Procedure
PEL	Permissible exposure limit	TPH	Total Petroleum Hydrocarbons
PID	Photoionization detector	TSCA	(Federal) Toxic Substance Control Act
PPB	Parts per billion		
PPM	Parts per million	TSD	Treatment, Storage and Disposal (facilities)
PRP	Potentially Responsible Party		
QA/QC	Quality Assurance/Quality Control	TWSL	Tap Water Screening Level
RACM	Regulated Asbestos Containing Material	USDA	United States Department of Agriculture
		USC	United States Code
RCG	Remediation Closure Guide	US EPA	United States Environmental Protection Agency
		USGS	United States Geological Survey
RCRA	Resource Conservation and Recovery Act (42 USC §6901)	UST	Underground Storage Tank
		VEC	Vapor Encroachment Condition

VES	Vapor Encroachment Screening
VI	Vapor Intrusion
VIGWSL	Vapor Intrusion Groundwater Screening Level
VFC	Virtual File Cabinet
VOC	Volatile organic compounds
VRP	Voluntary Remediation Program

APPENDIX B - EXHIBITS

- Exhibit 1 – Property Vicinity Map
- Exhibit 2 – Parcel Depiction Layout
- Exhibit 3 – Soil Boring Locations
- Exhibit 4 – SMP Area

P:\2021\21-0098 - Shrewsberry - Bloomington - Bloomington Hospital Re-Use\5 - Deliverables\Exhibits\SMP\CAD Files\Ex 1 Property Vicinity Map.dwg

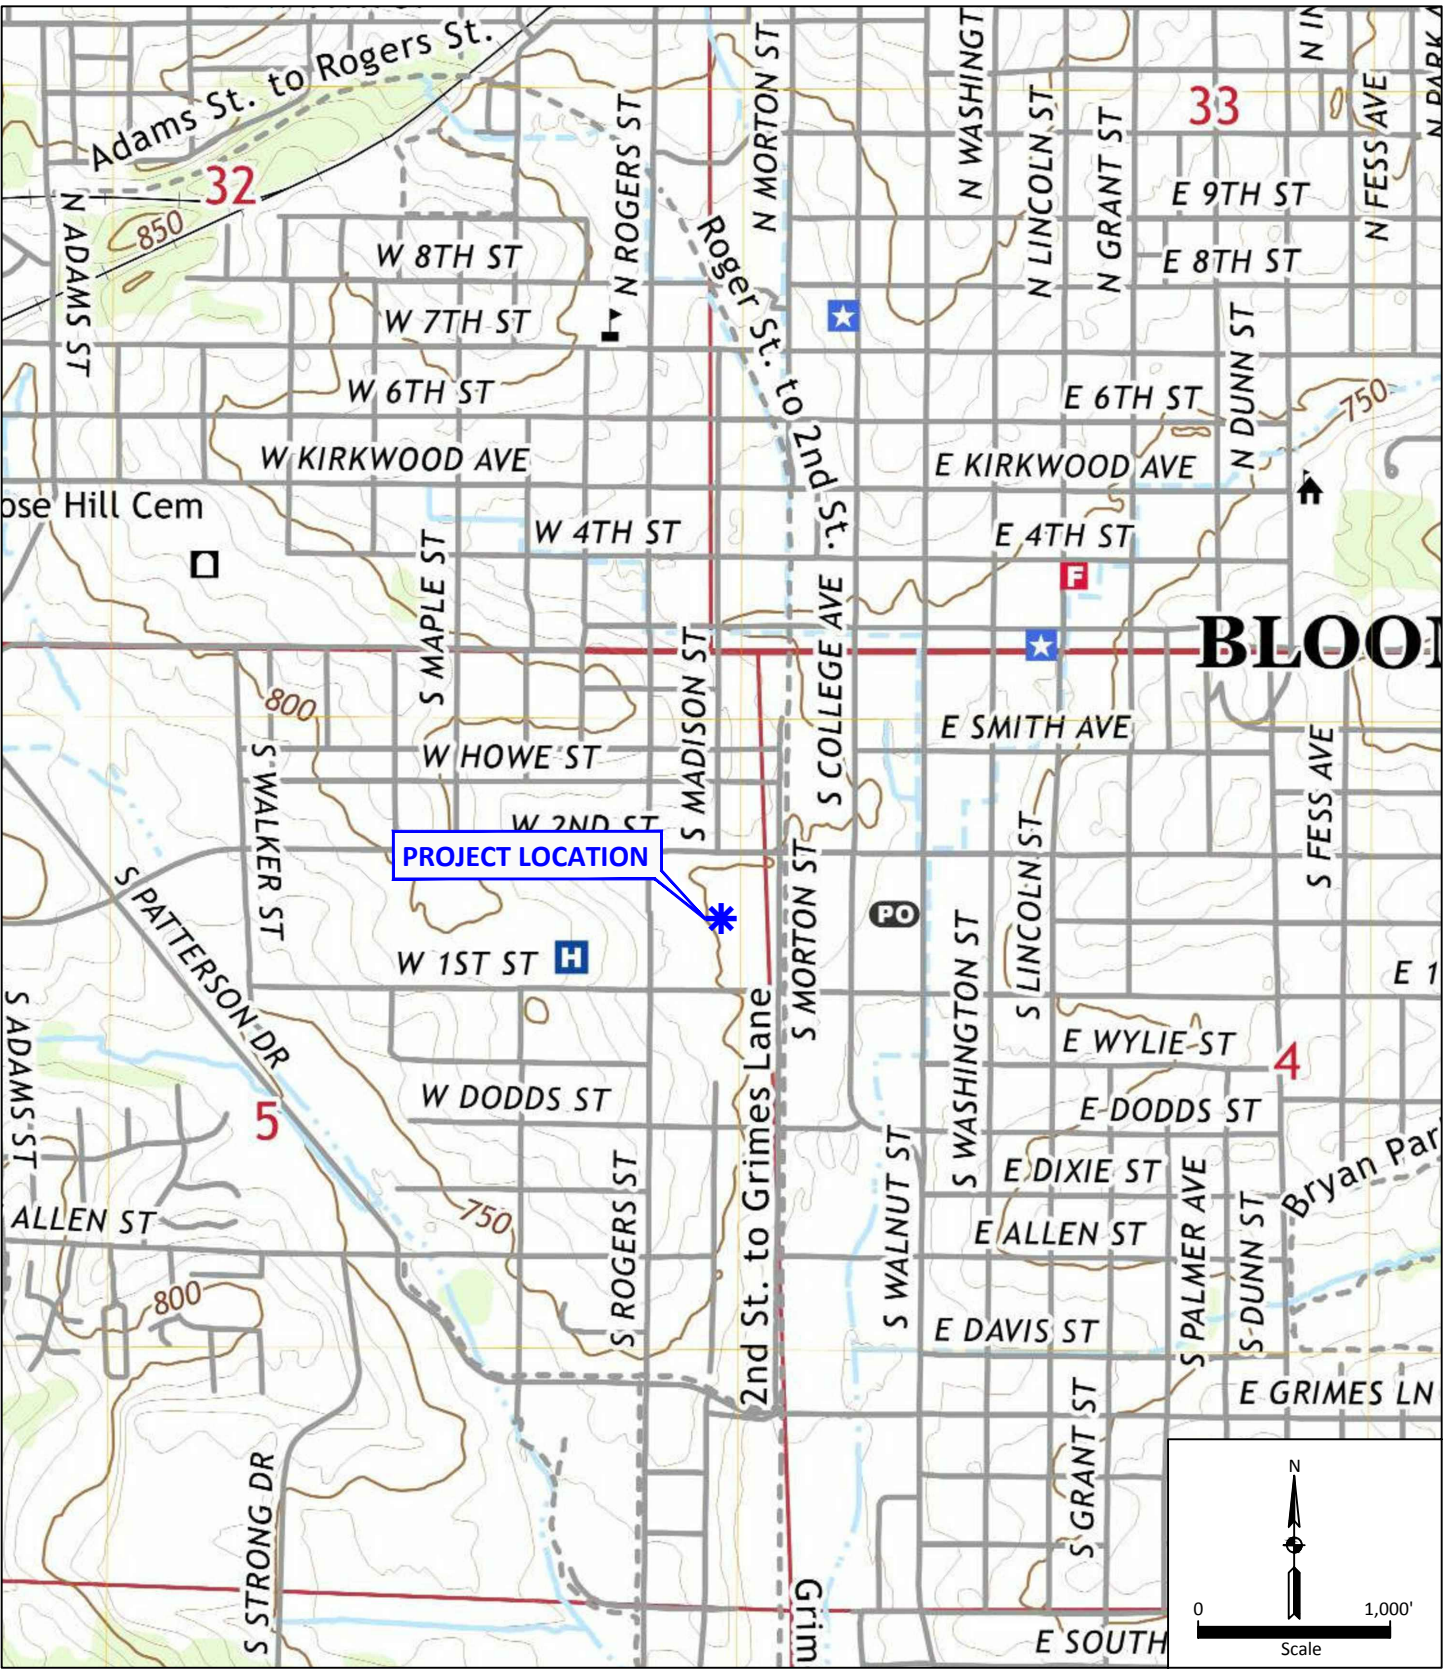


Source: <https://ngmdb.usgs.gov/topoview/viewer/#12/39.5378/-86.2918>

Exhibit 1 - Property Vicinity Map
Soil Management Plan
630 S. Morton Street, 653 S. Rogers Street and 411 W. 1st Street
Bloomington, Monroe County, Indiana
Metric Project # 21-0098

All locations approximate



Drawn by: ILJ
Checked by: JB
Approved by: PL
Date: February, 2022

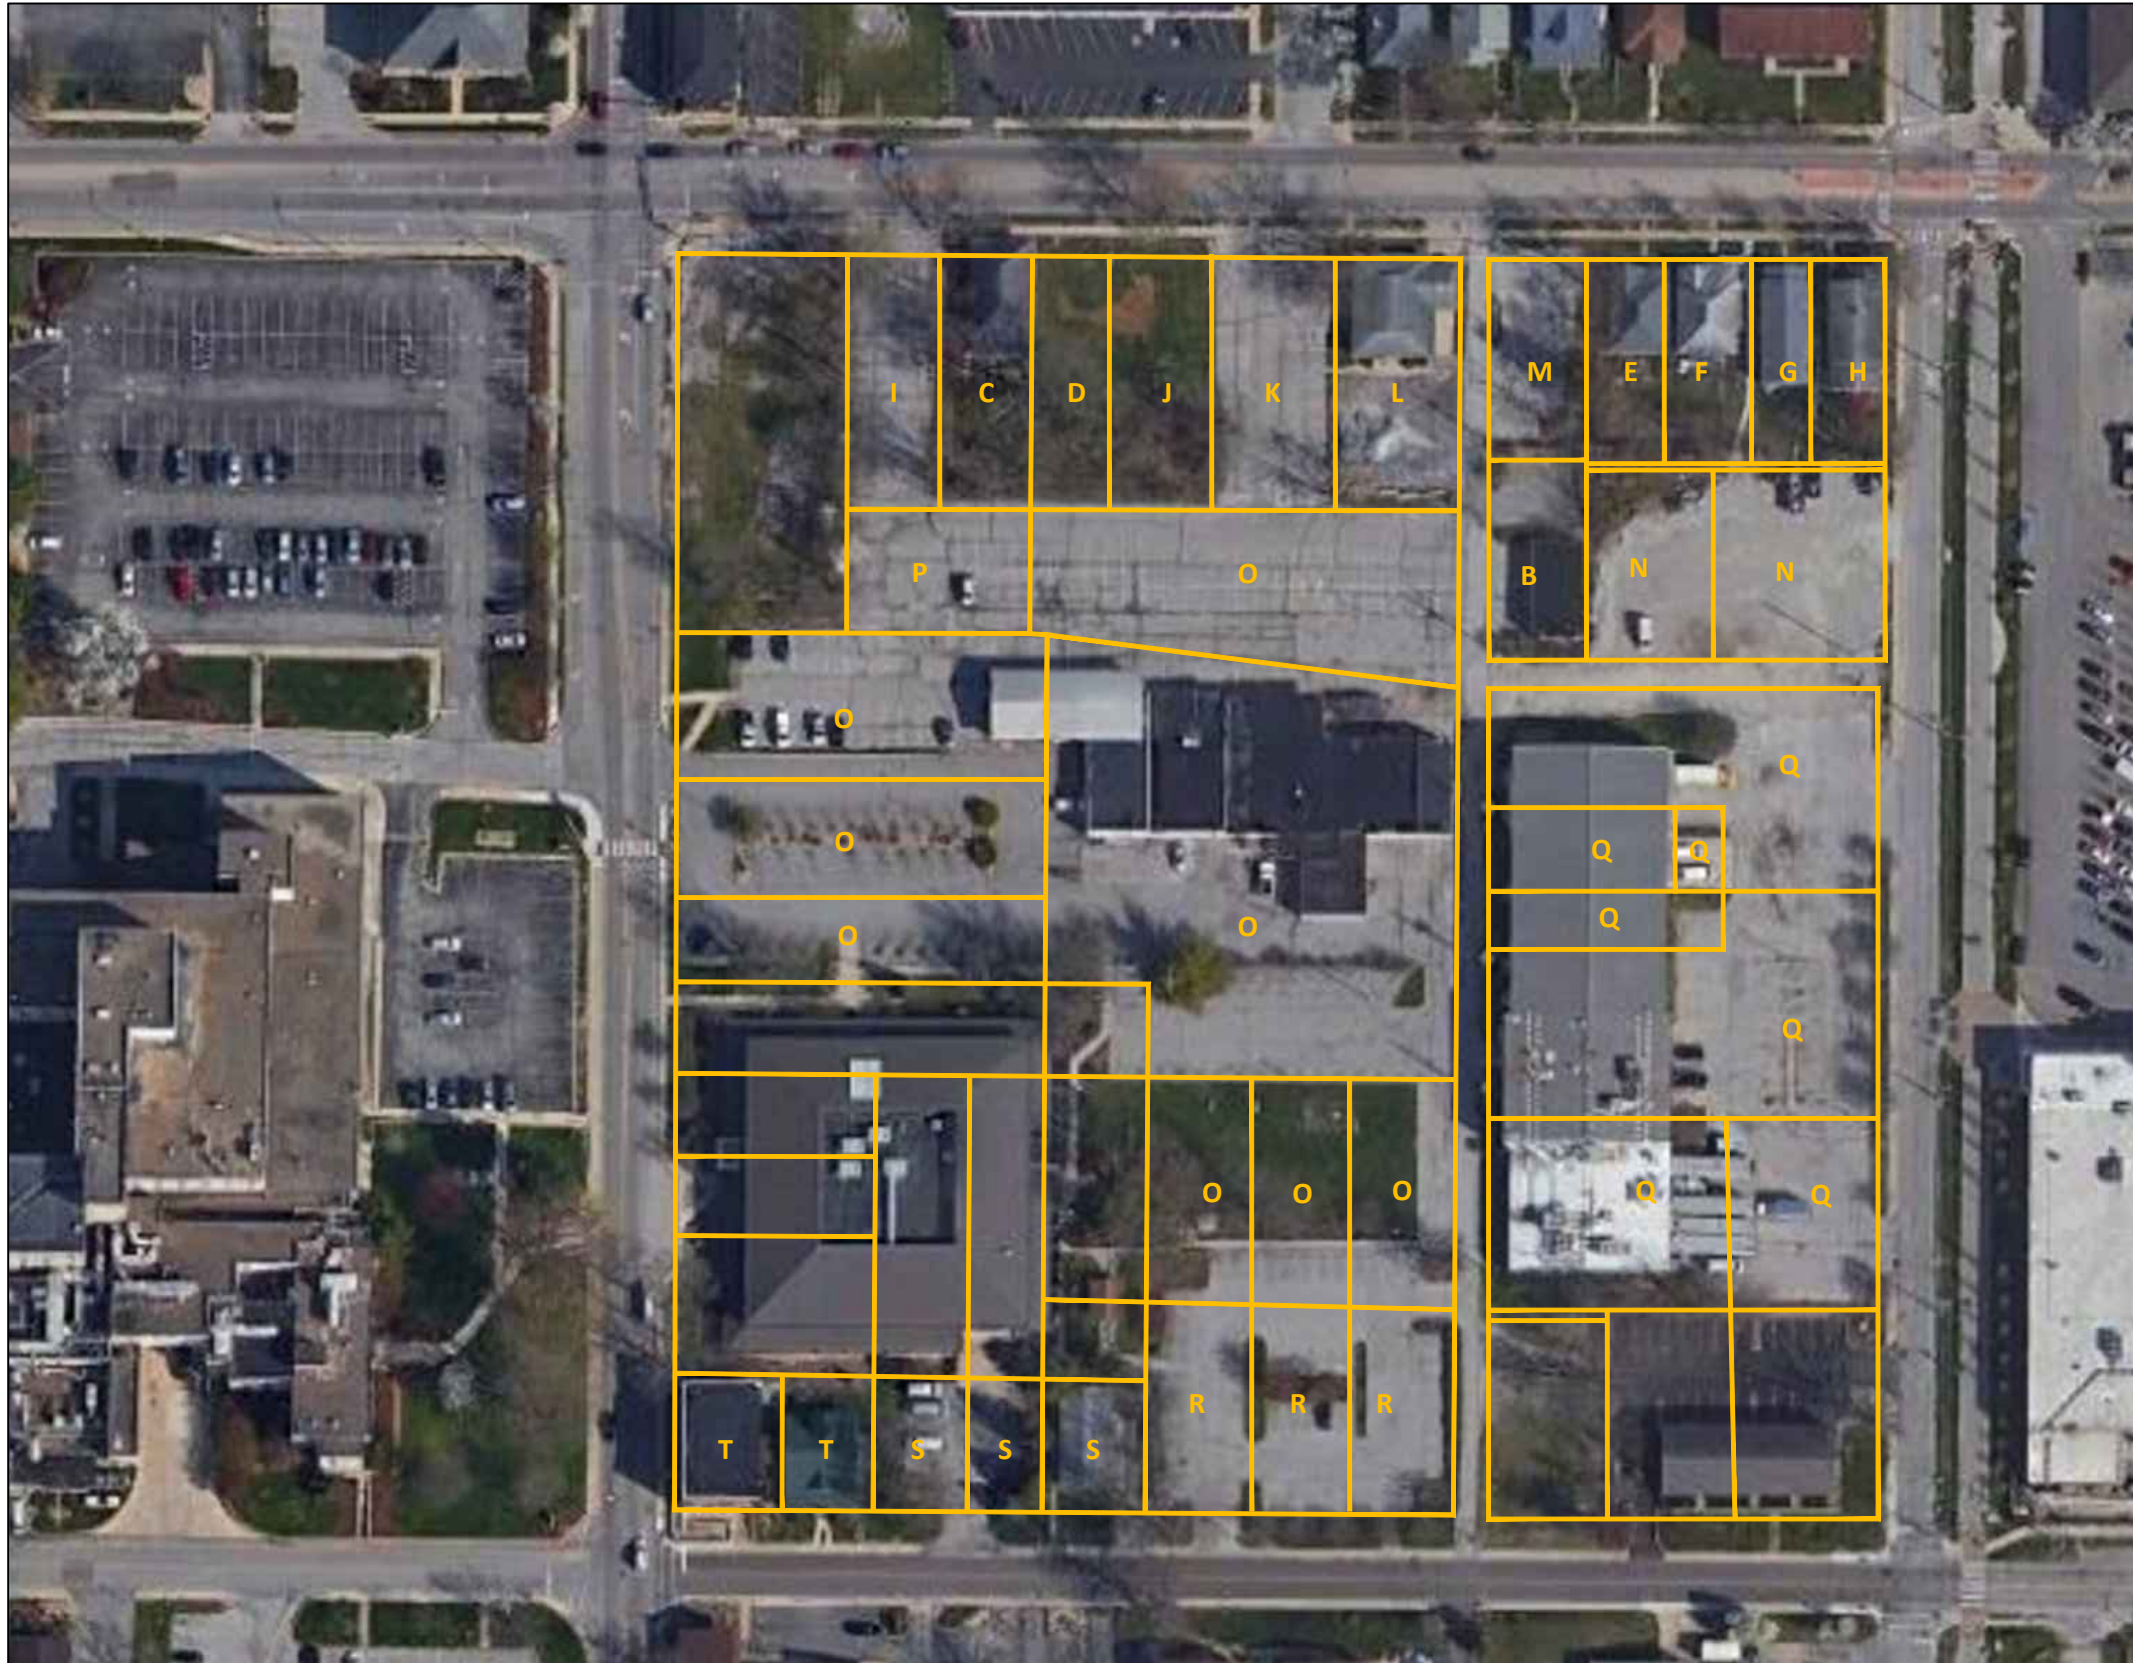

ID #	Address	Parcel #
B	605 S Madison, Bloomington, IN 47403	53-08-05-100-129.000-009
C	409 W 2nd St., Bloomington, IN 47403	53-08-05-100-081.000-009
D	407 W 2nd St., Bloomington, IN 47403	53-08-05-100-047.000-009
E	313 W 2nd St., Bloomington, IN 47403	53-08-05-100-118.000-009
F	311 W 2nd St., Bloomington, IN 47403	53-08-04-200-182.000-009
G	303 W 2nd St., Bloomington, IN 47403	53-08-04-200-136.000-009
H	301 W 2nd St., Bloomington, IN 47403	53-01-55-251-000.000-009
I	411 W 2nd St., Bloomington, IN 47403	53-08-05-100-048.000-009
J	403 W 2nd St., Bloomington, IN 47403	53-08-05-100-053.000-009
K	401 W 2nd St., Bloomington, IN 47403	53-08-05-100-069.000-009
L	321 W 2nd St., Bloomington, IN 47403	53-08-05-100-052.000-009
M	W 2nd St., Bloomington, IN 47403	53-08-05-100-130.000-009
N	W 2nd St., Bloomington, IN 47403	53-01-56-030-000.000-009
O	635 S Rogers St., Bloomington, IN 47403	53-08-05-100-056.000-009
P	407 W 2nd St., Bloomington, IN 47403	53-08-05-100-128.000-009
Q	640 S Morton St., Bloomington, IN 47403	53-08-05-100-113.000-009
R	400 W 1st St., Bloomington, IN 47403	53-08-05-100-017.000-009
S	410 W 1st St., Bloomington, IN 47403	53-08-05-100-094.000-009
T	653 S Rogers St., Bloomington IN 47403	53-08-05-100-034.000-009

Source: <https://monroein.elevatemaps.io/#extent=3108000.7493267483,3107334.0826600813,1425664.5816117919,1425360.3281395698,2245>


Exhibit 2 - Parcel Depiction

Soil Management Plan


630 S. Morton Street, 653 S. Rogers Street and 411 W. 1st Street
 Bloomington, Monroe County, Indiana
 Metric Project # 21-0098

Note: All locations are approximate

— Parcel Lines

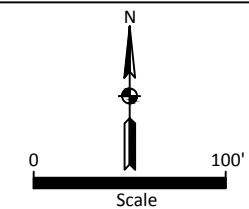

Drawn by: ILJ
 Checked by: JB
 Approved by: PL
 Date: February, 2022

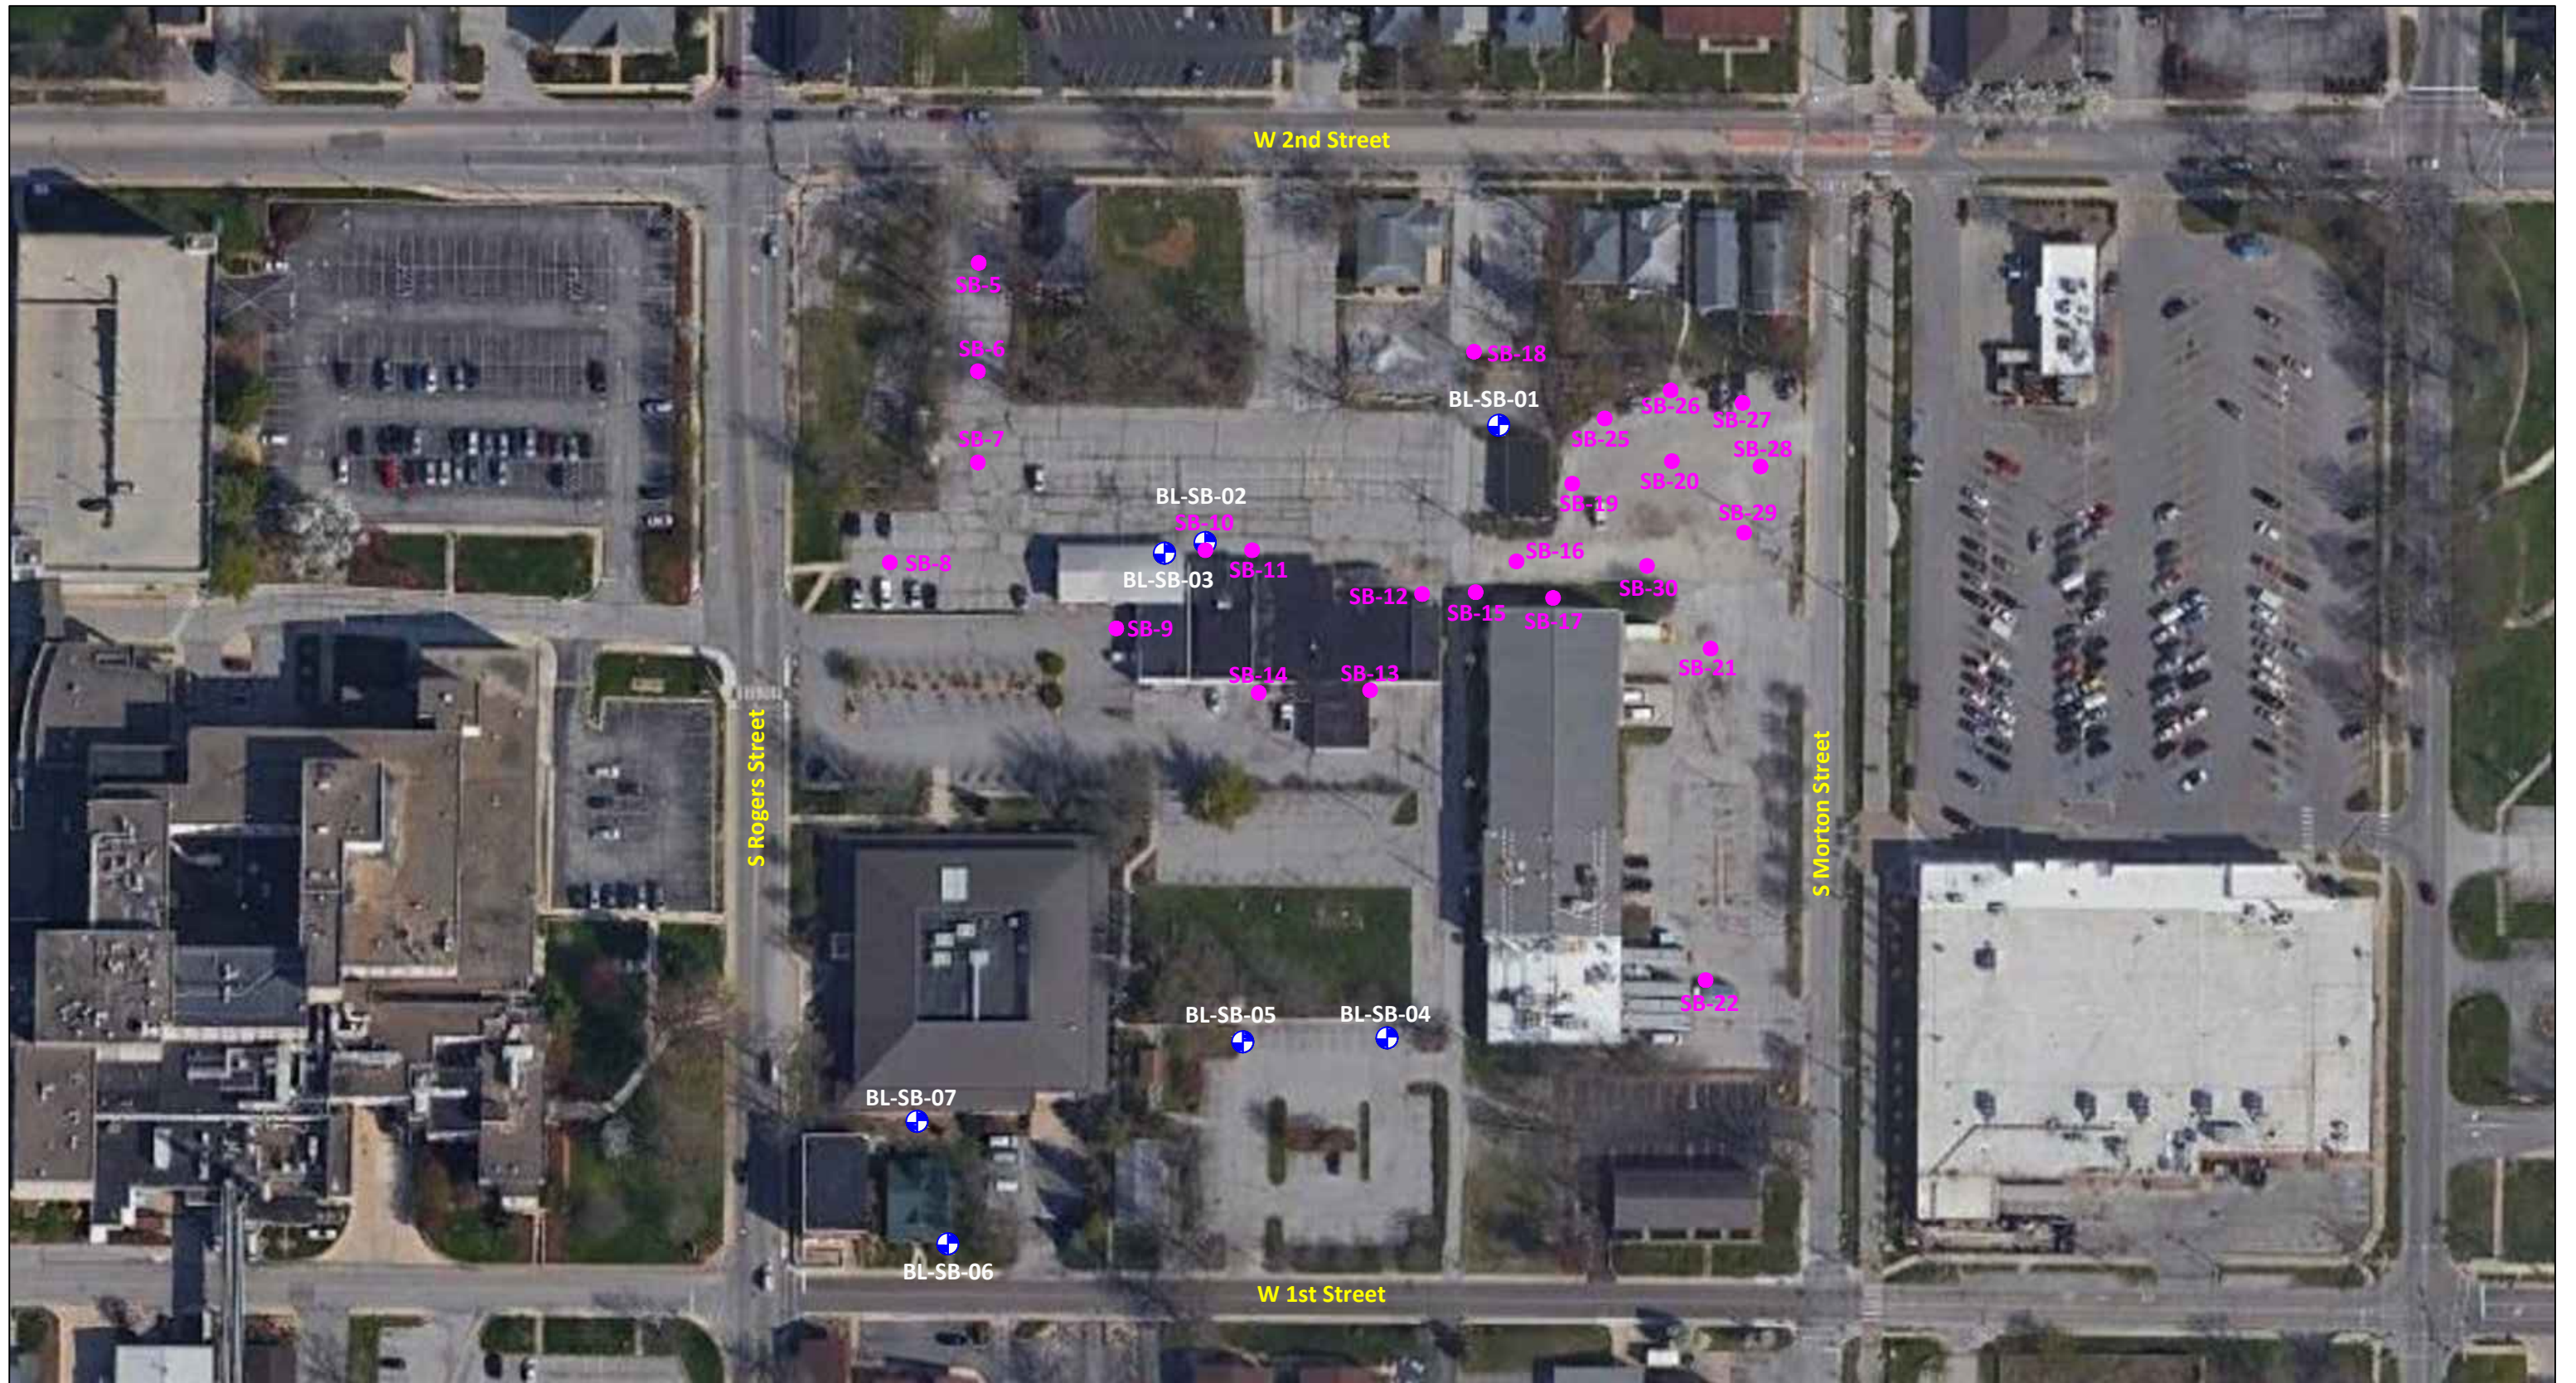



Source: <https://monroein.elevatemaps.io/#extent=3108000.7493267483,3107334.0826600813,1425664.5816117919,1425360.3281395698,2245>


Exhibit 3 - Soil Boring Locations

Soil Management Plan


630 S. Morton Street, 653 S. Rogers Street and 411 W. 1st Street
 Bloomington, Monroe County, Indiana
 Metric Project # 21-0098

Note: All locations are approximate

-  Metric Boring Location
-  August Mack Boring Locations

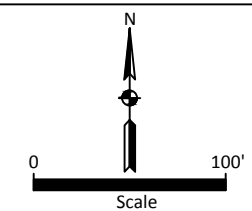

Drawn by: ILJ
 Checked by: JB
 Approved by: PL
 Date: February, 2022

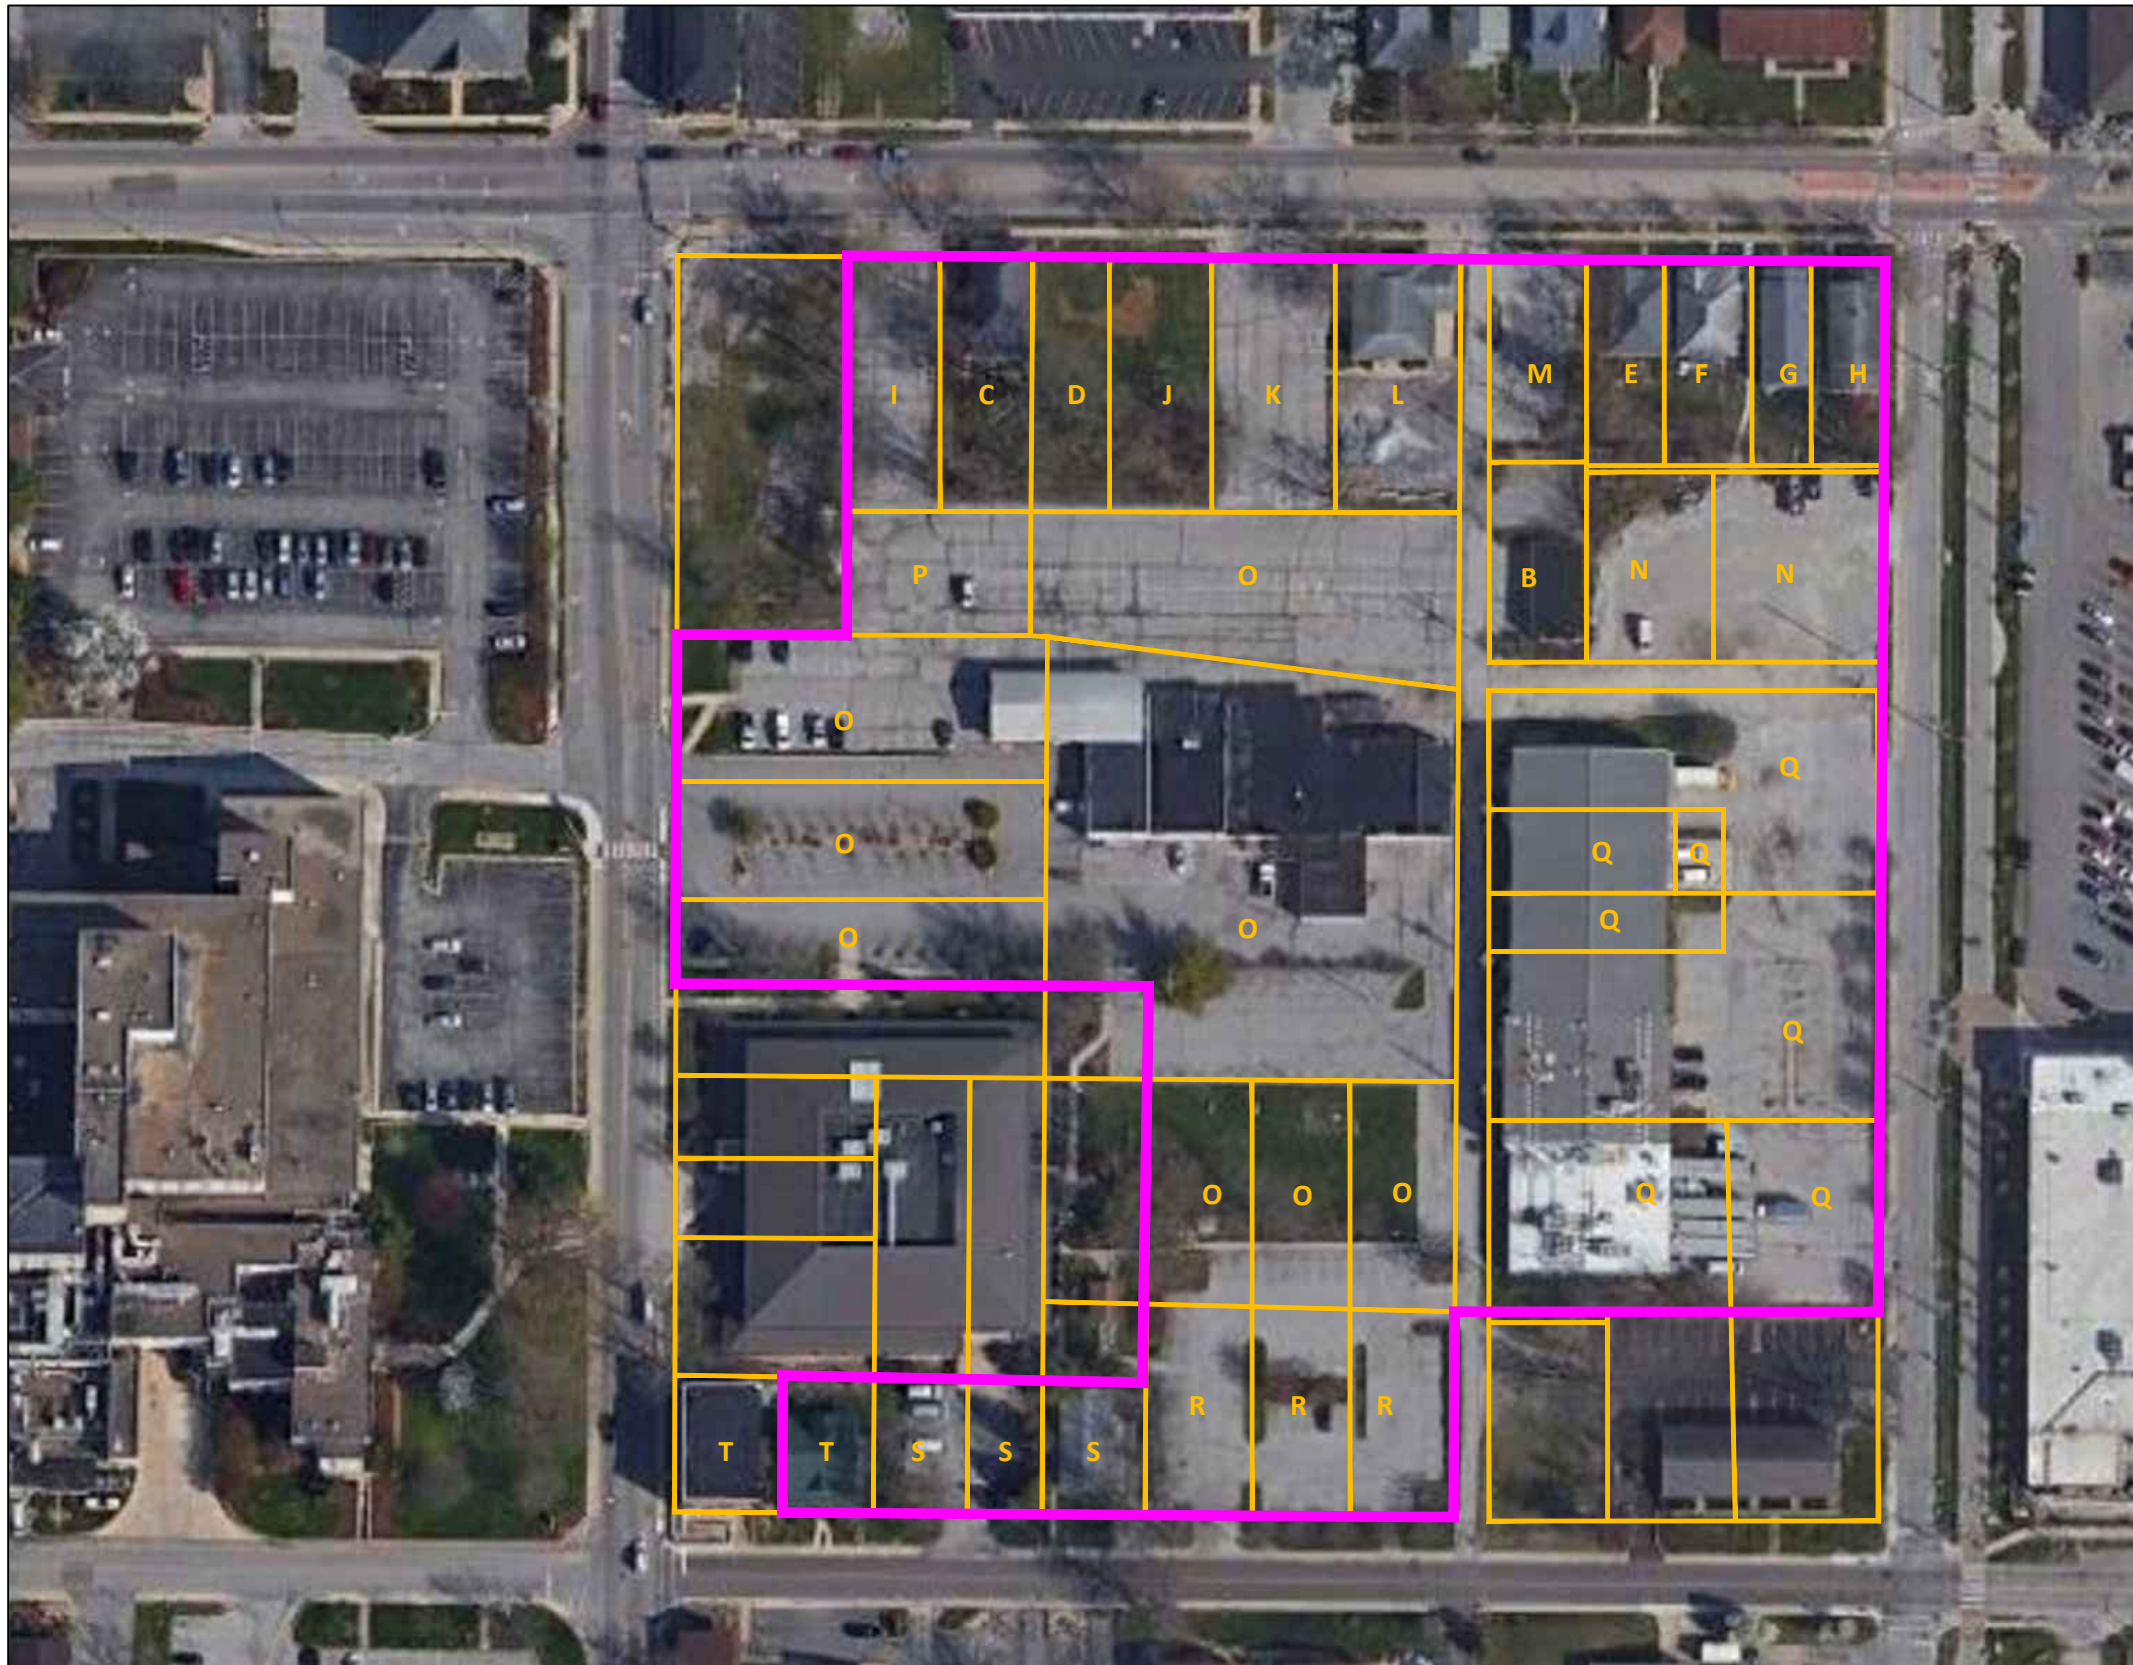

ID #	Address	Parcel #
B	605 S Madison, Bloomington, IN 47403	53-08-05-100-129.000-009
C	409 W 2nd St., Bloomington, IN 47403	53-08-05-100-081.000-009
D	407 W 2nd St., Bloomington, IN 47403	53-08-05-100-047.000-009
E	313 W 2nd St., Bloomington, IN 47403	53-08-05-100-118.000-009
F	311 W 2nd St., Bloomington, IN 47403	53-08-04-200-182.000-009
G	303 W 2nd St., Bloomington, IN 47403	53-08-04-200-136.000-009
H	301 W 2nd St., Bloomington, IN 47403	53-01-55-251-000.000-009
I	411 W 2nd St., Bloomington, IN 47403	53-08-05-100-048.000-009
J	403 W 2nd St., Bloomington, IN 47403	53-08-05-100-053.000-009
K	401 W 2nd St., Bloomington, IN 47403	53-08-05-100-069.000-009
L	321 W 2nd St., Bloomington, IN 47403	53-08-05-100-052.000-009
M	W 2nd St., Bloomington, IN 47403	53-08-05-100-130.000-009
N	W 2nd St., Bloomington, IN 47403	53-01-56-030-000.000-009
O	635 S Rogers St., Bloomington, IN 47403	53-08-05-100-056.000-009
P	407 W 2nd St., Bloomington, IN 47403	53-08-05-100-128.000-009
Q	640 S Morton St., Bloomington, IN 47403	53-08-05-100-113.000-009
R	400 W 1st St., Bloomington, IN 47403	53-08-05-100-017.000-009
S	410 W 1st St., Bloomington, IN 47403	53-08-05-100-094.000-009
T	653 S Rogers St., Bloomington IN 47403	53-08-05-100-034.000-009

Source: <https://monroein.elevatemaps.io/#extent=3108000.7493267483,3107334.0826600813,1425664.5816117919,1425360.3281395698,2245>


Exhibit 4 - SMP Area

Soil Management Plan


630 S. Morton Street, 653 S. Rogers Street and 411 W. 1st Street
 Bloomington, Monroe County, Indiana
 Metric Project # 21-0098

Note: All locations are approximate


- Parcel Lines
- SMP Area

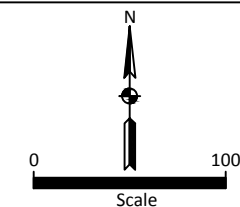

Drawn by: ILJ
 Checked by: JB
 Approved by: PL
 Date: May, 2022

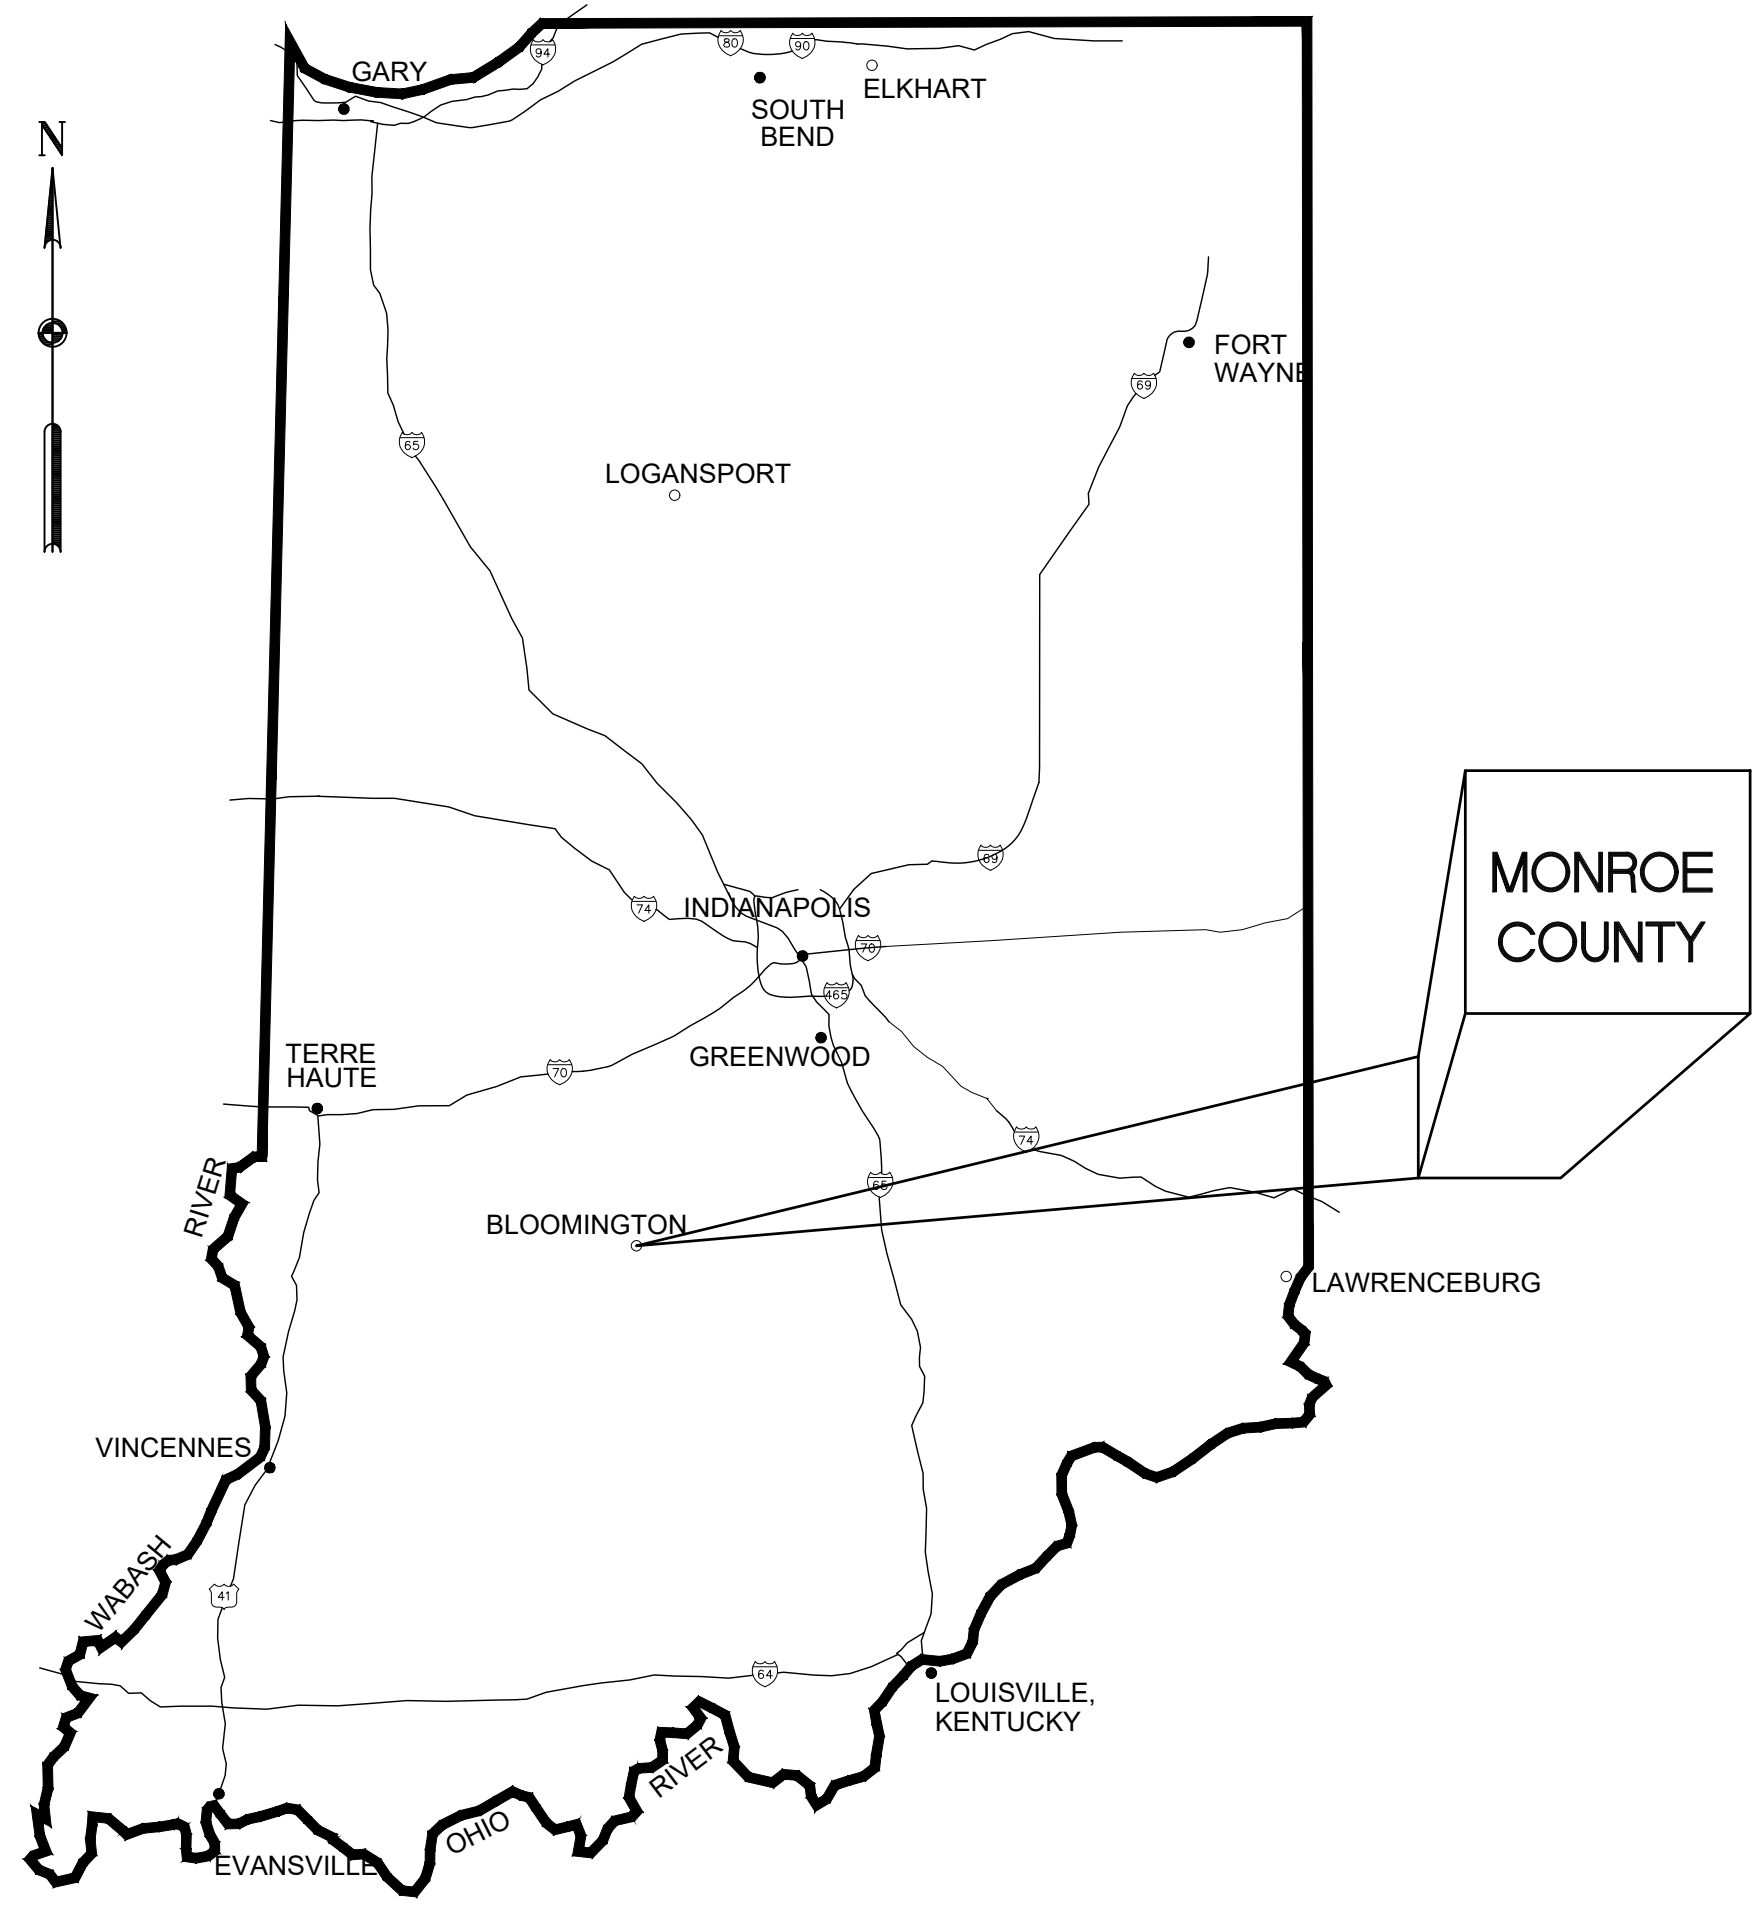

GENERAL LOCATION MAP
NOT TO SCALE

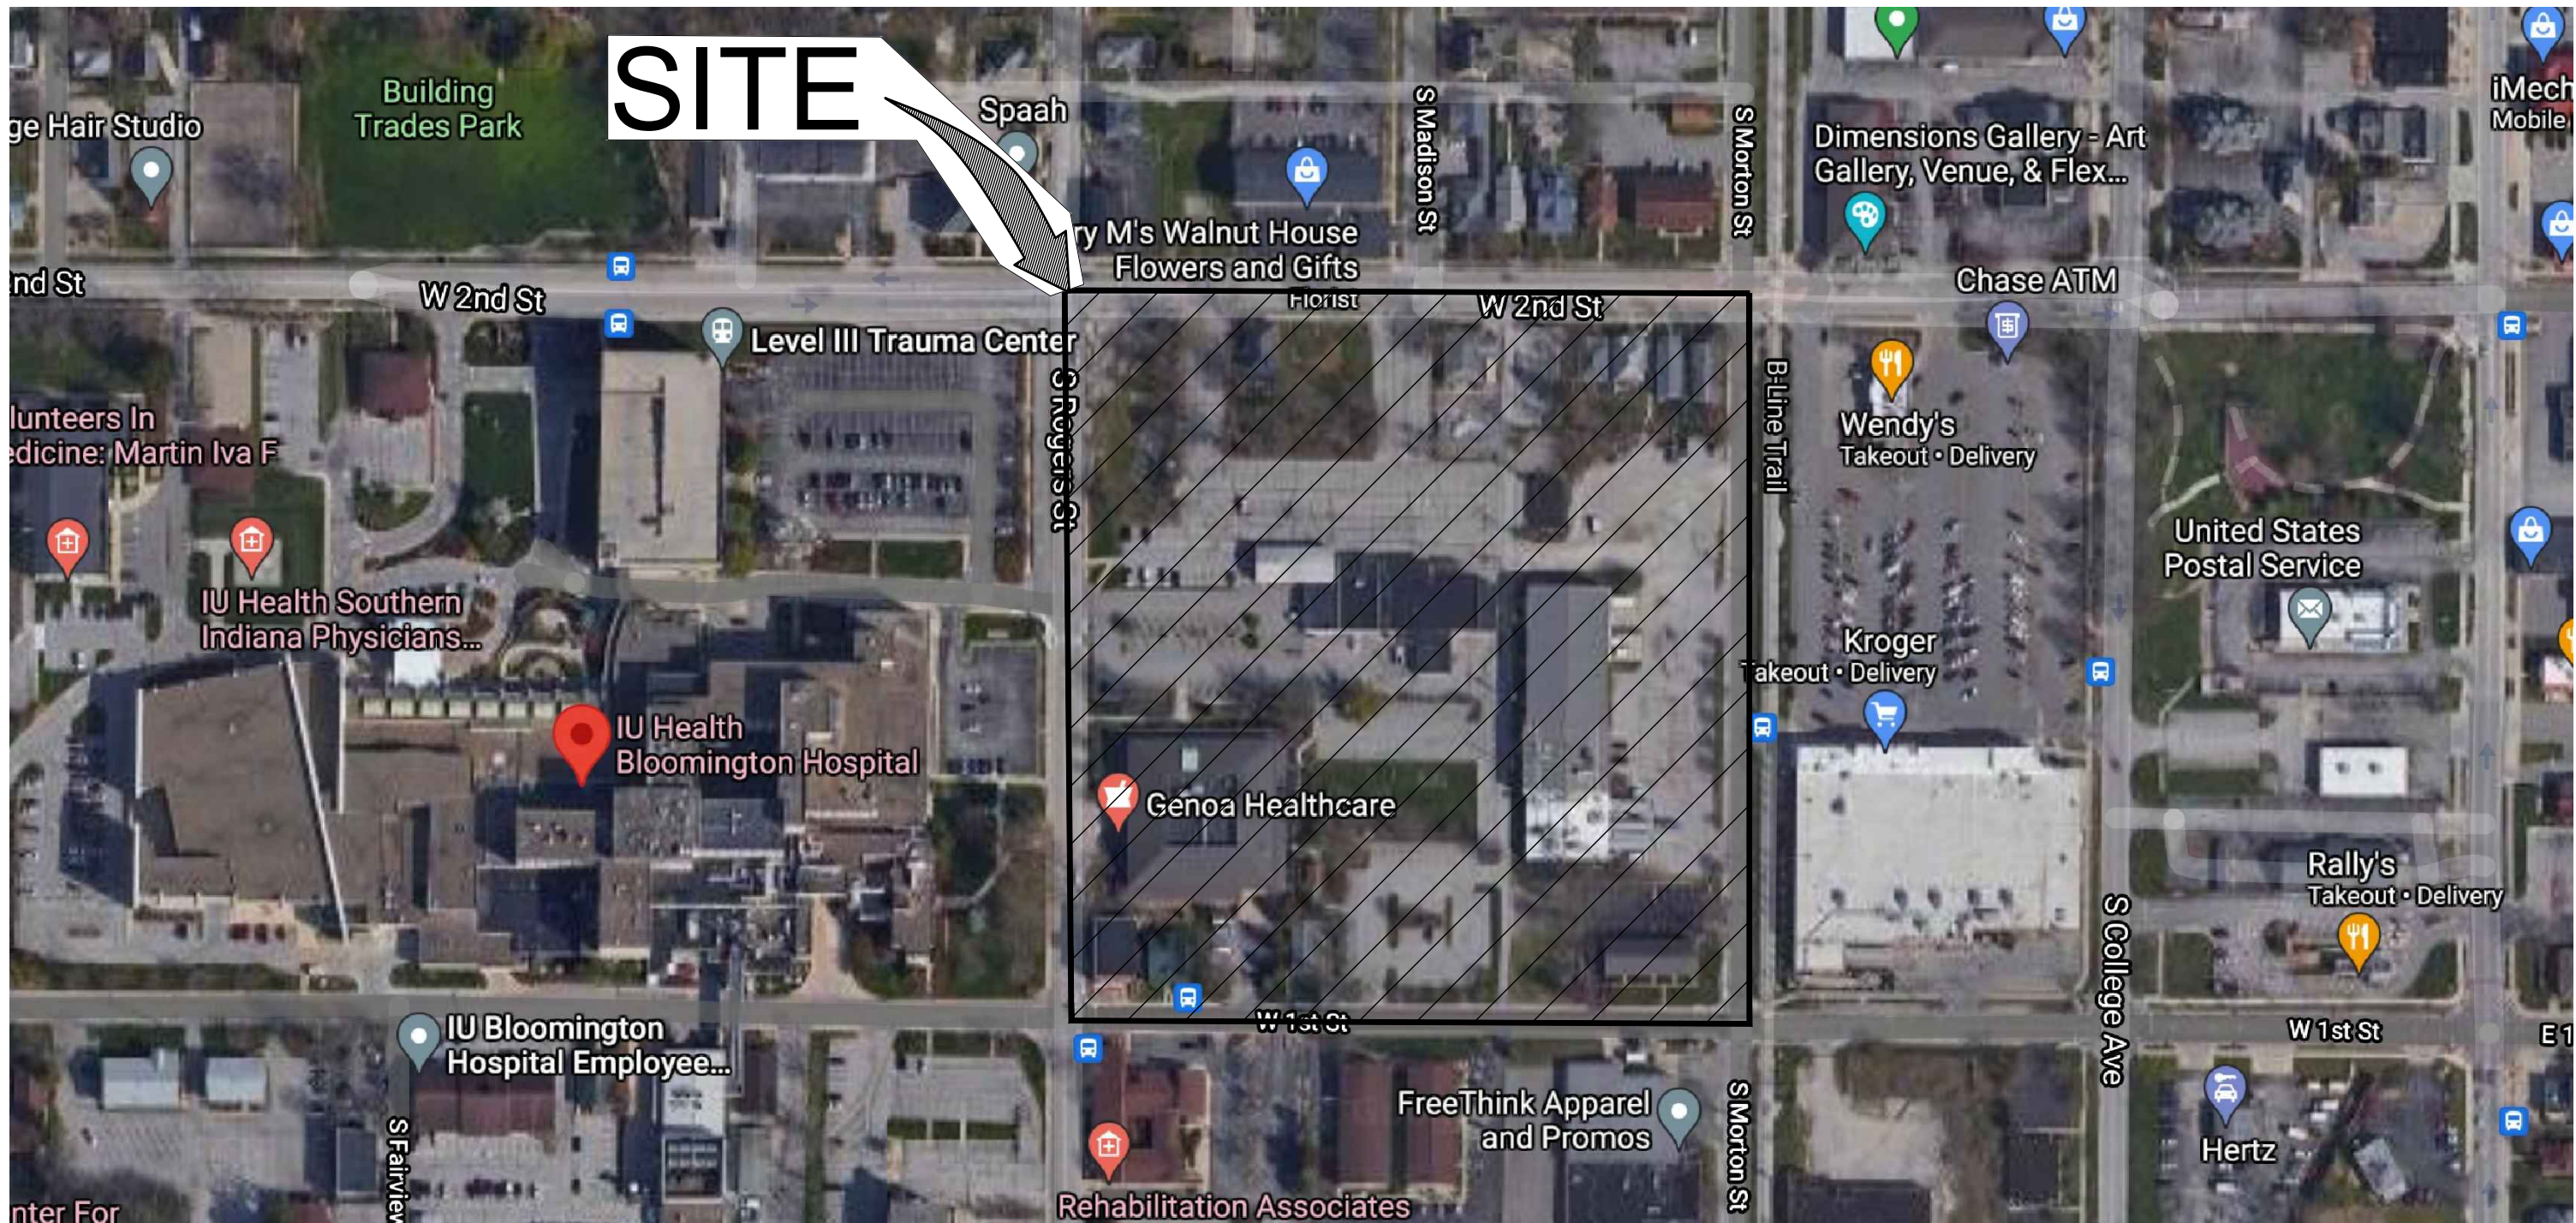


PROJECT LOCATION MAP
NOT TO SCALE

HOPEWELL PHASE 1 EAST

CONTRACT ONE: BUILDING DEMOLITION AND REMEDIATION
BLOOMINGTON, INDIANA 47403
05/20/2022

Sheet Index	
Sheet Number	Sheet Title
G100	Cover Sheet
G101	Reference Plan - Boundary Retracement Survey
G102	Reference Plan - Topographic Survey
D101	Existing Conditions and Demolition Plan - NW
D102	Existing Conditions and Demolition Plan - NE
D103	Existing Conditions and Demolition Plan - SE
D104	Existing Conditions and Demolition Plan - SW
D105	Existing Structure Data Table
C101	Stormwater Pollution Prevention Notes
C102	Stormwater Pollution Prevention Notes
C103	Stormwater Pollution Prevention Details

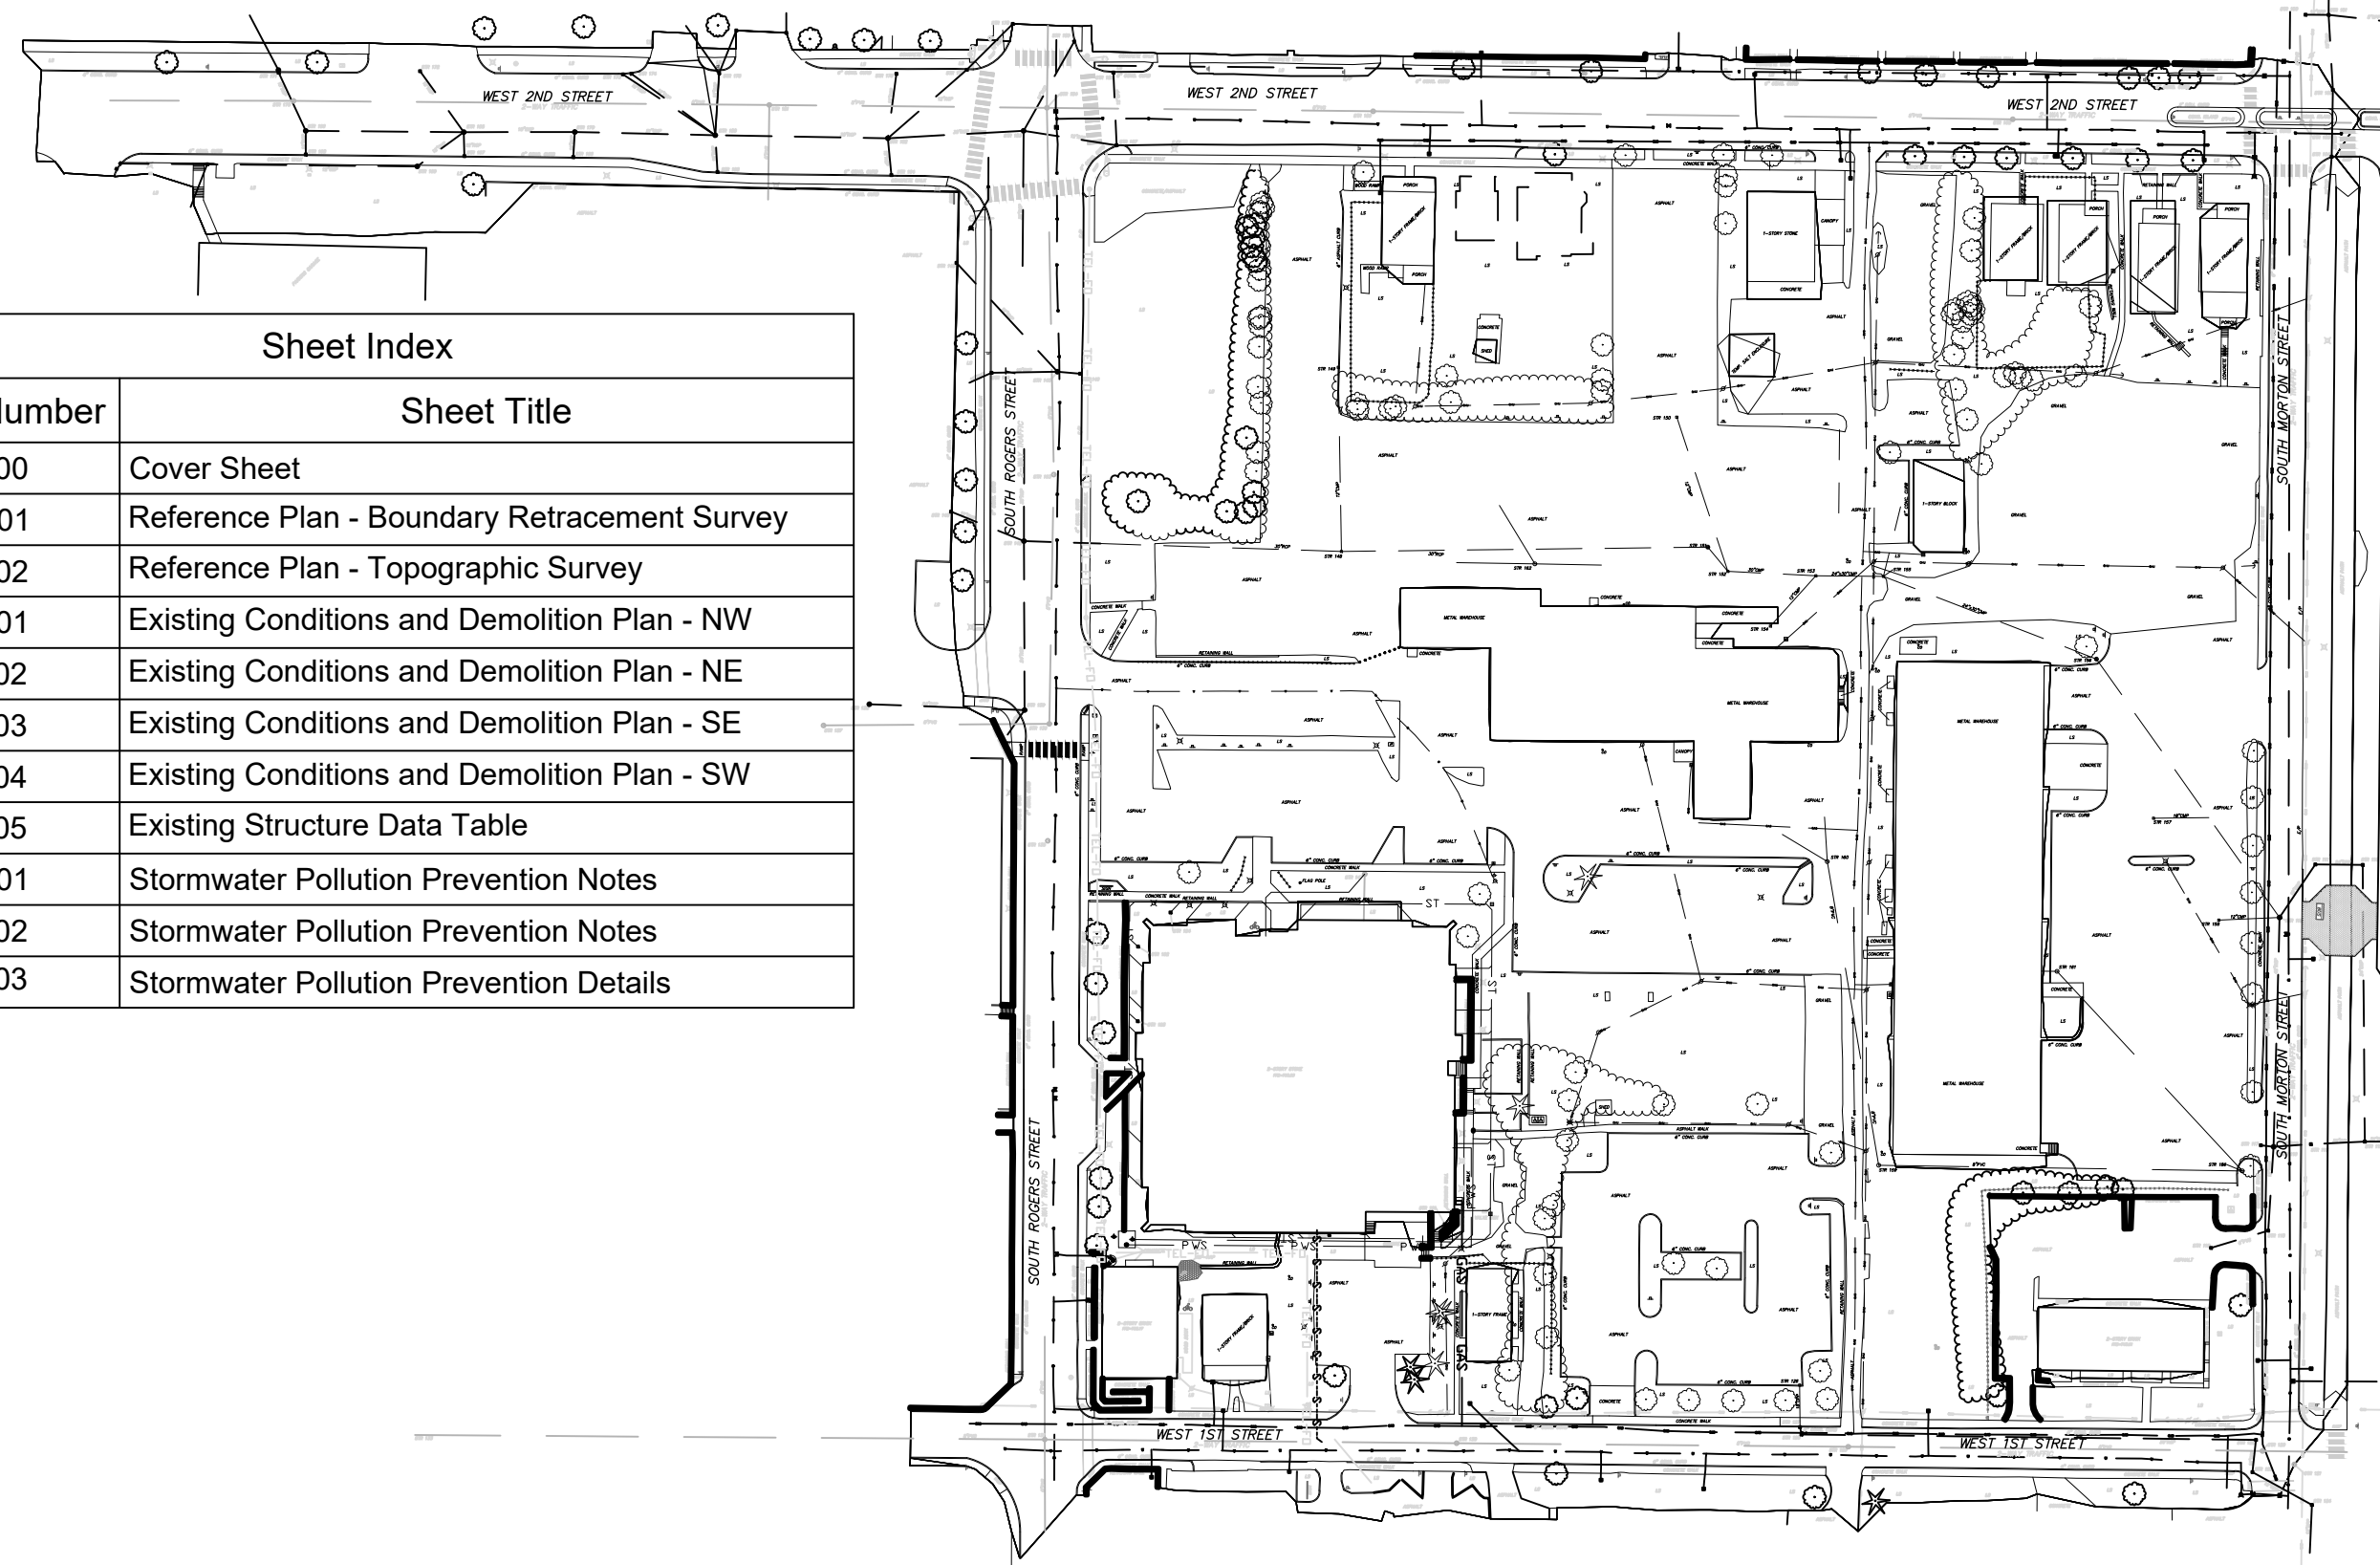

SITE MAP
SCALE = 1" = 100'

UTILITY CONTACTS:

- GAS**
Kim Burton-Kelly
Lead Account Manager
600 Industrial Dr.
Franklin, IN 46131
Office 317-738-2915
Cell 317-691-5649
Service Start and Termination 1-800-227-1376
Center Point Energy
Kimberly.Burton-Kelly@centerpointenergy.com
- ELECTRIC**
Chad Heacock, Duke Energy
Engineering Technologist II
1100 W.2nd St.
Bloomington, IN 47403
Phone: 1 812 337 3043
Cell: 1 812 332 9303
Chad.Heacock@duke-energy.com
Duke Energy service start and termination
1-800-774-0246
- WATER AND SEWER**
Nancy Axson
Project Coord - New Services
Utilities Department
City of Bloomington, IN
axsonn@bloomington.in.gov
812-349-5659
bloomington.in.gov/utilities
- AT&T**
Andrew J. Mullis
Mgr. OSP Planning & Engineering Design
Access - Construction and Engineering
4517 E Indiana Bell Ct.
Bloomington, IN 47408
M 812-239-6463
amj505@us.att.com
- Russell Owen
AT&T Bloomington Engineering
812-606-2973
ro1325@att.com
- CABLE TV**
Steve McCarroll
Steve.McCarroll@cable.comcast.com
(812)355-7822




PERMIT SET

DATE: 05/20/2022
E-MAIL: mwallace@shrewsusa.com

JOB No.
21-0049
SHEET
G100

S:\Project Files\2021\21-0049\CADD\Design\Sheet Sets\21K36 Cover Sheet - Demo.dwg 5/20/2022 4:23 PM

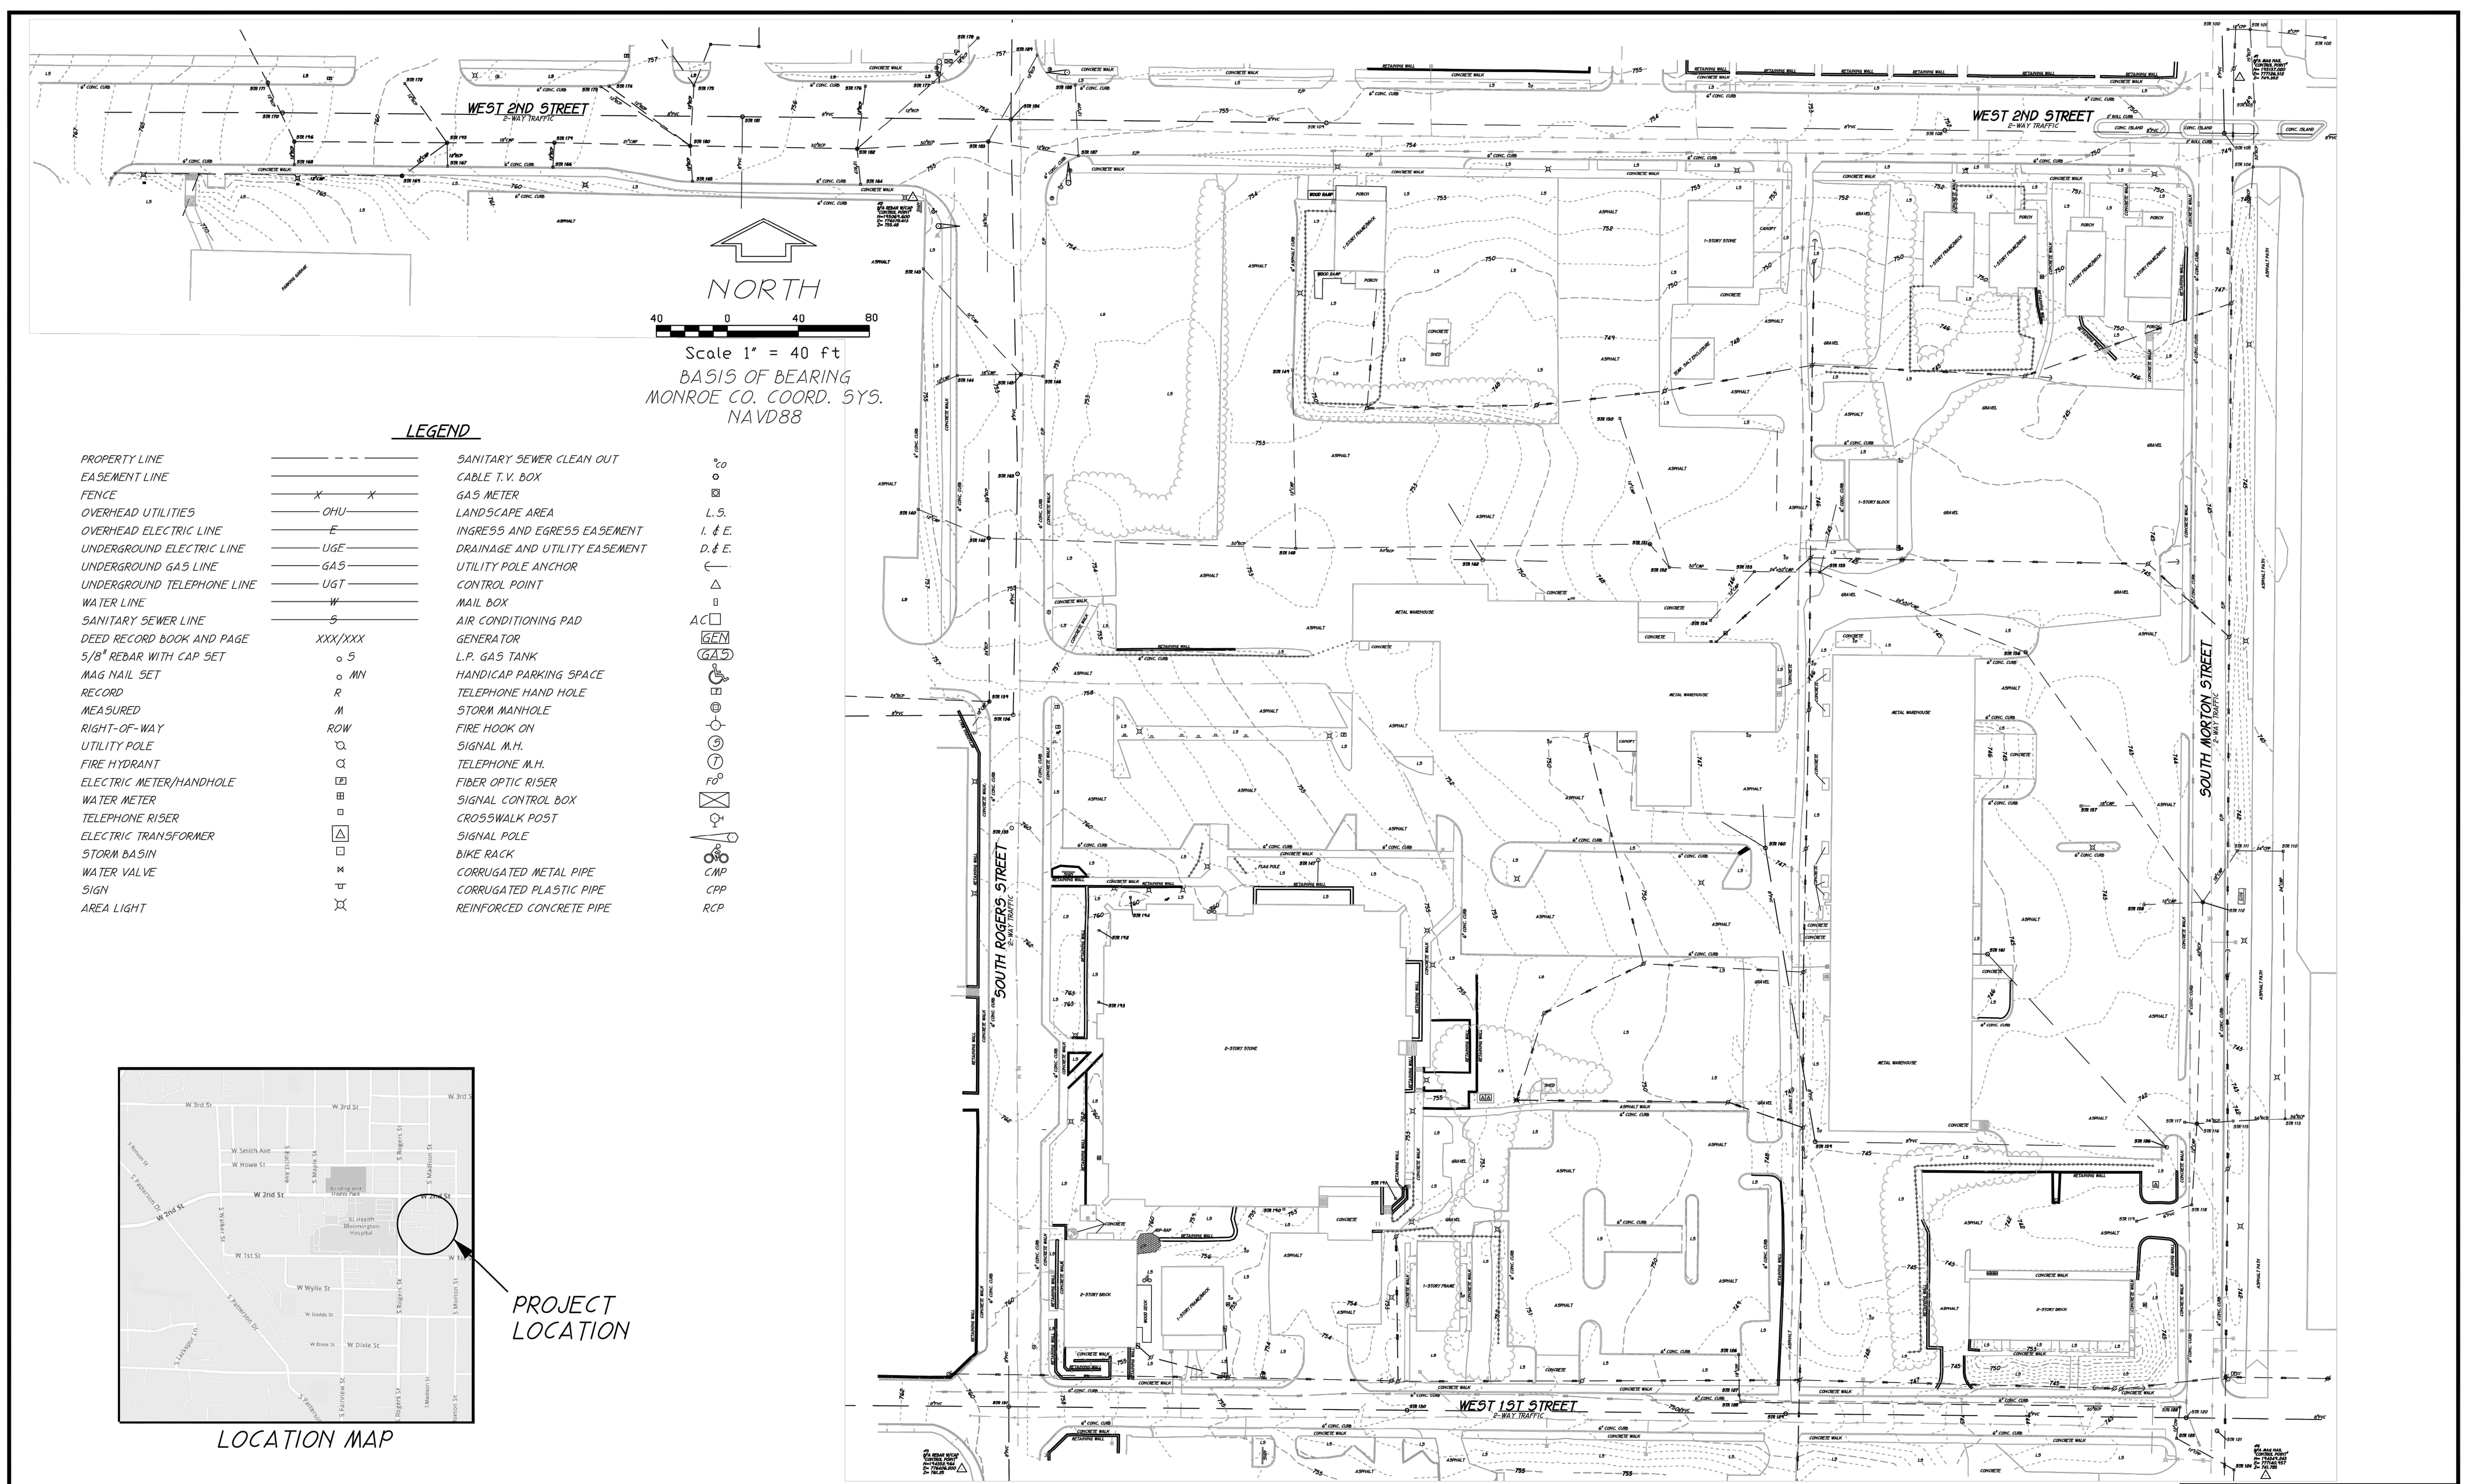

LEGEND

PROPERTY LINE	---	SANITARY SEWER CLEAN OUT	—S—S
EASEMENT LINE	- - - -	CABLE T.V. BOX	□
FENCE	X X	GAS METER	○
OVERHEAD UTILITIES	—OHU—	LANDSCAPE AREA	○
OVERHEAD ELECTRIC LINE	—E—	INGRESS AND EGRESS EASEMENT	— I. & E. —
UNDERGROUND ELECTRIC LINE	—UGE—	DRAINAGE AND UTILITY EASEMENT	— D. & E. —
UNDERGROUND GAS LINE	—GAS—	UTILITY POLE ANCHOR	△
UNDERGROUND TELEPHONE LINE	—UGT—	CONTROL POINT	□
WATER LINE	—W—	MAIL BOX	□
SANITARY SEWER LINE	—S—	AIR CONDITIONING PAD	□
DEED RECORD BOOK AND PAGE	XXX/XXX	GENERATOR	□
5/8" REBAR WITH CAP SET	○ S	L.P. GAS TANK	□
MAG NAIL SET	○ MN	HANDICAP PARKING SPACE	□
RECORD	R	TELEPHONE HAND HOLE	□
MEASURED	M	STORM MANHOLE	□
RIGHT-OF-WAY	ROW	FIRE HOOK ON SIGNAL M.H.	□
UTILITY POLE	○	TELEPHONE M.H.	□
FIRE HYDRANT	○	FIBER OPTIC RISER	□
ELECTRIC METER/HANDHOLE	□	SIGNAL CONTROL BOX	□
WATER METER	□	CROSSWALK POST	□
TELEPHONE RISER	□	SIGNAL POLE	□
ELECTRIC TRANSFORMER	□	BIKE RACK	□
STORM BASIN	□	CORRUGATED METAL PIPE	—
WATER VALVE	□	CORRUGATED PLASTIC PIPE	—
SIGN	□	REINFORCED CONCRETE PIPE	—
AREA LIGHT	□		



PROJECT LOCATION

LOCATION MAP

EXISTING SITE CONDITIONS
BHRU INFRASTRUCTURE
& SITE WORK

DRAWING NO. 50210584
SHEET 1 OF 2

PREPARED BY BYNUM FANYO & ASSOCIATES, INC. 528 N. WALNUT ST. BLOOMINGTON, IN. 47404

NO.	DATE	DESCRIPTION
1	05/16/22	SEEDING/MULCHING LIMITS
2	05/20/22	PLAN REVISIONS

CLIENT:

Bloomington, IN 47403

DESIGN TEAM

ARCHITECTURAL
CIVIL ENGINEERING
PLANNING
LAND SURVEYING

CERTIFIED BY

Matthew D. Wallace
REGISTERED PROFESSIONAL ENGINEER
No. 10302418
STATE OF INDIANA

© COPYRIGHTED BY SHREWSBERRY AND ASSOCIATES

HOPEWELL SUBDIVISION REDEVELOPMENT PROJECT

CITY OF BLOOMINGTON
BLOOMINGTON, INDIANA 47403

DATE: 03/30/2022	PROJECT NO.: 21-0049
DRAWN BY: RDR	CHECKED BY: MDW
DRAWING STATUS:	

PERMIT SET

SHEET TITLE:
REFERENCE PLAN - TOPOGRAPHIC SURVEY



SHEET NO.:


G102



REFERENCE PLAN

Scale: 1" = 40'-0"

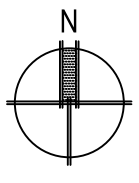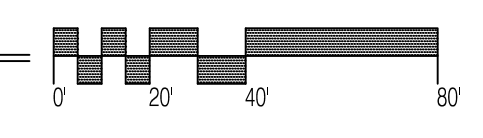

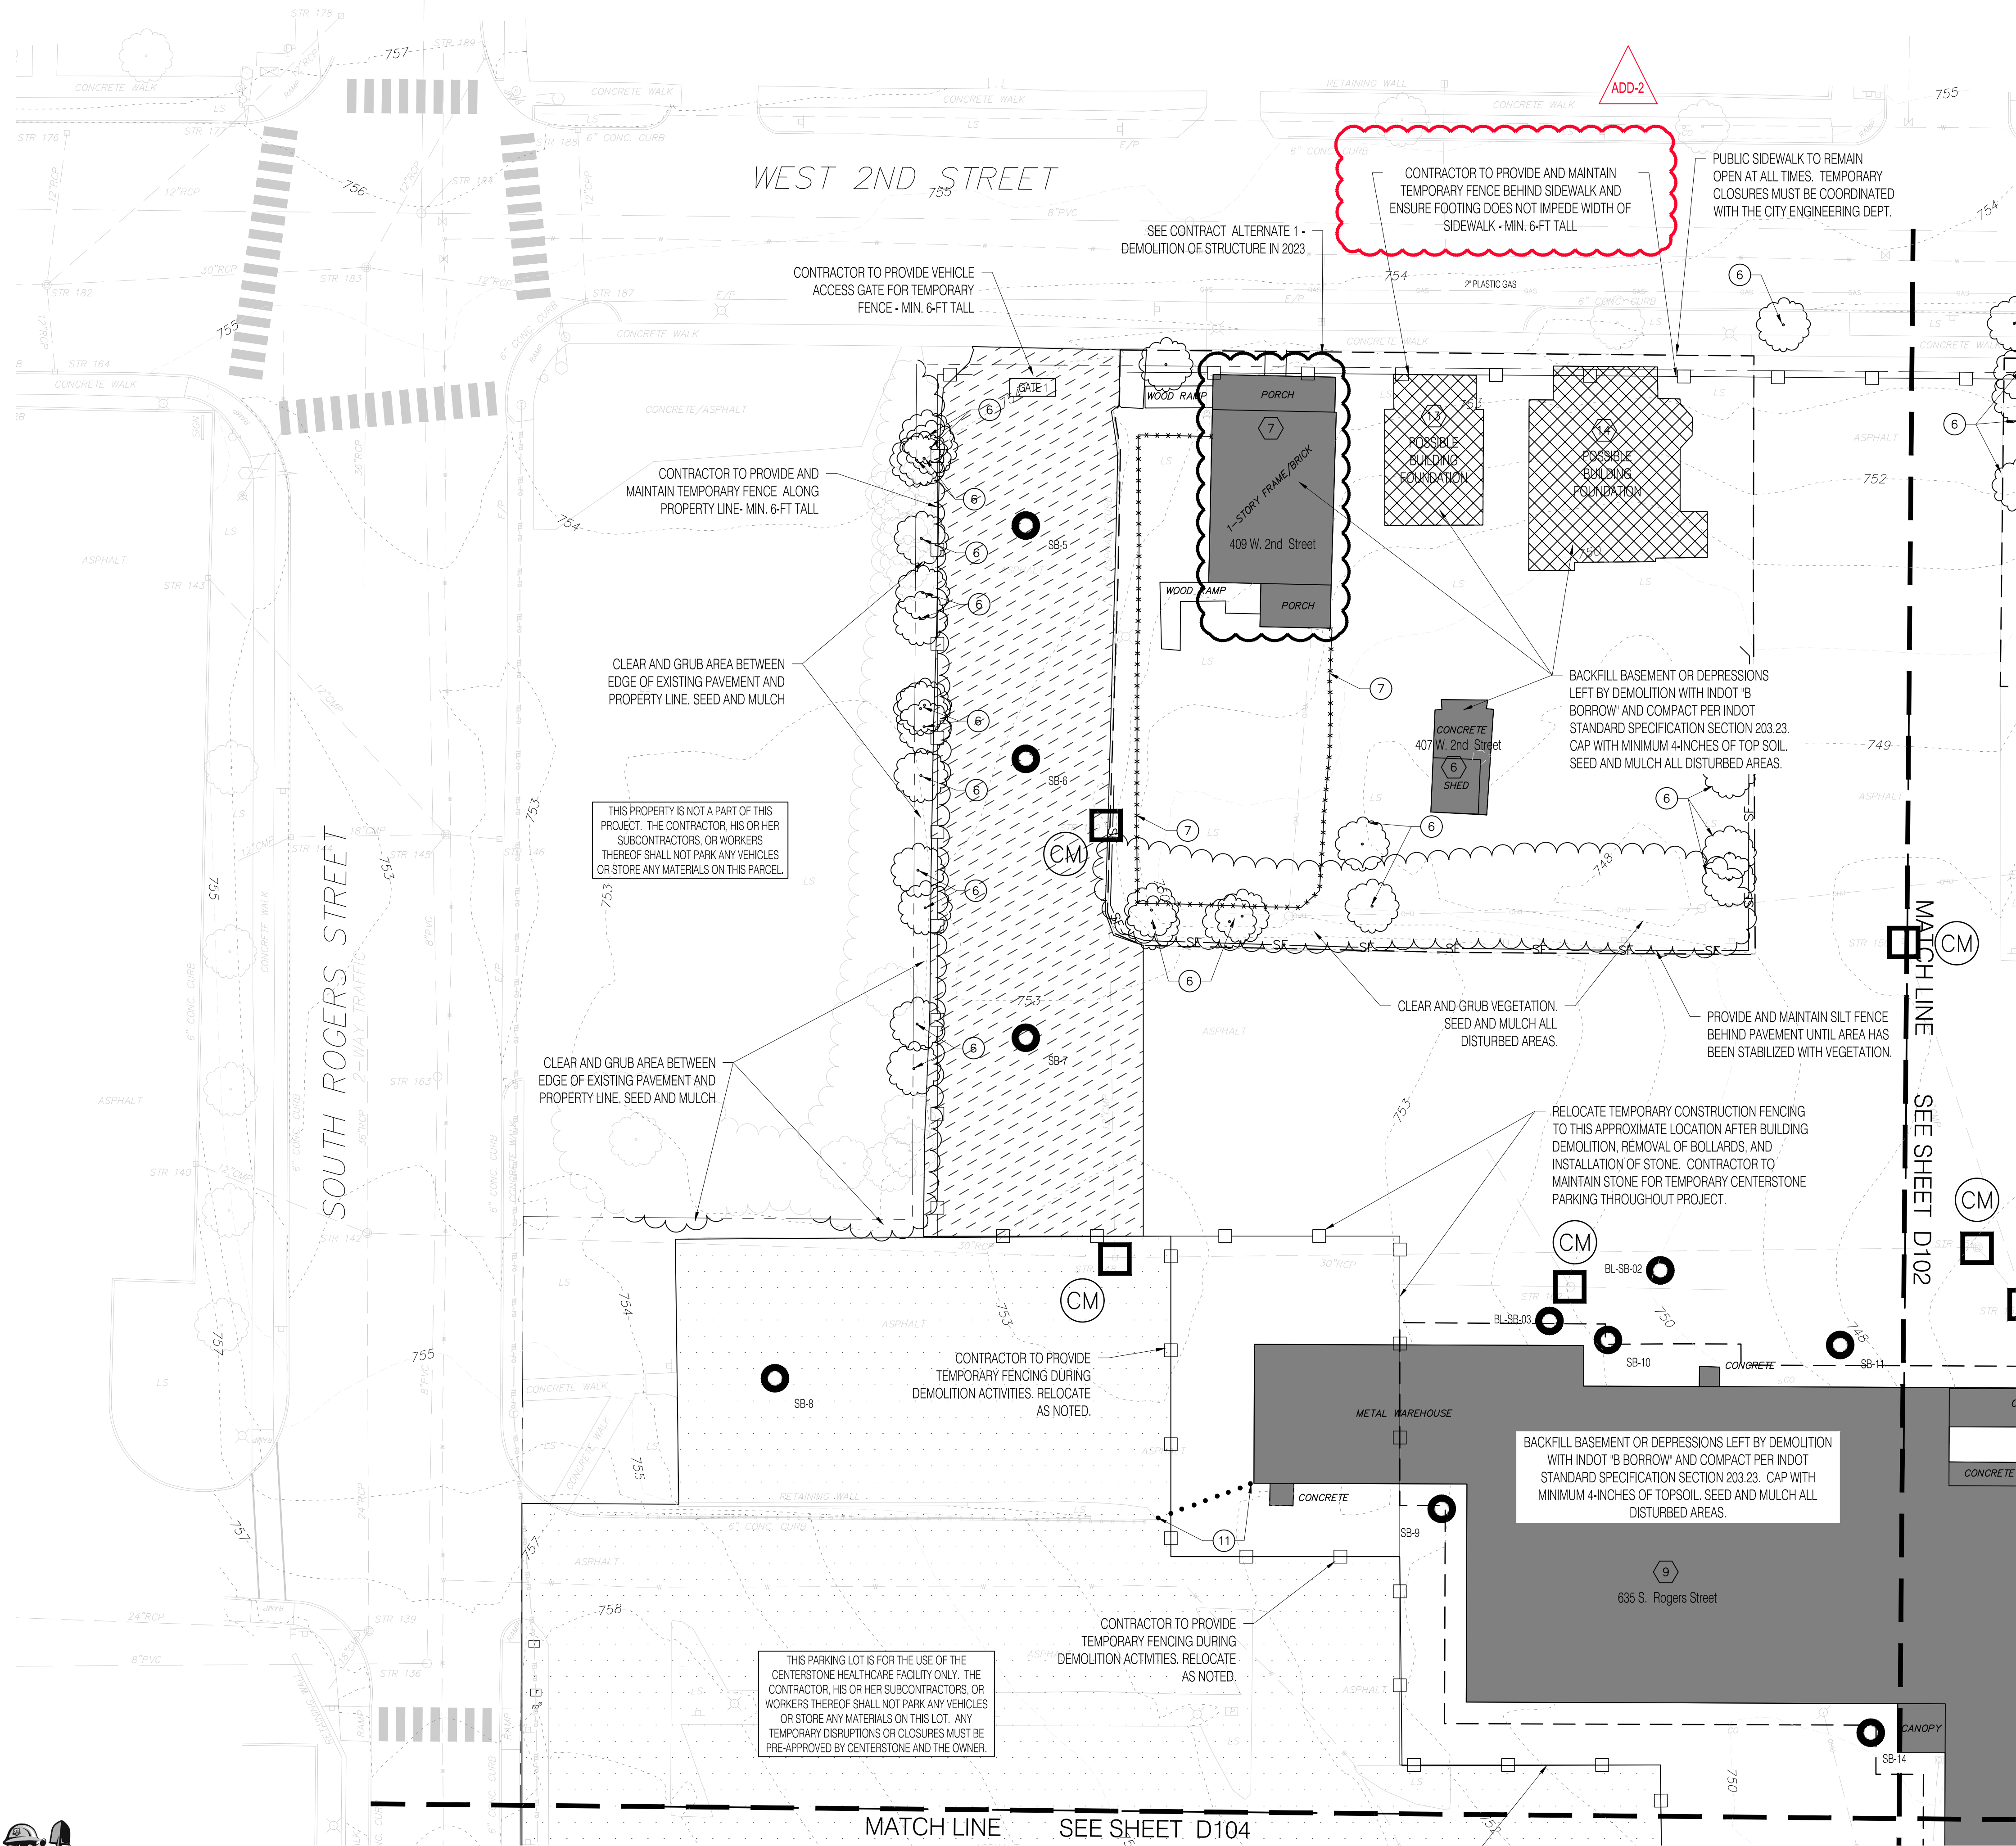

GENERAL DEMOLITION NOTES

1. THE CONTRACTOR IS CAUTIONED THAT THE LOCATIONS AND/OR ELEVATIONS OF EXISTING UTILITIES AS SHOWN ON THESE PLANS IS BASED ON THE RECORDS OF VARIOUS UTILITY COMPANIES AND WHERE POSSIBLE, MEASUREMENTS TAKEN IN THE FIELD. THIS INFORMATION IS NOT TO BE RELIED UPON AS BEING EXACT OR COMPLETE. THE CONTRACTOR IS RESPONSIBLE FOR THE ACCURATE LOCATION OF ALL UTILITIES AND HAZARDOUS WHETHER SHOWN OR NOT. THE CONTRACTOR MUST CONTACT THE APPROPRIATE UTILITY COMPANY AT LEAST 48 HOURS PRIOR TO ANY EXCAVATION TO REQUEST EXACT FIELD LOCATION OF UTILITIES.
2. THE CONTRACTOR SHALL COORDINATE ALL WORK ASSOCIATED WITH THE RETIREMENT OF ALL UTILITY SERVICE CONNECTIONS TO THE BUILDINGS TO BE DEMOLISHED.
3. THE CONTRACTOR SHALL INSTALL PROPER EROSION AND SEDIMENT CONTROL MEASURES PER SHEET C101 PRIOR TO COMMENCING DEMOLITION.
4. CONTRACTOR SHALL VERIFY DRAWING INFORMATION WITH EXISTING SITE CONDITIONS AND SHALL PROMPTLY REPORT CONCEALED CONDITIONS, DISCREPANCIES, AND/OR DEVIATIONS IN EXISTING CONDITIONS FROM INFORMATION SHOWN IN THE CONTRACT DOCUMENTS. THE OWNER SHALL NOT BE RESPONSIBLE FOR UNAUTHORIZED CHANGES OR EXTRA WORK REQUIRED TO CORRECT UNREPORTED DISCREPANCIES.
5. ANY AND ALL MATERIALS REMOVED FROM THE SITE SHALL BE DISPOSED OF IN A PROPER AND LEGAL MANNER AS REQUIRED BY ALL AUTHORITIES HAVING JURISDICTION.
6. DAMAGES TO EXISTING IMPROVEMENTS SHALL BE RESTORED, RECONSTRUCTED, OR REPLACED BY THE CONTRACTOR WITH NO ADDITIONAL PAYMENT MADE BY THE OWNER.
7. COORDINATE TREE REMOVAL IN PUBLIC RIGHT-OF-WAY WITH URBAN FORESTER (ERIN HATCH: ERIN.HATCH@BLOOMINGTON.IN.GOV)
8. PERIMETER FENCING CANNOT HAVE BARBED OR SECURITY WIRE, SHARPENED SPIKES, ELECTRIFIED WIRES, OR ANYTHING SIMILAR TO THESE LISTED ITEMS.

DEMOLITION LEGEND

- EXISTING BUILDING, FOUNDATION, AND SLABS TO BE REMOVED IN ACCORDANCE WITH INDOT STANDARD SPECIFICATIONS, SECTION 202 - REMOVAL OF STRUCTURES AND OBSTRUCTIONS. SEE PROJECT MANUAL APPENDIX A FOR THE LOCAL DEMOLITION PERMITS, APPENDIX B FOR THE REQUIRED IDEM NOTIFICATION FORMS, AND APPENDIX C FOR THE PRE-DEMOLITION INSPECTIONS REPORTS FOR ASBESTOS CONTAINING MATERIALS (ACM), LEAD BASED PAINT, AND HAZARDOUS MATERIALS.
- AERIAL PHOTOGRAPHY INDICATES RESIDENTIAL STRUCTURES AT THIS LOCATION. CONTRACTOR TO POT-HOLE MINIMUM THREE (3) LOCATIONS TO VERIFY REMOVAL OF BASEMENTS AND FOUNDATIONS. REMOVE ANY REMAINING MATERIALS.

ID#	ADDRESS
1	301 W 2nd St
2	303 W 2nd St
3	311 W 2nd St
4	313 W 2nd St
5	321 W 2nd St
6	407 W 2nd St
7	409 W 2nd St
8	605 S Madison St
9	635 S Rogers St
10	640 S Morton St
11	653 S Rogers St
12	408 W 1st St

- CONTRACTOR TO KEEP AND MAINTAIN THIS PAVEMENT AREA FOR OWNER, ENGINEER, INSPECTOR, AND WORKER PARKING THROUGHOUT CONTRACT.
- CENTERSTONE PARKING LOT TO REMAIN IN SERVICE THROUGHOUT CONTRACT.

DEMOLITION KEYNOTES:

- 3 EXISTING CONCRETE WALK TO BE REMOVED.
- 6 EXISTING TREE OR STUMP TO BE REMOVED.
- 7 EXISTING FENCE TO BE REMOVED.
- 8 EXISTING RETAINING WALL TO BE REMOVED.
- 11 EXISTING BOLLARD TO BE REMOVED. TO BE INCLUDED IN THE COST OF DEMOLITION OF THE ADJACENT WAREHOUSE, 635 S ROGERS ST., STR. ID# 9
- 23 EXISTING 6,000 GALLON UNDERGROUND STORAGE TANK TO BE REMOVED BY OTHERS

EROSION & SEDIMENT CONTROL LEGEND

- TEMPORARY SILT FENCE
- PROTECTION FENCING
- LIMITS OF SEEDING AND MULCHING
- TEMPORARY SURFACE INLET PROTECTION - COIR MAT. SEE DESCRIPTION ON SWPPP INFORMATION SHEET AND DETAIL ON SWPPP DETAIL SHEET.
- TEMPORARY CONSTRUCTION ENTRANCE. SEE DESCRIPTION ON SWPPP INFORMATION SHEET AND DETAIL ON SWPPP DETAIL SHEET.
- SOIL BORING LOCATION

NO	DATE	DESCRIPTION	SEEDING/MULCHING LIMITS	PLAN REVISIONS
1	05/16/22			
2	05/20/22			

CITY OF BLOOMINGTON
Bloomington, IN 47403

shrewsberry
REAA
ARCHITECTURAL
CIVIL ENGINEERING
PLANNING
LAND SURVEYING

CERTIFIED BY
MATTHEW D. WALLACE
REGISTERED
No. 10302418
STATE OF INDIANA
PROFESSIONAL ENGINEER



HOPEWELL PHASE 1 EAST
CITY OF BLOOMINGTON
BLOOMINGTON, INDIANA 47403


DATE: 05/20/2022 PROJECT NO.: 21-0049
DRAWN BY: RDR CHECKED BY: MDW
DRAWING STATUS: PERMIT SET
SHEET TITLE: EXISTING CONDITIONS AND DEMOLITION PLAN - NW
SHEET NO.: D101



FLOOD NOTE:
According to Flood Insurance Rate Map (FIRM) this real estate is part of Community-Panel Number: 18106C 0141D, Effective Date: December 17, 2010.
This property is located in Zone X, an area of minimal flood hazard.
Source: FEMA

EXISTING CONDITIONS AND DEMOLITION PLAN
Scale: 1" = 20'-0"

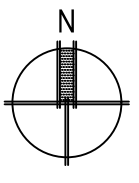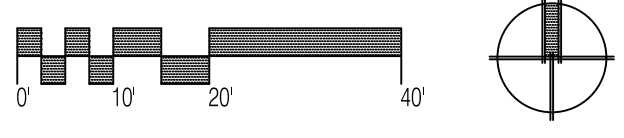

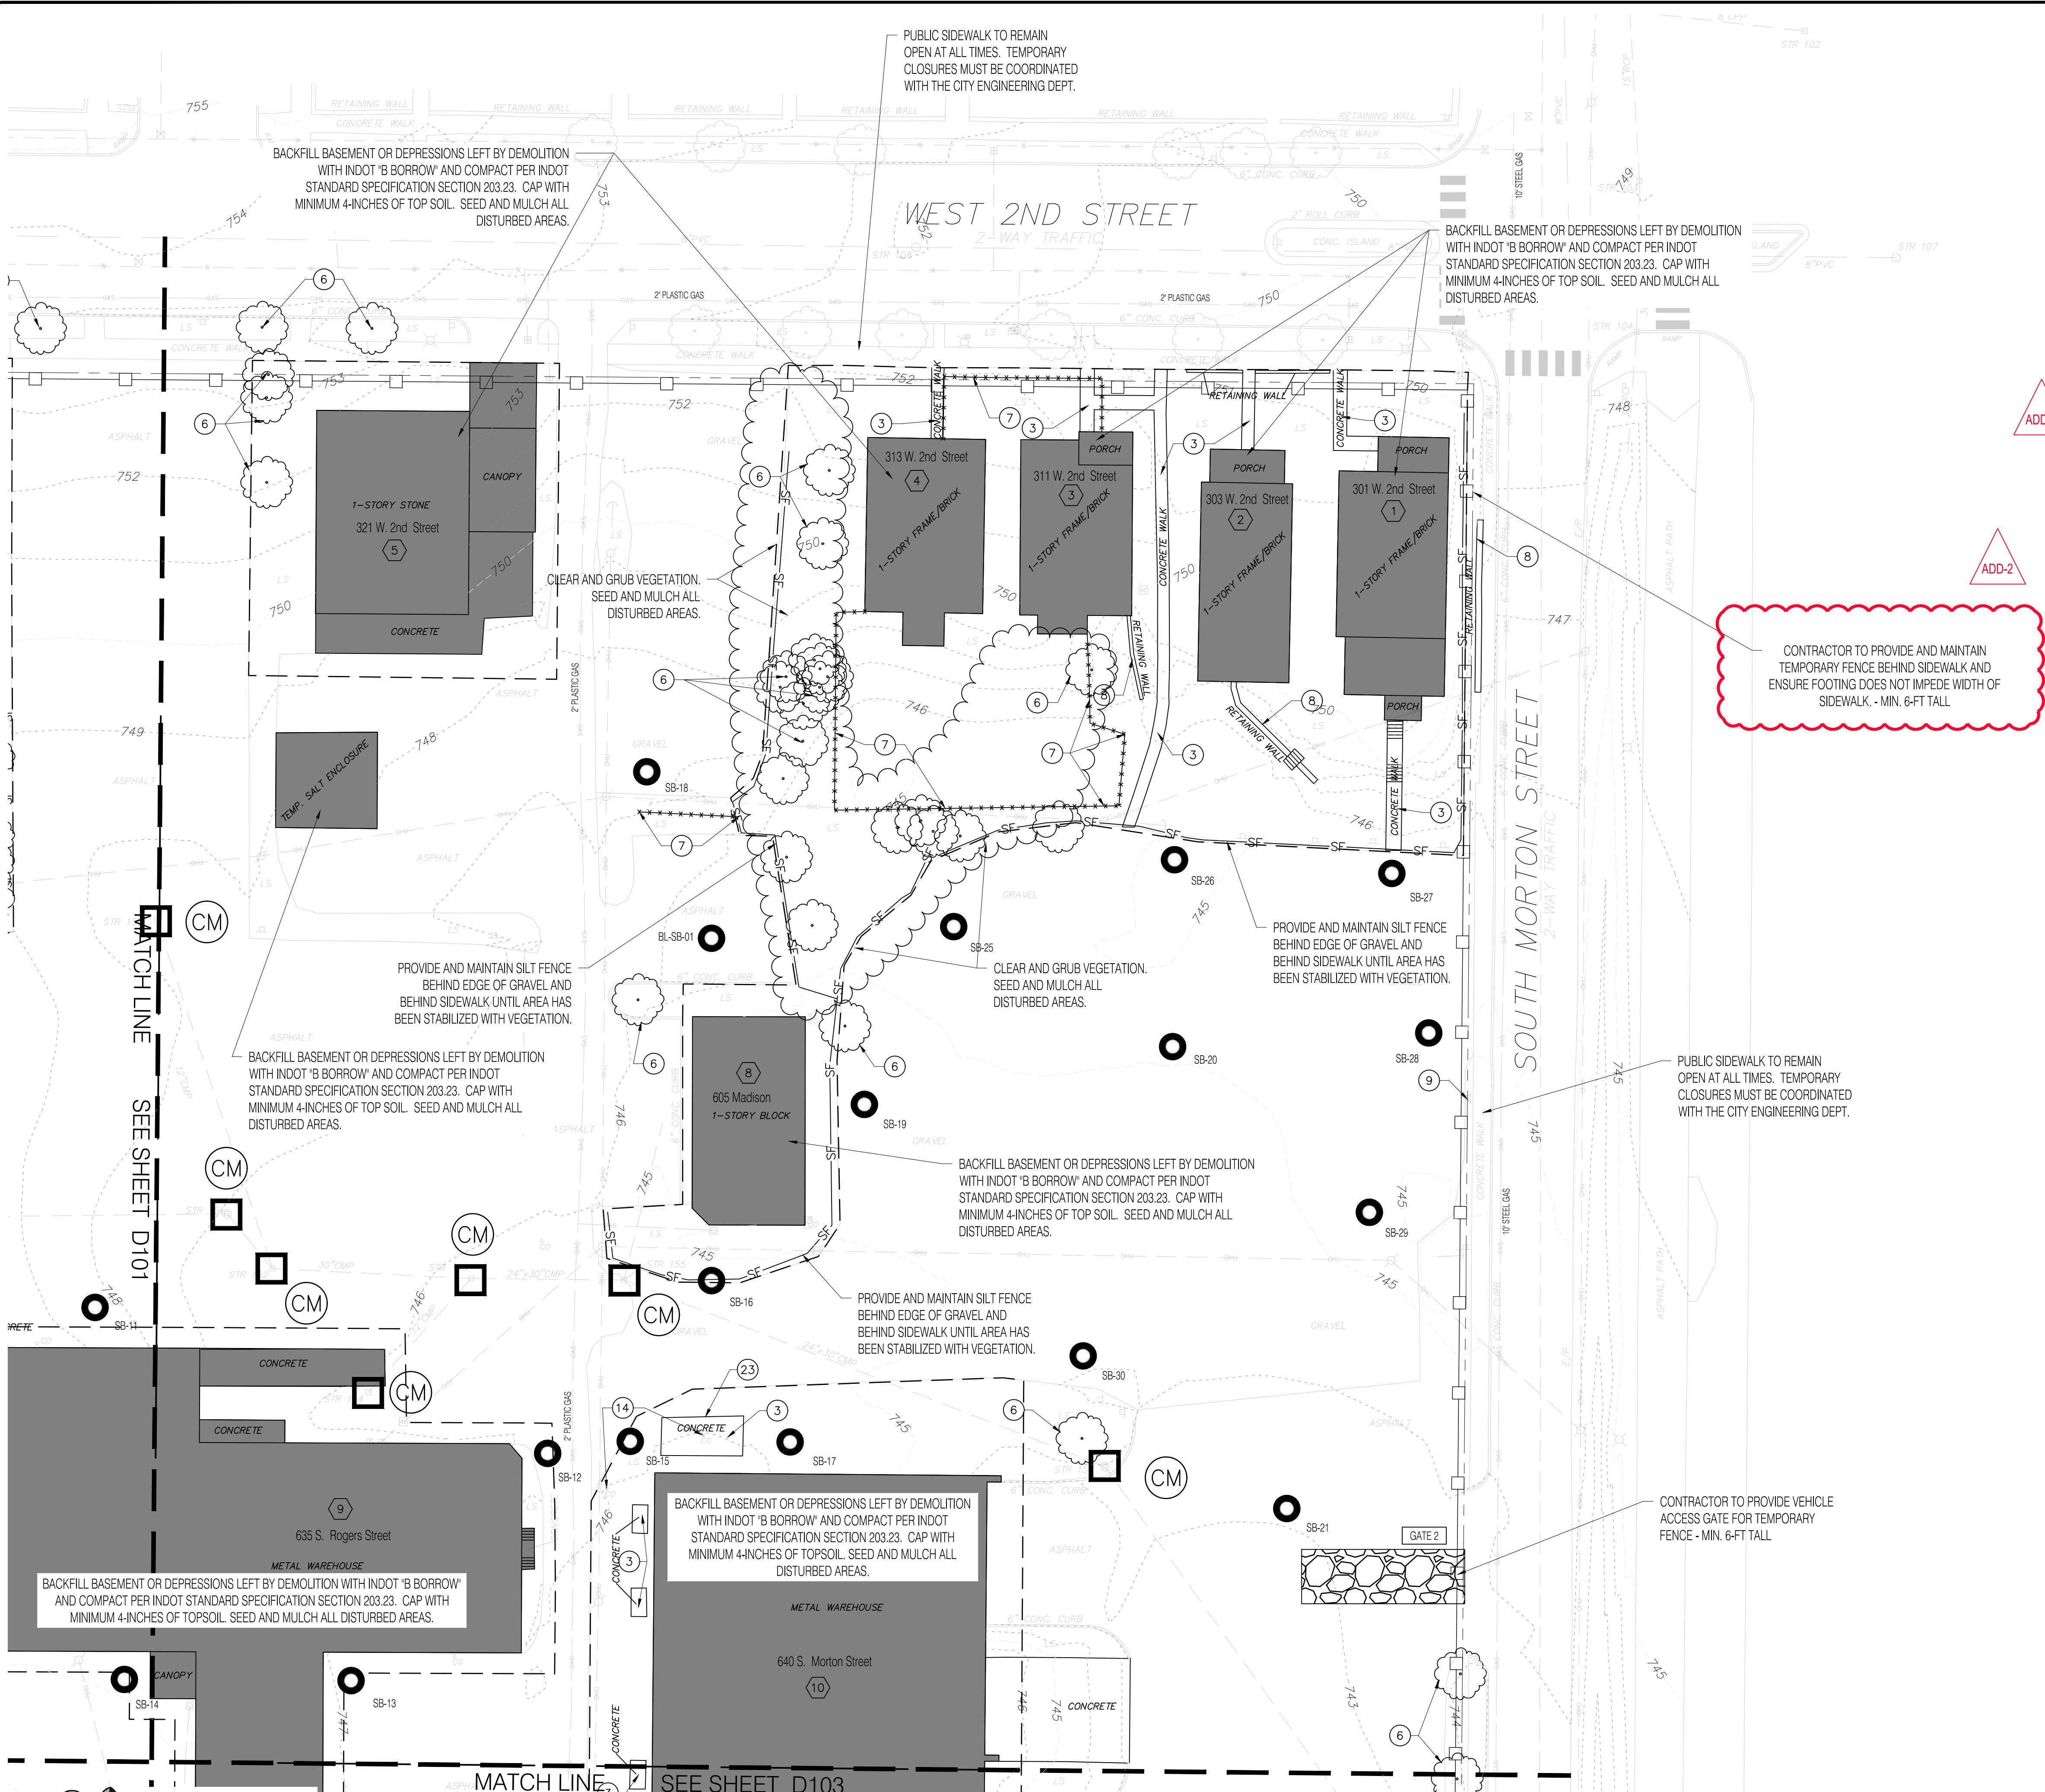

GENERAL DEMOLITION NOTES

1. THE CONTRACTOR IS CAUTIONED THAT THE LOCATIONS AND/OR ELEVATIONS OF EXISTING UTILITIES AS SHOWN ON THESE PLANS IS BASED ON THE RECORDS OF VARIOUS UTILITY COMPANIES AND WHERE POSSIBLE, MEASUREMENTS TAKEN IN THE FIELD. THIS INFORMATION IS NOT TO BE RELIED UPON AS BEING EXACT OR COMPLETE. THE CONTRACTOR IS RESPONSIBLE FOR THE ACCURATE LOCATION OF ALL UTILITIES AND HAZARDOUS WHETHER SHOWN OR NOT. THE CONTRACTOR MUST CONTACT THE APPROPRIATE UTILITY COMPANY AT LEAST 48 HOURS PRIOR TO ANY EXCAVATION TO REQUEST EXACT FIELD LOCATION OF UTILITIES.
2. THE CONTRACTOR SHALL COORDINATE ALL WORK ASSOCIATED WITH THE RETIREMENT OF ALL UTILITY SERVICE CONNECTIONS TO THE BUILDINGS TO BE DEMOLISHED.
3. THE CONTRACTOR SHALL INSTALL PROPER EROSION AND SEDIMENT CONTROL MEASURES PER SHEET C101 PRIOR TO COMMENCING DEMOLITION.
4. CONTRACTOR SHALL VERIFY DRAWING INFORMATION WITH EXISTING SITE CONDITIONS AND SHALL PROMPTLY REPORT CONCEALED CONDITIONS, DISCREPANCIES, AND/OR DEVIATIONS IN EXISTING CONDITIONS FROM INFORMATION SHOWN IN THE CONTRACT DOCUMENTS. THE OWNER SHALL NOT BE RESPONSIBLE FOR UNAUTHORIZED CHANGES OR EXTRA WORK REQUIRED TO CORRECT UNREPORTED DISCREPANCIES.
5. ANY AND ALL MATERIALS REMOVED FROM THE SITE SHALL BE DISPOSED OF IN A PROPER AND LEGAL MANNER AS REQUIRED BY ALL AUTHORITIES HAVING JURISDICTION.
6. DAMAGES TO EXISTING IMPROVEMENTS SHALL BE RESTORED, RECONSTRUCTED, OR REPLACED BY THE CONTRACTOR WITH NO ADDITIONAL PAYMENT MADE BY THE OWNER.
7. COORDINATE TREE REMOVAL IN PUBLIC RIGHT-OF-WAY WITH URBAN FORESTER (ERIN HATCH: ERIN.HATCH@BLOOMINGTON.IN.GOV)
8. PERIMETER FENCING CANNOT HAVE BARBED OR SECURITY WIRE, SHARPENED SPIKES, ELECTRIFIED WIRES, OR ANYTHING SIMILAR TO THESE LISTED ITEMS.

DEMOLITION LEGEND

EXISTING BUILDING, FOUNDATION, AND SLABS TO BE REMOVED IN ACCORDANCE WITH INDOT STANDARD SPECIFICATIONS, SECTION 202 - REMOVAL OF STRUCTURES AND OBSTRUCTIONS. SEE PROJECT MANUAL APPENDIX A FOR THE LOCAL DEMOLITION PERMITS, APPENDIX B FOR THE REQUIRED IDEM NOTIFICATION FORMS, AND APPENDIX C FOR THE PRE-DEMOLITION INSPECTION REPORTS FOR ASBESTOS CONTAINING MATERIALS (ACM), LEAD BASED PAINT, AND HAZARDOUS MATERIALS.

PROPERTY ID NUMBER

ID#	ADDRESS
1	301 W 2nd St
2	303 W 2nd St
3	311 W 2nd St
4	313 W 2nd St
5	321 W 2nd St
6	407 W 2nd St
7	409 W 2nd St
8	605 S Madison St
9	635 S Rogers St
10	640 S Morton St
11	653 S Rogers St
12	408 W 1st St

CONTRACTOR TO KEEP AND MAINTAIN THIS PAVEMENT AREA FOR OWNER, ENGINEER, INSPECTOR, AND WORKER PARKING THROUGHOUT CONTRACT.

CENTERSTONE PARKING LOT TO REMAIN IN SERVICE THROUGHOUT CONTRACT.

DEMOLITION KEYNOTES:

- EXISTING CONCRETE WALK TO BE REMOVED.
- EXISTING TREE OR STUMP TO BE REMOVED.
- EXISTING FENCE TO BE REMOVED.
- EXISTING RETAINING WALL TO BE REMOVED.
- EXISTING BOLLARD TO BE REMOVED. TO BE INCLUDED IN THE COST OF DEMOLITION OF THE ADJACENT WAREHOUSE, 635 S ROGER ST., STR. ID# 9
- EXISTING 6,000 GALLON UNDERGROUND STORAGE TANK TO BE REMOVED BY OTHERS.

EROSION & SEDIMENT CONTROL LEGEND

- TEMPORARY SILT FENCE
- PROTECTION FENCING
- LIMITS OF SEEDING AND MULCHING
- TEMPORARY SURFACE INLET PROTECTION - COIR MAT. SEE DESCRIPTION ON SWPPP INFORMATION SHEET AND DETAIL ON SWPPP DETAIL SHEET.
- TEMPORARY CONSTRUCTION ENTRANCE. SEE DESCRIPTION ON SWPPP INFORMATION SHEET AND DETAIL ON SWPPP DETAIL SHEET.
- SOIL BORING LOCATION

NO.	DATE	DESCRIPTION
1	05/16/22	SEEDING/MULCHING LIMITS
2	05/20/22	PLAN REVISIONS

CLIENT:

CITY OF BLOOMINGTON
Bloomington, IN 47403

DESIGN TEAM

shrewsberry
REA
ARCHITECTURAL
CIVIL ENGINEERING
PLANNING
LAND SURVEYING

BEA
BYNUM PARTO & ASSOCIATES, INC.
528 North Walnut Street
Bloomington, Indiana 47404 (317) 332-8030

CERTIFIED BY:

MATTHEW D. WALLACE
REGISTERED
STATE OF INDIANA
No. 10302418
PROFESSIONAL ENGINEER

© COPYRIGHTED BY SHREWSBERRY AND ASSOCIATES

HOPEWELL PHASE 1 EAST

CITY OF BLOOMINGTON
BLOOMINGTON, INDIANA 47403

DATE: 05/20/2022 PROJECT NO.: 21-0049

DRAWN BY: RDR CHECKED BY: MDW

DRAWING STATUS: PERMIT SET

SHEET TITLE: EXISTING CONDITIONS AND DEMOLITION PLAN - NE

SHEET NO.: D102





FLOOD NOTE:
According to Flood Insurance Rate Map (FIRM) this real estate is part of Community-Panel Number: 18105C 0141D, Effective Date: December 17, 2010.

This property is located in Zone X, an area of minimal flood hazard.

Source: FEMA

EXISTING CONDITIONS AND DEMOLITION PLAN
Scale: 1" = 20'-0"

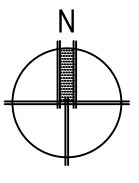

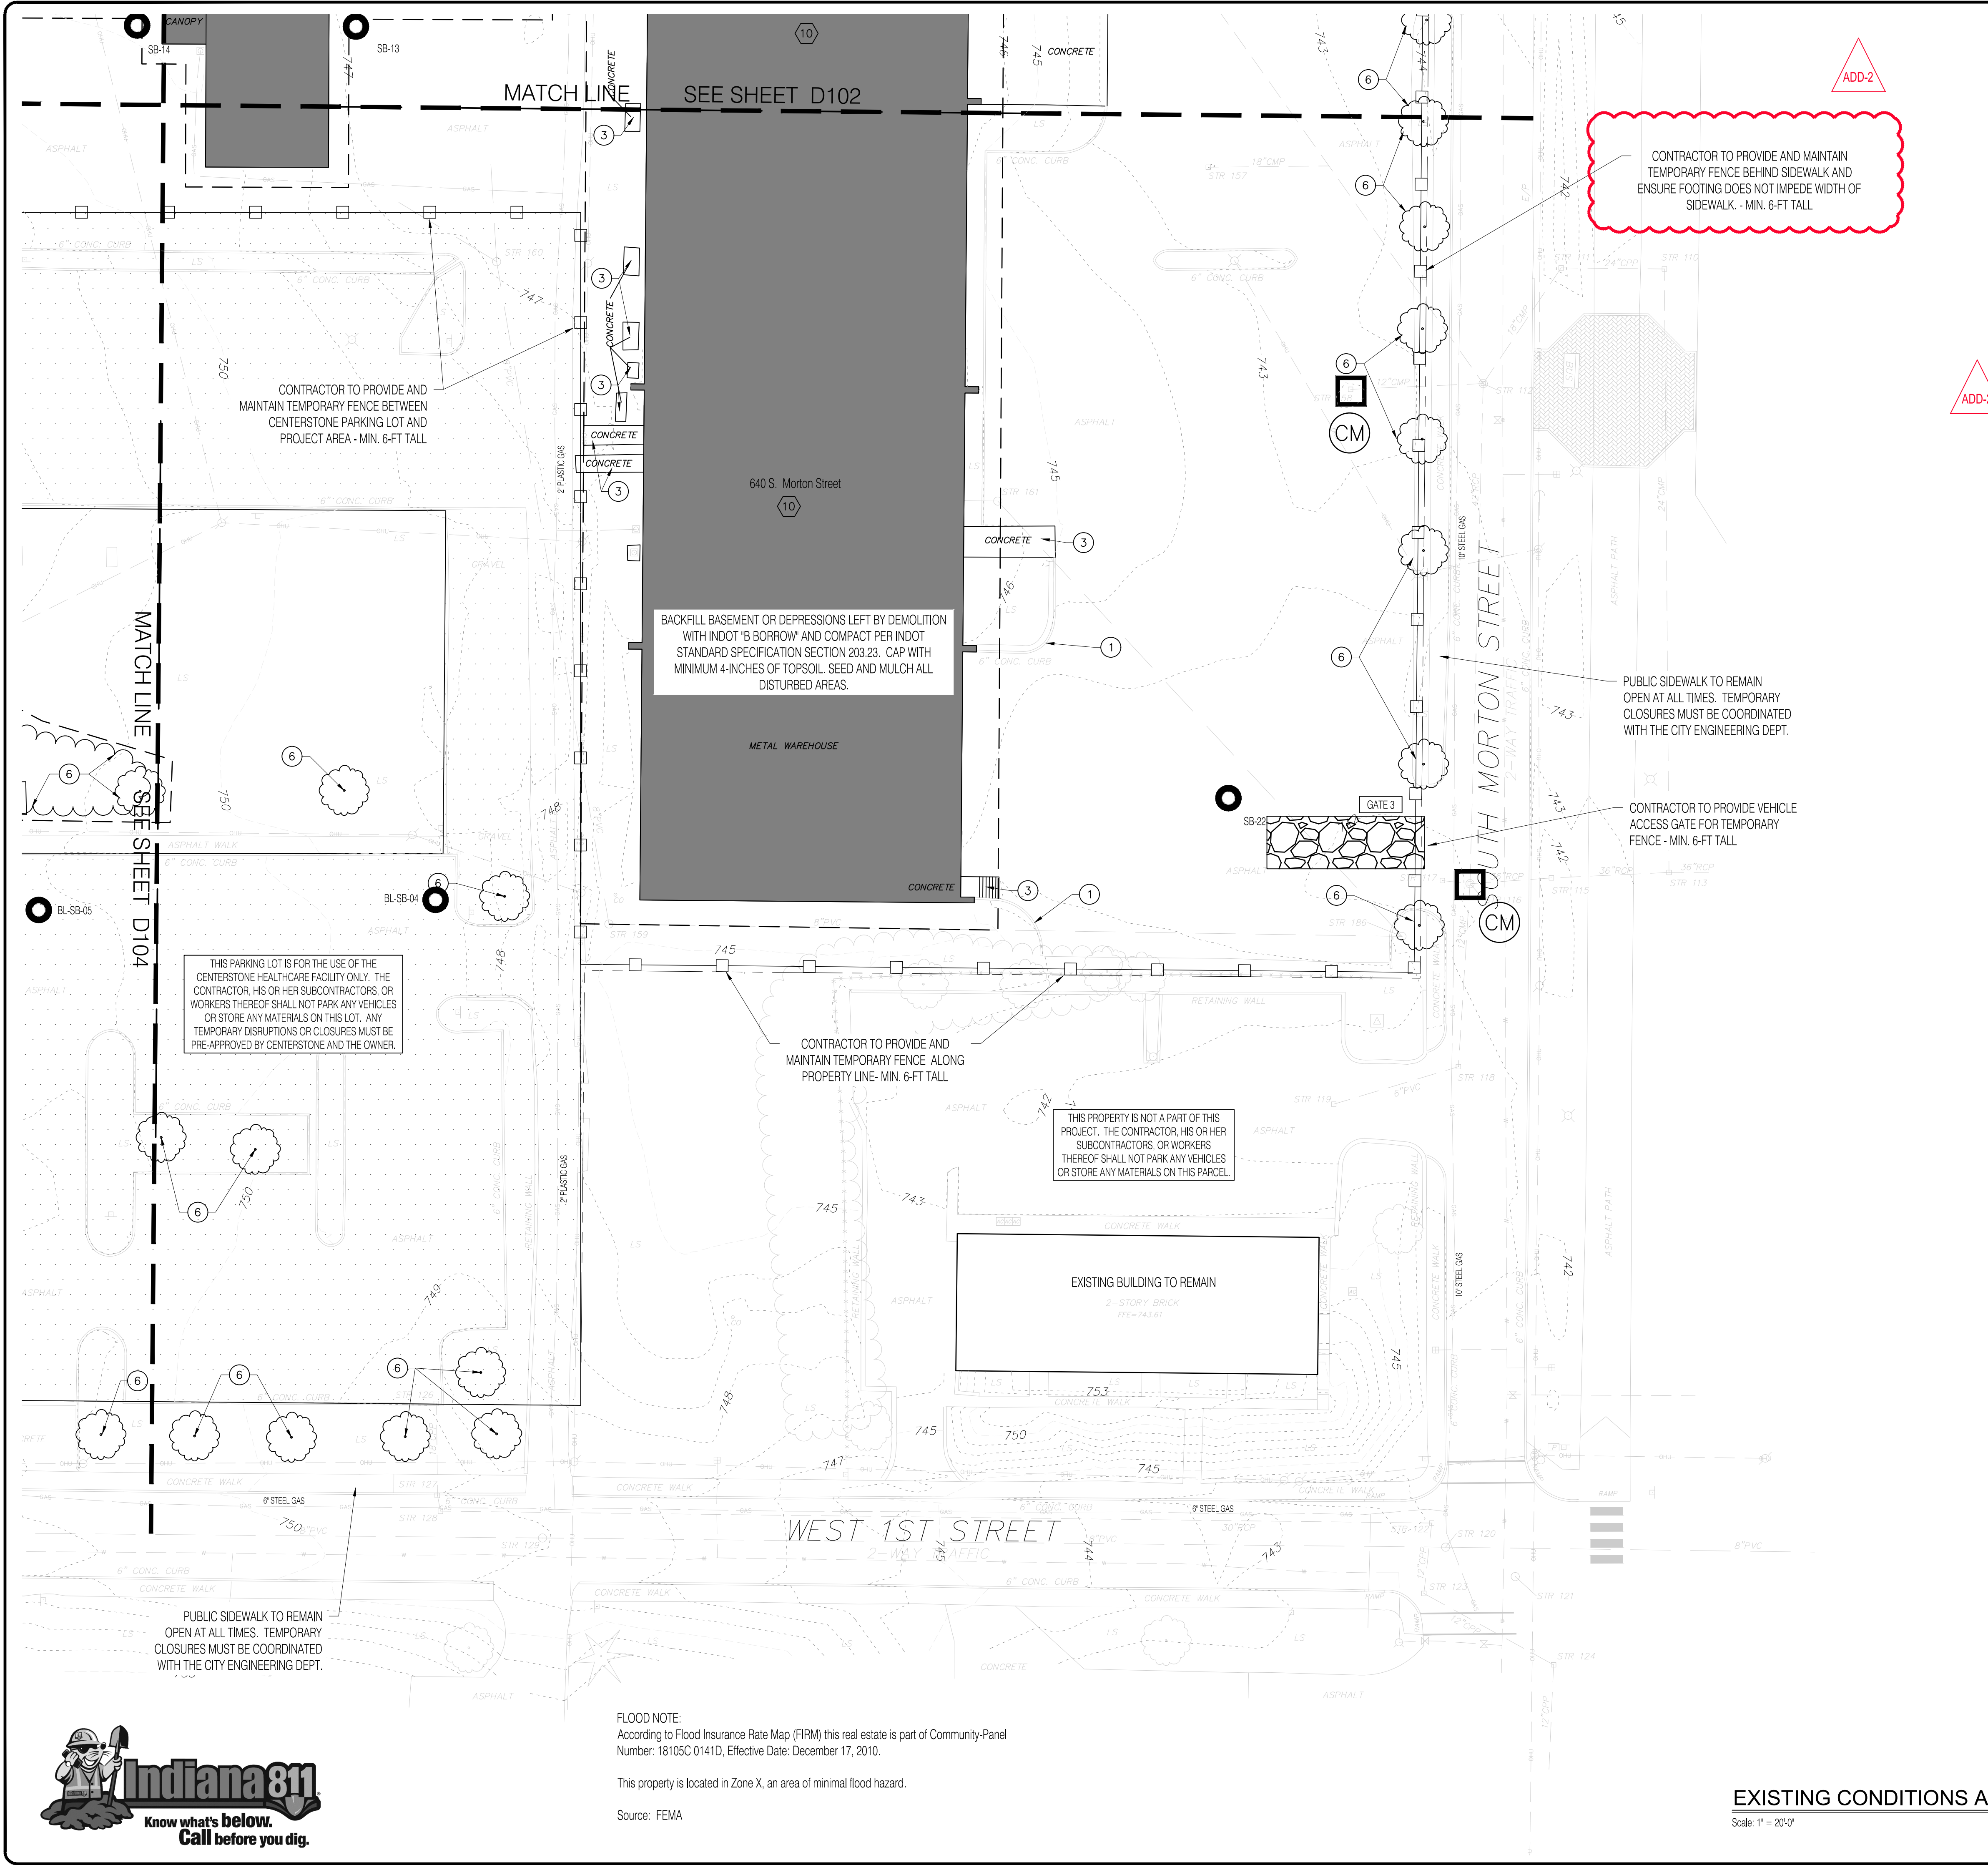

GENERAL DEMOLITION NOTES

1. THE CONTRACTOR IS CAUTIONED THAT THE LOCATIONS AND/OR ELEVATIONS OF EXISTING UTILITIES AS SHOWN ON THESE PLANS IS BASED ON THE RECORDS OF VARIOUS UTILITY COMPANIES AND WHERE POSSIBLE, MEASUREMENTS TAKEN IN THE FIELD. THIS INFORMATION IS NOT TO BE RELIED UPON AS BEING EXACT OR COMPLETE. THE CONTRACTOR IS RESPONSIBLE FOR THE ACCURATE LOCATION OF ALL UTILITIES AND HAZARDOUS WHETHER SHOWN OR NOT. THE CONTRACTOR MUST CONTACT THE APPROPRIATE UTILITY COMPANY AT LEAST 48 HOURS PRIOR TO ANY EXCAVATION TO REQUEST EXACT FIELD LOCATION OF UTILITIES.
2. THE CONTRACTOR SHALL COORDINATE ALL WORK ASSOCIATED WITH THE RETIREMENT OF ALL UTILITY SERVICE CONNECTIONS TO THE BUILDINGS TO BE DEMOLISHED.
3. THE CONTRACTOR SHALL INSTALL PROPER EROSION AND SEDIMENT CONTROL MEASURES PER SHEET C101 PRIOR TO COMMENCING DEMOLITION.
4. CONTRACTOR SHALL VERIFY DRAWING INFORMATION WITH EXISTING SITE CONDITIONS AND SHALL PROMPTLY REPORT CONCEALED CONDITIONS, DISCREPANCIES, AND/OR DEVIATIONS IN EXISTING CONDITIONS FROM INFORMATION SHOWN IN THE CONTRACT DOCUMENTS. THE OWNER SHALL NOT BE RESPONSIBLE FOR UNAUTHORIZED CHANGES OR EXTRA WORK REQUIRED TO CORRECT UNREPORTED DISCREPANCIES.
5. ANY AND ALL MATERIALS REMOVED FROM THE SITE SHALL BE DISPOSED OF IN A PROPER AND LEGAL MANNER AS REQUIRED BY ALL AUTHORITIES HAVING JURISDICTION.
6. DAMAGES TO EXISTING IMPROVEMENTS SHALL BE RESTORED, RECONSTRUCTED, OR REPLACED BY THE CONTRACTOR WITH NO ADDITIONAL PAYMENT MADE BY THE OWNER.
7. COORDINATE TREE REMOVAL IN PUBLIC RIGHT-OF-WAY WITH URBAN FORESTER (ERIN HATCH: ERIN.HATCH@BLOOMINGTON.IN.GOV)
8. PERIMETER FENCING CANNOT HAVE BARBED OR SECURITY WIRE, SHARPENED SPIKES, ELECTRIFIED WIRES, OR ANYTHING SIMILAR TO THESE LISTED ITEMS.

DEMOLITION LEGEND

EXISTING BUILDING, FOUNDATION, AND SLABS TO BE REMOVED IN ACCORDANCE WITH INDOT STANDARD SPECIFICATIONS, SECTION 202 - REMOVAL OF STRUCTURES AND OBSTRUCTIONS. SEE PROJECT MANUAL APPENDIX A FOR THE LOCAL DEMOLITION PERMITS, APPENDIX B FOR THE REQUIRED IDEM NOTIFICATION FORMS, AND APPENDIX C FOR THE PRE-DEMOLITION INSPECTIONS REPORTS FOR ASBESTOS CONTAINING MATERIALS (ACM), LEAD BASED PAINT, AND HAZARDOUS MATERIALS.

ID#	ADDRESS
1	301 W 2nd St
2	303 W 2nd St
3	311 W 2nd St
4	313 W 2nd St
5	321 W 2nd St
6	407 W 2nd St
7	409 W 2nd St
8	605 S Madison St
9	635 S Rogers St
10	640 S Morton St
11	653 S Rogers St
12	408 W 1st St

- CONTRACTOR TO KEEP AND MAINTAIN THIS PAVEMENT AREA FOR OWNER, ENGINEER, INSPECTOR, AND WORKER PARKING THROUGHOUT CONTRACT.
- CENTERSTONE PARKING LOT TO REMAIN IN SERVICE THROUGHOUT CONTRACT.

DEMOLITION KEYNOTES:

- EXISTING CONCRETE WALK TO BE REMOVED.
- EXISTING TREE OR STUMP TO BE REMOVED.
- EXISTING FENCE TO BE REMOVED.
- EXISTING RETAINING WALL TO BE REMOVED.
- EXISTING BOLLARD TO BE REMOVED. TO BE INCLUDED IN THE COST OF DEMOLITION OF THE ADJACENT WAREHOUSE, 635 S ROGER ST., STR. ID# 9
- EXISTING 6,000 GALLON UNDERGROUND STORAGE TANK TO BE REMOVED BY OTHERS.

EROSION & SEDIMENT CONTROL LEGEND

- TEMPORARY SILT FENCE
- PROTECTION FENCING
- LIMITS OF SEEDING AND MULCHING
- TEMPORARY SURFACE INLET PROTECTION - COIR MAT. SEE DESCRIPTION ON SWPPP INFORMATION SHEET AND DETAIL ON SWPPP DETAIL SHEET.
- TEMPORARY CONSTRUCTION ENTRANCE. SEE DESCRIPTION ON SWPPP INFORMATION SHEET AND DETAIL ON SWPPP DETAIL SHEET.
- SOIL BORING LOCATION

FLOOD NOTE:
 According to Flood Insurance Rate Map (FIRM) this real estate is part of Community-Panel Number: 18105C 0141D, Effective Date: December 17, 2010.
 This property is located in Zone X, an area of minimal flood hazard.
 Source: FEMA

EXISTING CONDITIONS AND DEMOLITION PLAN
 Scale: 1" = 20'-0"

NO	DATE	DESCRIPTION
1	05/16/22	SEEDING/MULCHING LIMITS
2	05/20/22	PLAN REVISIONS

CLIENT:

 Bloomington, IN 47403

DESIGN TEAM:

 ARCHITECTURAL, CIVIL, ENGINEERING, PLANNING, LAND SURVEYING

CERTIFIED BY:

 No. 10302418
 STATE OF INDIANA
 PROFESSIONAL ENGINEER

HOPEWELL PHASE 1 EAST
 CITY OF BLOOMINGTON
 BLOOMINGTON, INDIANA 47403

DATE: 05/20/2022 PROJECT NO: 21-0049
 DRAWN BY: RDR CHECKED BY: MDW
 DRAWING STATUS: PERMIT SET
 SHEET TITLE: EXISTING CONDITIONS AND DEMOLITION PLAN - SE
 SHEET NO: D103



MATCH LINE SEE SHEET D101

MATCH LINE SEE SHEET D103

GENERAL DEMOLITION NOTES

1. THE CONTRACTOR IS CAUTIONED THAT THE LOCATIONS AND/OR ELEVATIONS OF EXISTING UTILITIES AS SHOWN ON THESE PLANS IS BASED ON THE RECORDS OF VARIOUS UTILITY COMPANIES AND WHERE POSSIBLE, MEASUREMENTS TAKEN IN THE FIELD. THIS INFORMATION IS NOT TO BE RELIED UPON AS BEING EXACT OR COMPLETE. THE CONTRACTOR IS RESPONSIBLE FOR THE ACCURATE LOCATION OF ALL UTILITIES AND HAZARDOUS WHETHER SHOWN OR NOT. THE CONTRACTOR MUST CONTACT THE APPROPRIATE UTILITY COMPANY AT LEAST 48 HOURS PRIOR TO ANY EXCAVATION TO REQUEST EXACT FIELD LOCATION OF UTILITIES.
2. THE CONTRACTOR SHALL COORDINATE ALL WORK ASSOCIATED WITH THE RETIREMENT OF ALL UTILITY SERVICE CONNECTIONS TO THE BUILDINGS TO BE DEMOLISHED.
3. THE CONTRACTOR SHALL INSTALL PROPER EROSION AND SEDIMENT CONTROL MEASURES PER SHEET C101 PRIOR TO COMMENCING DEMOLITION.
4. CONTRACTOR SHALL VERIFY DRAWING INFORMATION WITH EXISTING SITE CONDITIONS AND SHALL PROMPTLY REPORT CONCEALED CONDITIONS, DISCREPANCIES, AND/OR DEVIATIONS IN EXISTING CONDITIONS FROM INFORMATION SHOWN IN THE CONTRACT DOCUMENTS. THE OWNER SHALL NOT BE RESPONSIBLE FOR UNAUTHORIZED CHANGES OR EXTRA WORK REQUIRED TO CORRECT UNREPORTED DISCREPANCIES.
5. ANY AND ALL MATERIALS REMOVED FROM THE SITE SHALL BE DISPOSED OF IN A PROPER AND LEGAL MANNER AS REQUIRED BY ALL AUTHORITIES HAVING JURISDICTION.
6. DAMAGES TO EXISTING IMPROVEMENTS SHALL BE RESTORED, RECONSTRUCTED, OR REPLACED BY THE CONTRACTOR WITH NO ADDITIONAL PAYMENT MADE BY THE OWNER.
7. COORDINATE TREE REMOVAL IN PUBLIC RIGHT-OF-WAY WITH URBAN FORESTER (ERIN HATCH: ERIN.HATCH@BLOOMINGTON.IN.GOV)
8. PERIMETER FENCING CANNOT HAVE BARBED OR SECURITY WIRE, SHARPENED SPIKES, ELECTRIFIED WIRES, OR ANYTHING SIMILAR TO THESE LISTED ITEMS.




DEMOLITION LEGEND

EXISTING BUILDING, FOUNDATION, AND SLABS TO BE REMOVED IN ACCORDANCE WITH INDOT STANDARD SPECIFICATIONS, SECTION 202 - REMOVAL OF STRUCTURES AND OBSTRUCTIONS. SEE PROJECT MANUAL APPENDIX A FOR THE LOCAL DEMOLITION PERMITS, APPENDIX B FOR THE REQUIRED IDEM NOTIFICATION FORMS, AND APPENDIX C FOR THE PRE-DEMOLITION INSPECTION REPORTS FOR ASBESTOS CONTAINING MATERIALS (ACM), LEAD BASED PAINT, AND HAZARDOUS MATERIALS.




PROPERTY ID NUMBER

ID#	ADDRESS
1	301 W 2nd St
2	303 W 2nd St
3	311 W 2nd St
4	313 W 2nd St
5	321 W 2nd St
6	407 W 2nd St
7	409 W 2nd St
8	605 S Madison St
9	635 S Rogers St
10	640 S Morton St
11	653 S Rogers St
12	408 W 1st St

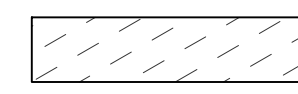

CONTRACTOR TO KEEP AND MAINTAIN THIS PAVEMENT AREA FOR OWNER, ENGINEER, INSPECTOR, AND WORKER PARKING THROUGHOUT CONTRACT.

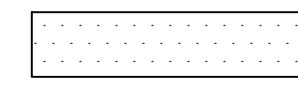

CENTERSTONE PARKING LOT TO REMAIN IN SERVICE THROUGHOUT CONTRACT.

DEMOLITION KEYNOTES:


- ③ EXISTING CONCRETE WALK TO BE REMOVED.
- ⑥ EXISTING TREE OR STUMP TO BE REMOVED.
- ⑦ EXISTING FENCE TO BE REMOVED.
- ⑧ EXISTING RETAINING WALL TO BE REMOVED.
- ⑪ EXISTING BOLLARD TO BE REMOVED. TO BE INCLUDED IN THE COST OF DEMOLITION OF THE ADJACENT WAREHOUSE, 635 S ROGER ST., STR. ID# 9
- ⑬ EXISTING 6,000 GALLON UNDERGROUND STORAGE TANK TO BE REMOVED BY OTHERS.

EROSION & SEDIMENT CONTROL LEGEND

- sf— TEMPORARY SILT FENCE
- o— PROTECTION FENCING
- - - LIMITS OF SEEDING AND MULCHING



TEMPORARY SURFACE INLET PROTECTION - COIR MAT. SEE DESCRIPTION ON SWPPP INFORMATION SHEET AND DETAIL ON SWPPP DETAIL SHEET.

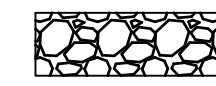

TEMPORARY CONSTRUCTION ENTRANCE. SEE DESCRIPTION ON SWPPP INFORMATION SHEET AND DETAIL ON SWPPP DETAIL SHEET.





SOIL BORING LOCATION


SB-22

EXISTING CONDITIONS AND DEMOLITION PLAN

Scale: 1" = 20'-0"

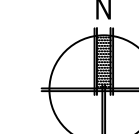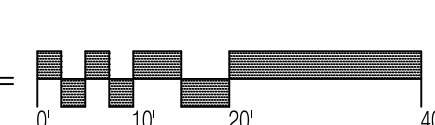

EXISTING CENTERSTONE HEALTHCARE FACILITY - TO REMAIN

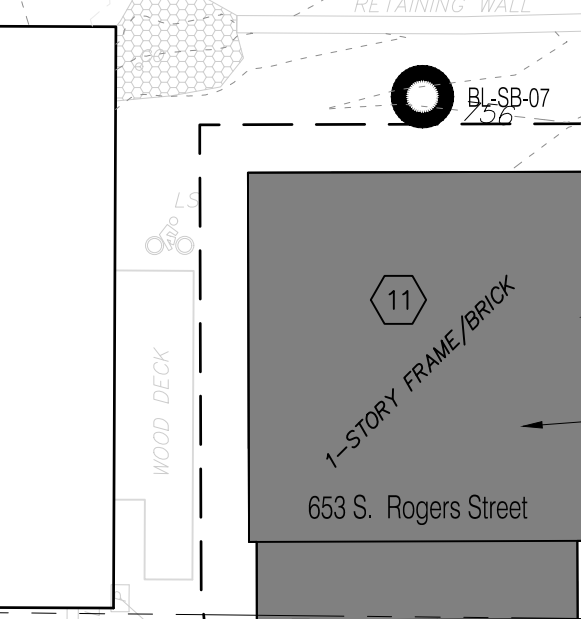

CONTRACTOR TO PROVIDE CONTINUOUS ACCESS FOR LOADING DOCK AND TRASH DUMPSTER PICKUP.

SMITHVILLE COMMUNICATIONS BURIED FIBER OPTIC LINE. LOCATION PROVIDED BY UTILITY. NOT SURVEYED.

CONTRACTOR TO PROVIDE TEMPORARY FENCING AS NEEDED TO PROTECT PEDESTRIANS

BACKFILL BASEMENT OR DEPRESSIONS LEFT BY DEMOLITION WITH INDOT 'B BORROW' AND COMPACT PER INDOT STANDARD SPECIFICATION SECTION 203.23. CAP WITH MINIMUM 4-INCHES OF TOP SOIL. SEED AND MULCH ALL DISTURBED AREAS.

PROVIDE AND MAINTAIN SILT FENCE BEHIND PAVEMENT AND SIDEWALK UNTIL AREA HAS BEEN STABILIZED WITH VEGETATION.

THIS PARKING LOT IS FOR THE USE OF THE CENTERSTONE HEALTHCARE FACILITY ONLY. THE CONTRACTOR, HIS OR HER SUBCONTRACTORS, OR WORKERS THEREOF SHALL NOT PARK ANY VEHICLES OR STORE ANY MATERIALS ON THIS LOT. ANY TEMPORARY DISRUPTIONS OR CLOSURES MUST BE PRE-APPROVED BY CENTERSTONE AND THE OWNER.

CONTRACTOR TO COORDINATE WITH CENTERSTONE FACILITY PERSONNEL FOR TEMPORARY DISRUPTIONS TO ACCESS AND PARKING DURING TIMES OF DEMOLITION AND REMOVAL

FLOOD NOTE:
According to Flood Insurance Rate Map (FIRM) this real estate is part of Community-Panel Number: 18105C 0141D, Effective Date: December 17, 2010.



This property is located in Zone X, an area of minimal flood hazard.

Source: FEMA



REVISIONS

NO	DATE	DESCRIPTION
1	05/16/22	SEEDING/MULCHING LIMITS
2	05/20/22	PLAN REVISIONS

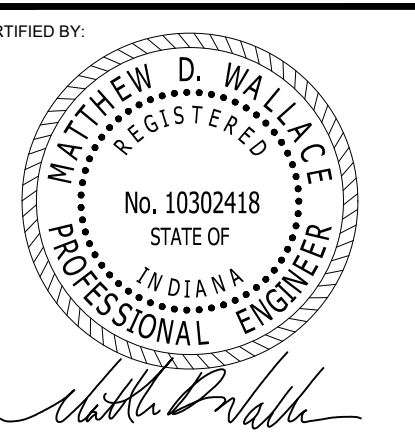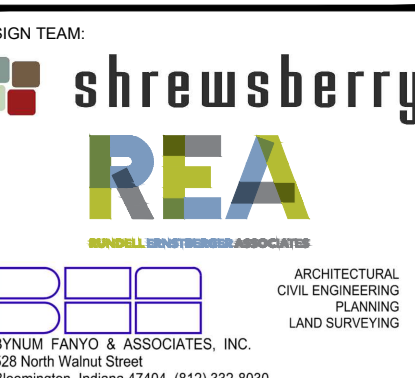

© COPYRIGHTED BY SHREWSBERRY AND ASSOCIATES

HOPEWELL PHASE 1 EAST

CITY OF BLOOMINGTON
BLOOMINGTON, INDIANA 47403

DATE: 05/20/2022	PROJECT NO.: 21-0049
DRAWN BY: RDR	CHECKED BY: MDW
DRAWING STATUS:	

PERMIT SET

SHEET TITLE: EXISTING CONDITIONS AND DEMOLITION PLAN - SW

SHEET NO.: D104

Str. No.	Rim Elevation	STRUCTURE TYPE	INVERT ELEVATION				Str. No.	Rim Elevation	STRUCTURE TYPE	INVERT ELEVATION				
			NORTH	SOUTH	EAST	WEST				NORTH	SOUTH	EAST	WEST	
100	750.94	STORM INLET			748.79		146	752.61	STORM INLET			748.31		
101	748.83	STORM INLET	746.73	746.58	746.73	746.77	147	756.35	SANITARY M.H.		748.50			
102	748.30	STORM INLET			746.80	746.84	148	752.64	STORM INLET	748.64		744.74	748.64	
103	748.90	STORM INLET	746.40	746.40			149	751.98	STORM INLET		750.48			
							150	747.44	STORM INLET		745.04			
104	748.66	STORM INLET	746.16	746.16			151	746.94	STORM M.H.		741.34	741.34		
105	749.54	SANITARY M.H.	745.14		742.42	742.48	152	746.14	STORM INLET	742.74		741.64	741.64	
106	758.13	SANITARY M.H.	751.15	751.09			153	745.88	STORM INLET		741.08	741.08	741.08	
107	748.59	SANITARY M.H.			741.63	741.69	154	745.21	STORM INLET	741.91				
108	752.05	SANITARY M.H.			746.67	746.73	155	745.29	STORM INLET	741.19		740.69	740.69	
109	755.00	SANITARY M.H.			747.86	747.92	156	743.95	STORM M.H.	739.95	739.95			
110	742.81	STORM INLET		738.56		738.71	157	742.00	STORM INLET			739.60	739.90	
111	741.60	STORM INLET		739.85	739.00		158	741.94	STORM INLET			740.14		
112	743.16	STORM M.H.		738.58	738.42	738.48	NW 738.48	159	745.41	SANITARY M.H.	741.31		741.31	
113	741.63	STORM INLET	737.23		735.93	735.99		160	746.80	SANITARY M.H.	742.30	742.20	NW 742.6	
115	741.42	STORM INLET			736.28	736.22		161	745.96	SANITARY M.H.		741.76	742.06	
116	742.07	STORM M.H.	736.01	738.17	735.93	738.97		162	750.95	SANITARY M.H.	746.65		743.05	743.05
117	741.46	STORM INLET			738.86			163	753.71	SANITARY M.H.	750.41	750.51		
118	741.11	STORM INLET	739.59			739.63		164	755.28	STORM INLET	751.53			
119	741.22	STORM INLET			739.82			165	756.03	STORM INLET	751.98			
120	742.54	SANITARY M.H.			736.60	736.68		166	757.21	STORM INLET	754.21			
121	742.27	SANITARY M.H.		NO PIPING, VACATED				167	758.74	STORM INLET	756.74			
122	742.14	STORM INLET		738.60		738.60		168	761.23	STORM INLET	759.33			
123	742.05	STORM INLET	739.25		739.19			169	760.11	STORM M.H.	756.51		756.51	
								170	762.21	SANITARY M.H.			756.81	756.71
								171	762.33	STORM INLET/M.H.	760.58	759.33		
124	742.20	STORM INLET		CANT OPEN STRUCTURE				172	759.68	STORM INLET		757.18		
125	736.27	SANITARY M.H.	731.57		731.21	731.27		173	756.73	STORM INLET		754.73		
126	748.42	STORM INLET		746.16				174	756.65	STORM INLET		754.65		
127	749.08	STORM INLET	745.82	745.68				175	756.08	STORM INLET		753.58		
128	749.15	STORM INLET	745.87		744.45			176	755.77	STORM INLET		753.37		
129	749.08	SANITARY M.H.			743.92	743.98		177	755.84	STORM INLET	753.34	753.24		
130	753.10	SANITARY M.H.			748.30	748.36		178	757.48	STORM INLET		754.13		
131	759.53	SANITARY M.H.	753.93	754.13	753.63	753.83		179	757.37	STORM M.H.		754.17	753.97	754.17
132	764.95	SANITARY M.H.	757.29	757.35				180	756.46	STORM M.H.		CANT OPEN		
133	781.08	SANITARY M.H.			775.88	775.98		181	756.47	SANITARY M.H.		750.17	750.17	750.17
135	760.17	SANITARY M.H.		NO PIPING, VACATED				182	755.70	STORM M.H.	751.42	751.40	748.80	749.00
136	757.59	SANITARY M.H.	751.17			751.21		183	755.44	STORM M.H.	751.54	748.14	749.94	748.34
								184	755.96	SANITARY M.H.	748.96	749.06	748.76	748.96
								185	767.42	SANITARY M.H.	760.02	759.92	762.22	763.22
137	765.95	SANITARY M.H.		CANT OPEN STRUCTURE				186	742.45	SANITARY M.H.		CANT OPEN		
138	764.26	STORM M.H.			757.40	757.50		187	754.13	STORM INLET	752.03		751.93	
139	757.20	STORM M.H.	751.94	752.72		751.98		188	755.45	STORM INLET		752.55		
140	756.04	STORM INLET			750.14			189	756.59	STORM INLET		754.19		
142	754.41	STORM M.H.	747.25	747.37	746.65	748.51		190	752.58	STORM INLET		748.28		
143	754.09	STORM INLET		749.84				191	749.64	STORM INLET	748.44			
144	752.57	STORM INLET			748.87	748.87		192	759.18	STORM INLET				
								193	759.20	STORM INLET				
								194	759.18	STORM INLET				
								195	759.11	STORM M.H.				
145	753.21	STORM M.H.		FULL OF SEDIMENT & DEBRIS				196	761.62	STORM M.H.				

*Note: All structures except 190-194 are typical concrete with either concrete or brick risers rings



Structures 190-194 are smaller, private drainage structures not part of the city's infrastructure.

EXISTING SITE CONDITIONS
BHURU INFRASTRUCTURE & SITE WORK

DRAWING NO. 5021058A
SHEET 2 OF 2

PREPARED BY BYNUM FANTO & ASSOCIATES INC. 528 N. WALNUT ST. BLOOMINGTON, IN. 47404

NO.	DATE	DESCRIPTION
1	05/16/22	SEEDING/MULCHING LIMITS
2	05/20/22	PLAN REVISIONS

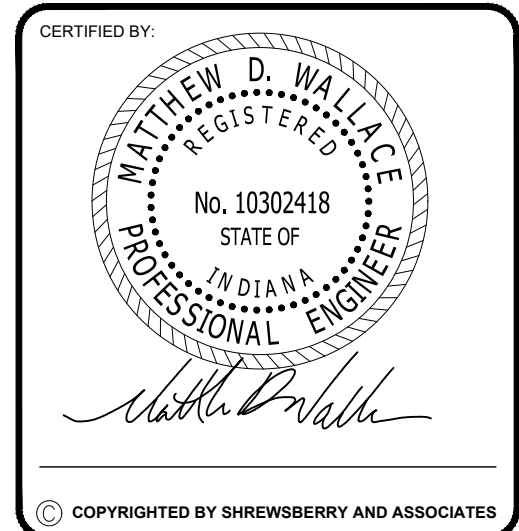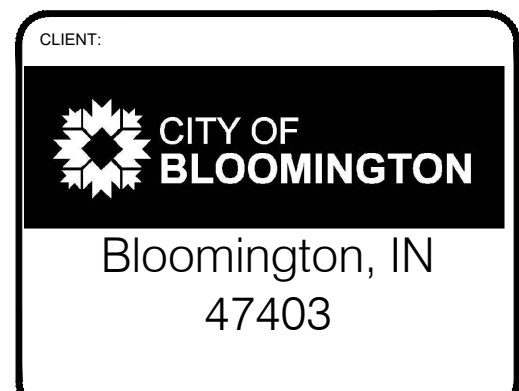


HOPEWELL PHASE 1 EAST
CITY OF BLOOMINGTON
BLOOMINGTON, INDIANA 47403


DATE: 05/20/2022	PROJECT NO.: 21-0049
DRAWN BY: RDR	CHECKED BY: MDW
DRAWING STATUS: PERMIT SET	
SHEET TITLE: EXISTING STRUCTURE DATA TABLE	
SHEET NO.: D105	




© 2022 BY BNUM FANTO & ASSOCIATES INC. ALL RIGHTS RESERVED.

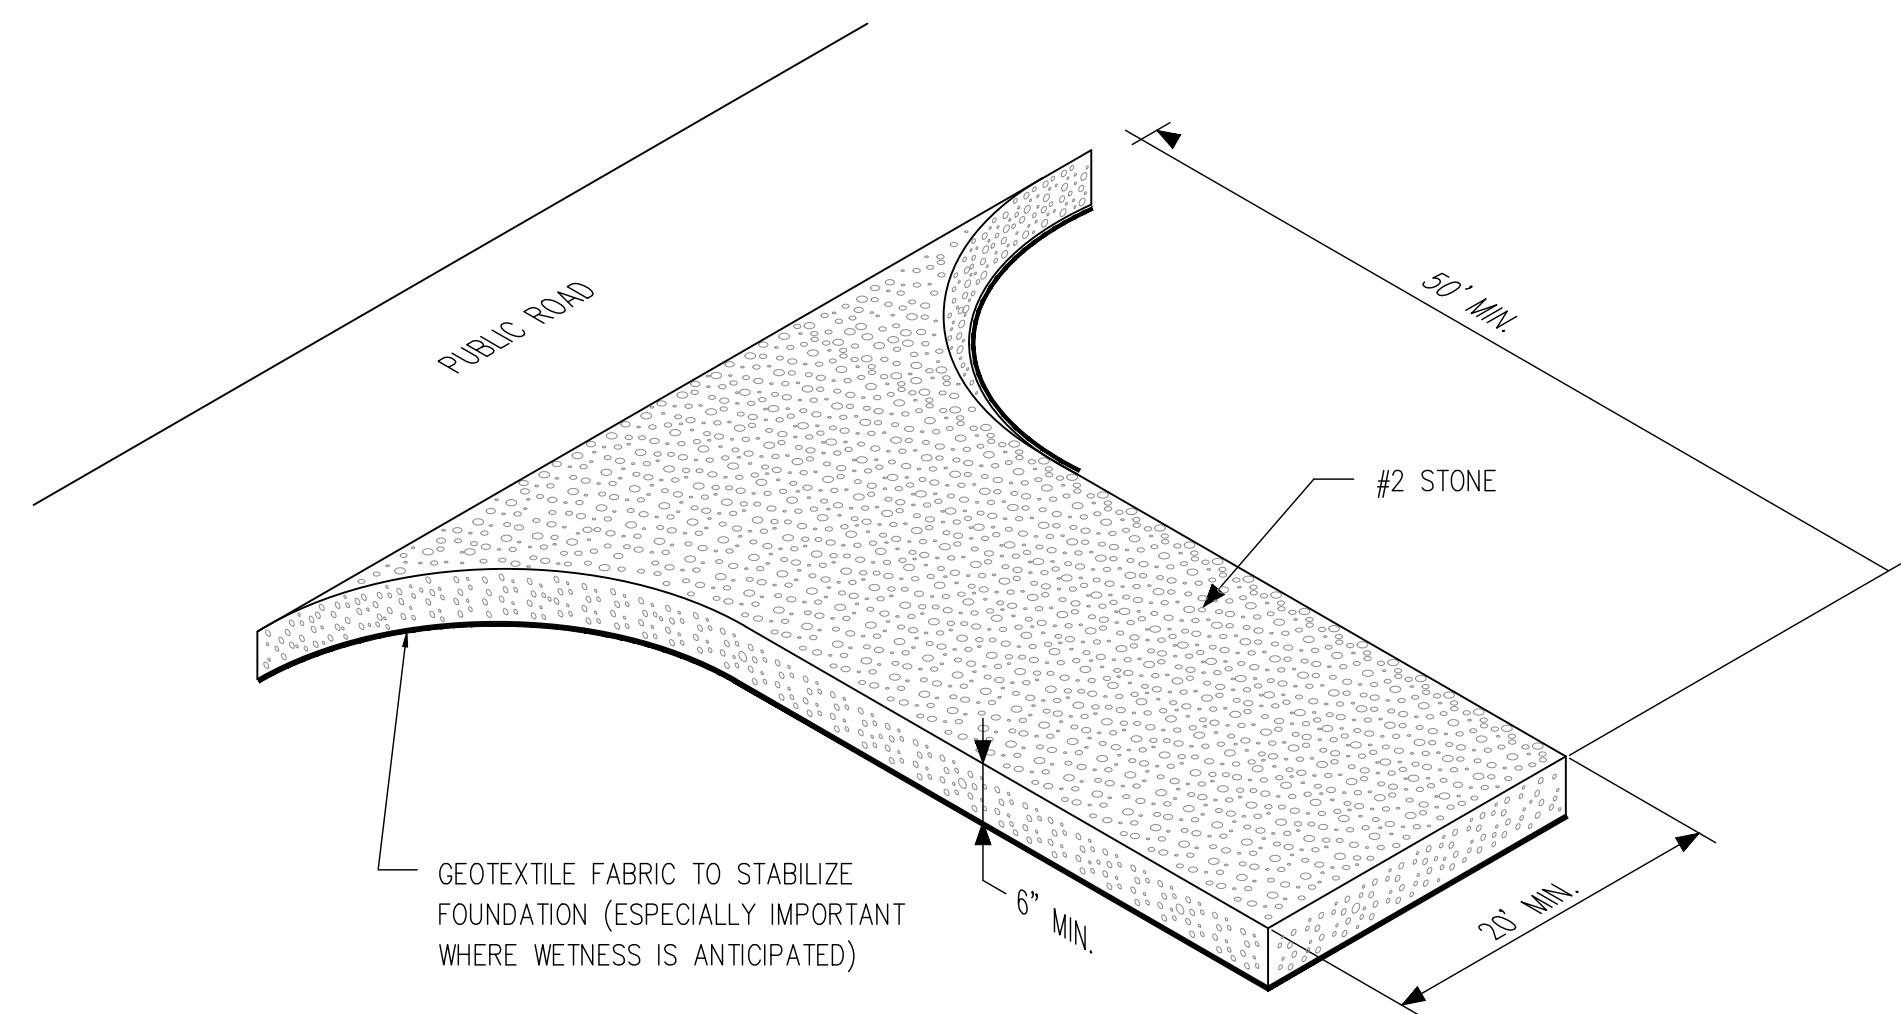

1 **TEMPORARY CONSTRUCTION ENTRANCE**
NO SCALE

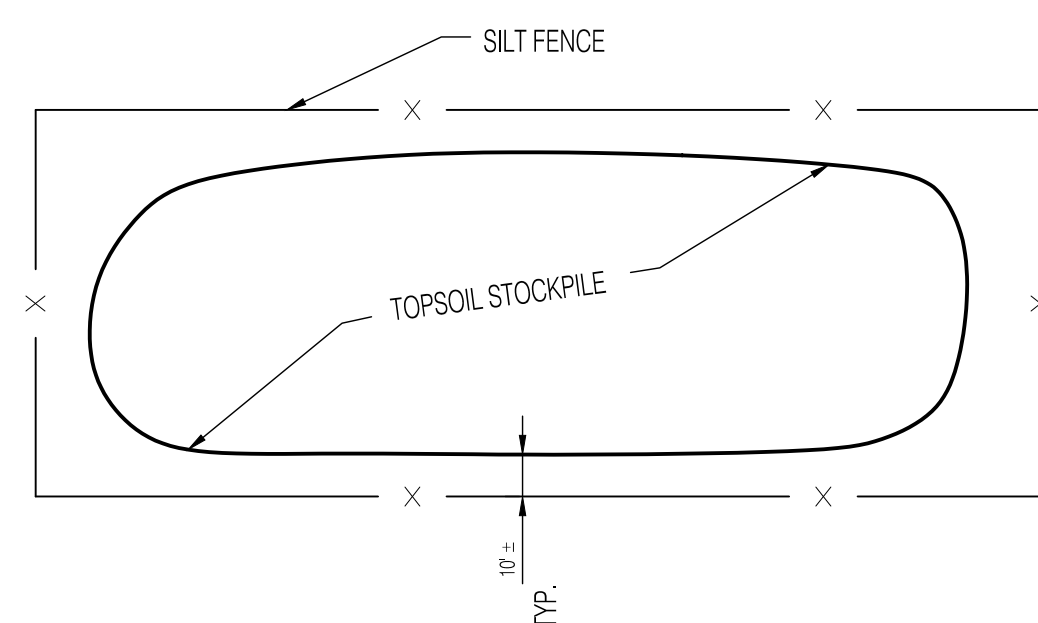


2 **TEMPORARY TOPSOIL STOCKPILE**
NO SCALE

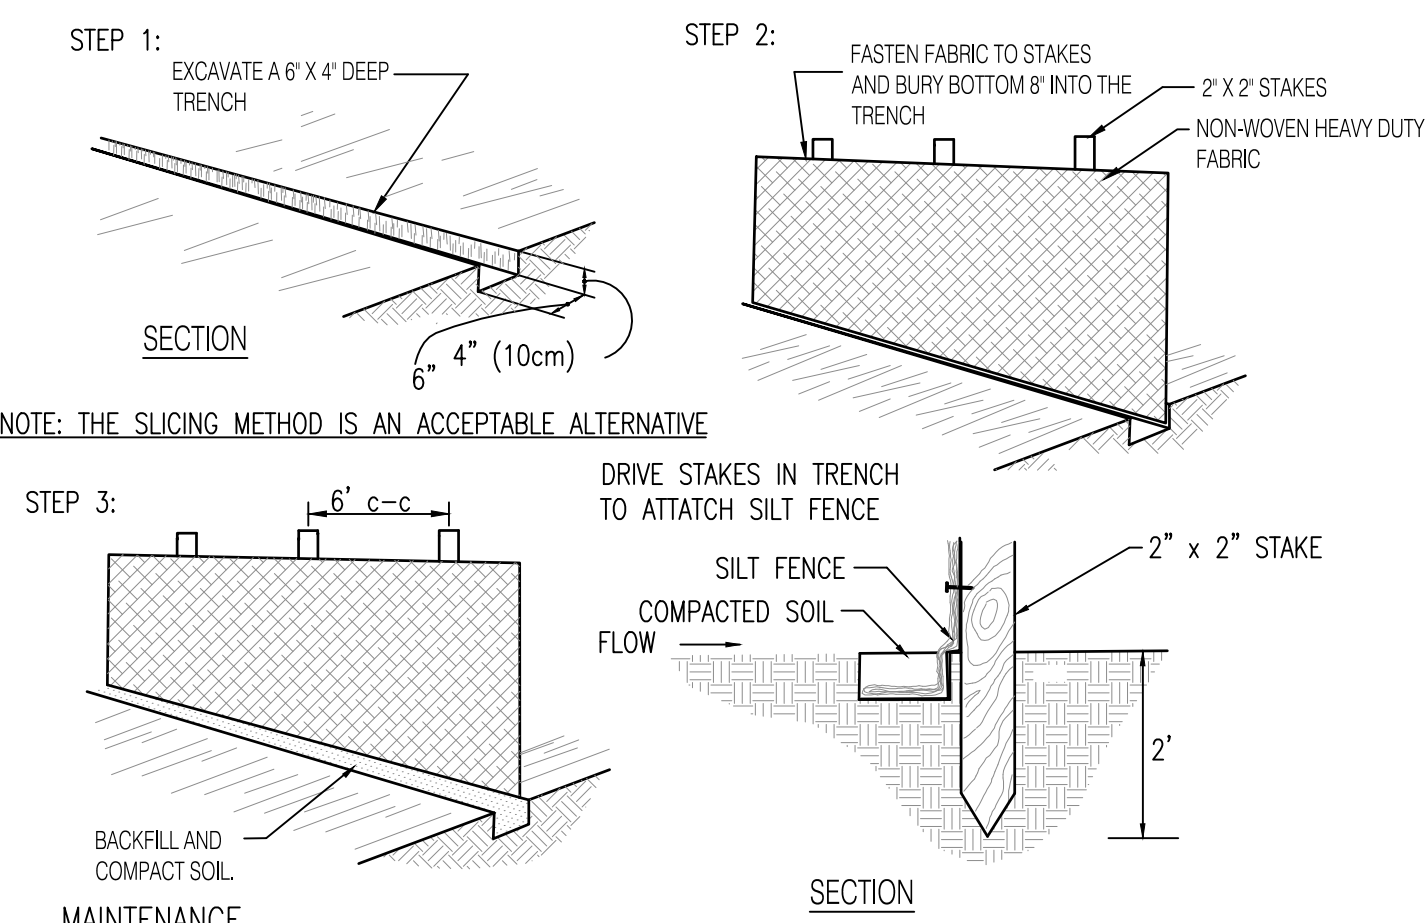

- NOTE: THE SLICING METHOD IS AN ACCEPTABLE ALTERNATIVE
- INSPECT THE SILT FENCE PERIODICALLY AND AFTER EACH STORM EVENT.
 - IF FENCE FABRIC TEARS, STARTS TO DECOMPOSE, OR IN ANY WAY BECOMES INEFFECTIVE, REPLACE THE AFFECTED PORTION IMMEDIATELY.
 - REMOVE DEPOSITED SEDIMENT WHEN IT REACHES HALF THE HEIGHT OF THE FENCE AT ITS LOWEST POINT OR IS CAUSING THE FABRIC TO BULGE.
 - TAKE CARE TO AVOID UNDERMINING THE FENCE DURING CLEAN OUT.
 - AFTER THE CONTRIBUTING DRAINAGE AREA HAS BEEN STABILIZED, REMOVE THE FENCE AND SEDIMENT DEPOSITS, BRING THE DISTURBED AREA TO GRADE, AND STABILIZE.

3 **SILT FENCE BARRIER INSTALLATION**
NO SCALE

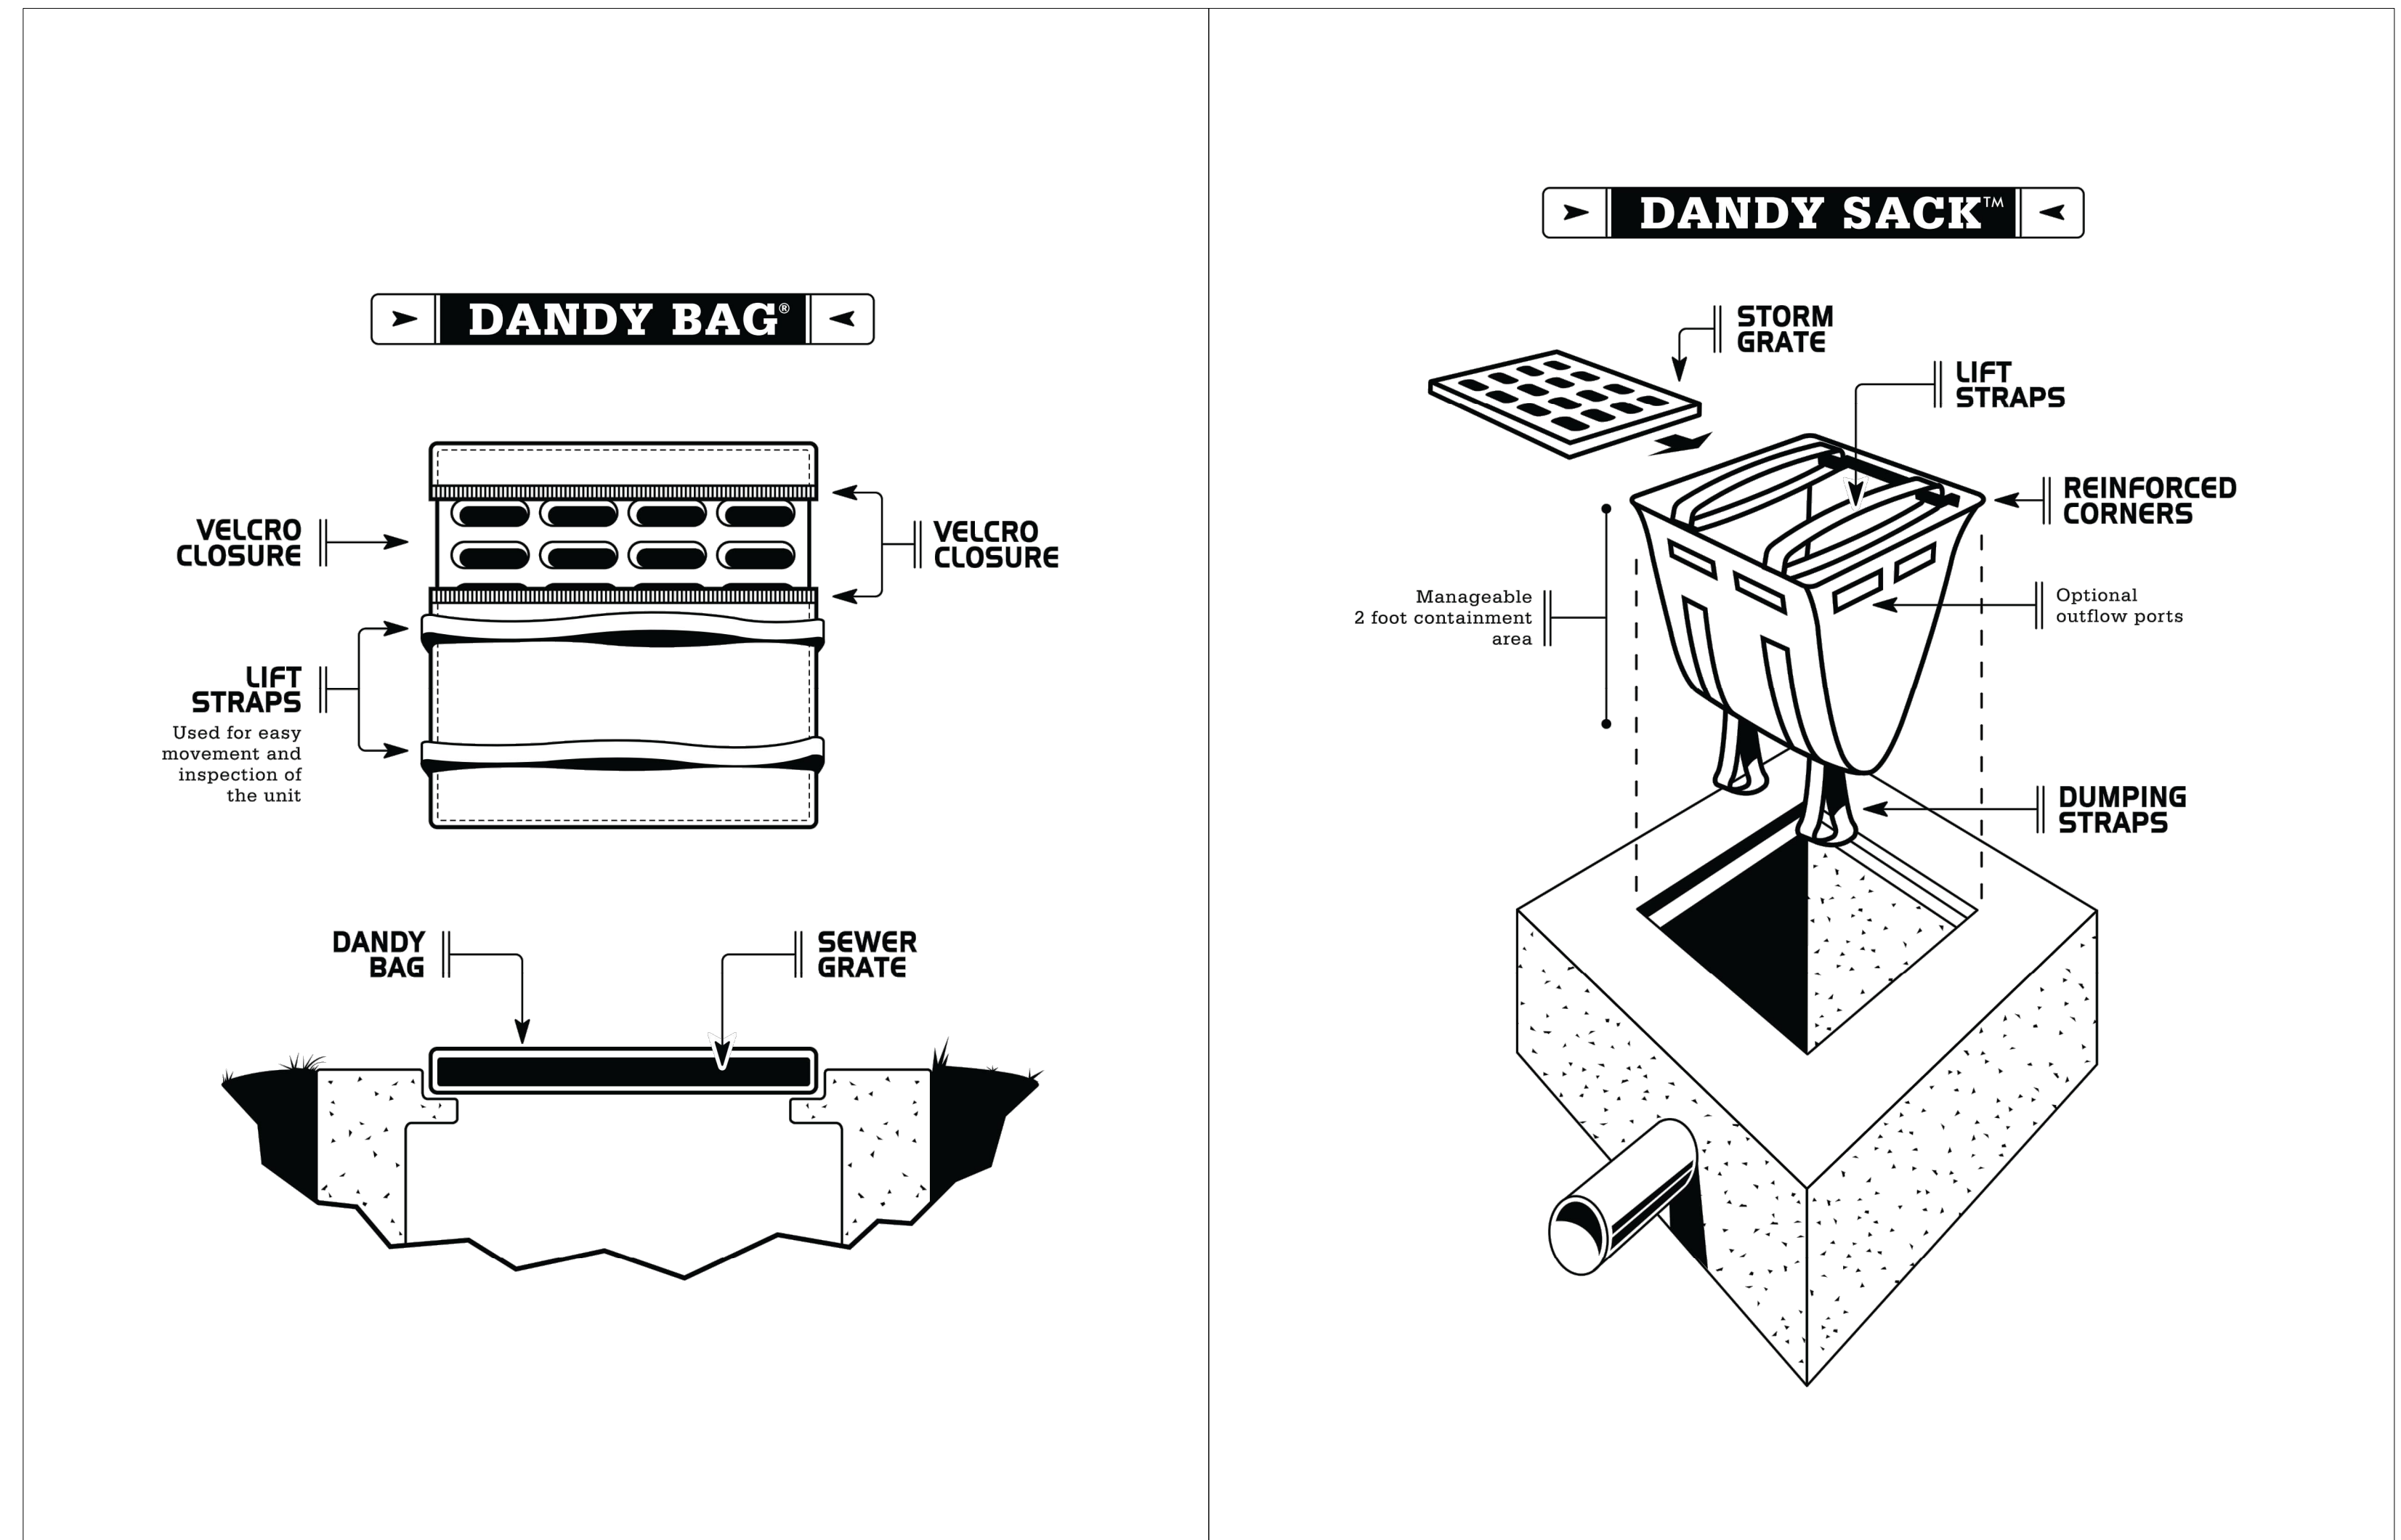

4 **INLET PROTECTION DETAILS**
NO SCALE

ADD-2

REVISIONS	
NO.	DESCRIPTION
1	05/16/22 SEEDING/MULCHING LIMITS
2	05/20/22 PLAN REVISIONS

CLIENT:
CITY OF BLOOMINGTON
Bloomington, IN 47403

DESIGN TEAM
shrewsberry REA
ARCHITECTURAL CIVIL ENGINEERING PLANNING LAND SURVEYING
BEA
BYNUM PANTO & ASSOCIATES, INC.
528 North Walnut Street
Bloomington, Indiana 47404 (812) 332-8030

CERTIFIED BY:
MATTHEW D. WALLACE
REGISTERED PROFESSIONAL ENGINEER
No. 10302418
STATE OF INDIANA
Matthew Wallace

© COPYRIGHTED BY SHREWSBERRY AND ASSOCIATES

HOPEWELL PHASE 1 EAST
CITY OF BLOOMINGTON
BLOOMINGTON, INDIANA 47403

DATE: 05/20/2022 PROJECT NO.: 21-0049
DRAWN BY: RDR CHECKED BY: MDW
DRAWING STATUS:

PERMIT SET
SHEET TITLE:
STORMWATER POLLUTION PREVENTION DETAILS

SHEET NO.:
C103

STORMWATER POLLUTION PREVENTION DETAILS
Scale: 1" = 40'-0"

