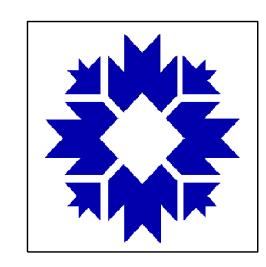
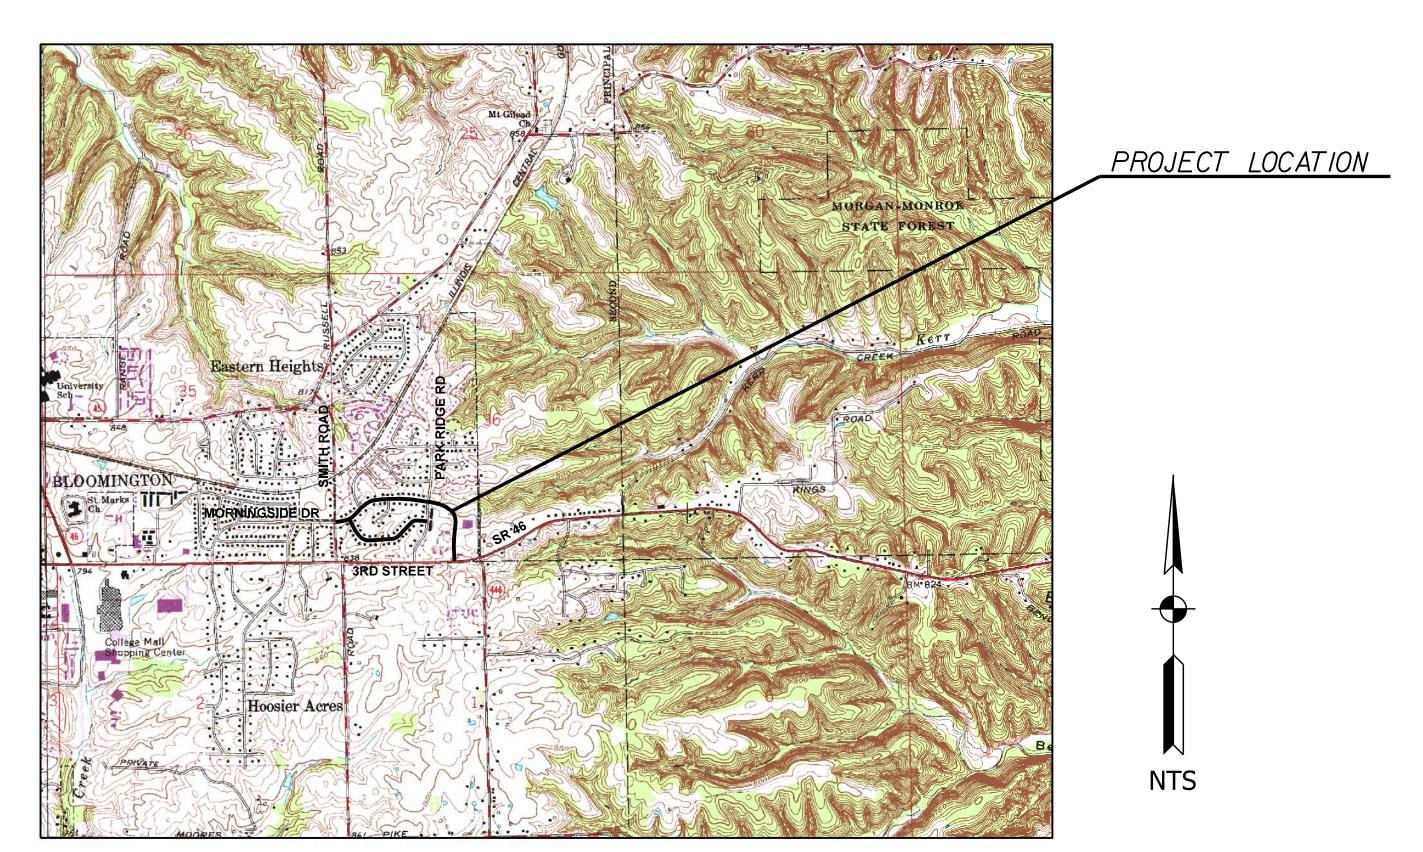
CITY OF BLOOMINGTON DEPARTMENT OF ENGINEERING



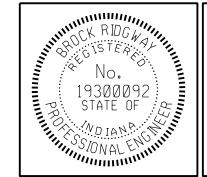
MORNINGSIDE DRIVE GREENWAY SMITH ROAD TO STATE ROAD 46

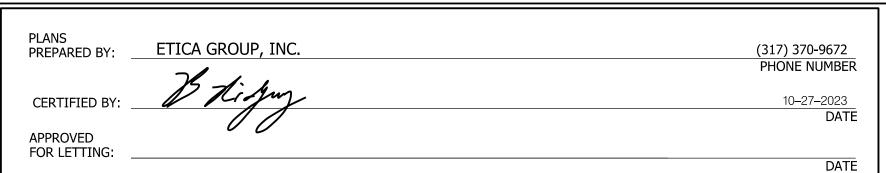


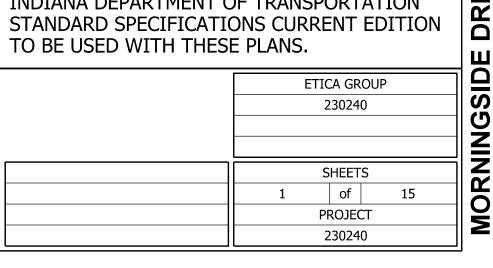
PROJECT LOCATION MAP CITY OF BLOOMINGTON, MONROE COUNTY

INDIANA DEPARTMENT OF TRANSPORTATION STANDARD SPECIFICATIONS CURRENT EDITION

PROJECT LOCATION SHOWN BY —







UTILITIES TELEPHONE/COMMUNICATIONS (CONT.) DUKE (DISTRIBUTION) AT & T ATTN: CHRISTINA GIROD PRIMARY: JOHN HALL 16475 SOUTH PARK DRIVE (812) 334-4742 ALT:TOD MOORE WESTFIELD, IN 46074 (812) 334-4718 (812) 273-9596 4517 INDIANA BELL COURT christina.girod@@duke-energy.com BLOOMINGTON, IN 47408 STORM/SANITARY/WATER CITY OF BLOOMINGTON UTILITIES SMITHVILLE TELEPHONE CO. ATTN.: PHIL PEDEN ATTN: JOE BRYNIARSKI 600 E. MILLER DRIVE 1600 W. TEMPERANCE ST. BLOOMINGTON, IN 47401 ELLETTSVILLE, IN 47429-0729 (812) 349-3634 (812) 935-2262 pedenp@bloomington.in.gov joe.bryniarski@smithville.com 24-HR CONTROL OPERATOR (812) 339-1444 CITY OF BLOOMINGTON CITY OF BLOOMINGTON STREET DEPARTMENT TELEPHONE/COMMUNICATIONS ATTN: FREDDIE LOVE US SIGNAL 1981 S. HENDERSON STREET ATTN: JOHN LUNDELL BLOOMINGTON, IN 47401 201 IONIA AVENUE SW (812) 349-3448 GRAND RAPIDS, MI 49503 freddie.love@bloomington.in.gov (616) 988-7117 jlundell@ussignal.com ATTH: WAYLON HIGGINS CENTURYLINK 9209 CASTLE GATE DRIVE

INDIANAPOLIS, IN 46256

waylon.higgins@zayo.com

(765) 341-1199

	GENERAL NOTES
1	ALL REMOVAL AND EXCAVATION ITEMS ARE TO BE PAID AS CLEARING.
2	ALL RADII ARE TO BACK OF CURB LINE.
3	<u>USE OF INDOT STANDARD SPECIFICATIONS:</u> UNLESS OTHERWISE PROVIDED IN THESE PLANS OR THE TECHNICAL SPECIFICATIONS, MATERIALS AND WORKMANSHIP OF THE WORK SHALL BE AS REQUIRED BY THE CURRENT EDITION OF THE INDOT STANDARD SPECIFICATIONS.
4	<u>USE OF PROPERTY:</u> NO MATERIALS OR EQUIPMENT SHALL BE STORED IN A LOCATION OR MANNER WHICH PRESENTS A HAZARD TO THE PUBLIC OR THE ENVIRONMENT.THE SAFEGUARD OF MATERIALS REMAINING IN THESE AREAS IS THE SOLE RESPONSIBILITY OF THE CONTRACTOR.
5	COORDINATION OF DRAWINGS, TECHNICAL SPECIFICATIONS AND STANDARD SPECIFICATIONS: THE CONTRACT DOCUMENTS WHICH ARE LISTED IN THE AGREEMENT ARE INTENDED TO BE COMPLEMENTARY AND TO DESCRIBE AND PROVIDE FOR COMPLETE WORK. A REQUIREMENT APPEARING IN ONE IS BINDING AS THOUGH OCCURRING IN ALL. IN CASE OF DISCREPANCY, THE FOLLOWING ORDER OF PRECEDENCE WILL APPLY: I.CONSTRUCTION AGREEMENT, 2.INSTRUCTIONS TO BIDDERS, 3.SUPPLEMENTARY GENERAL CONDITIONS, 4.PERMITS ISSUED BY FED/STATE/LOCAL AGENCIES 5.TECHNICAL SPECIFICATIONS, 6.GENERAL CONDITIONS, 7.PROJECT DRAWINGS, 8.STANDARD SPECIFICATIONS AS PUBLISHED BY THE INDIANA DEPARTMENT OF TRANSPORTATION, CURRENT EDITION.
6	PRESENCE OF UTILITIES: MOST OF THIS PROJECT IS PRESENTED ON A GIS BASE MAP AND UTILITIES ARE NOT SHOWN. EXISTING UTILITIES THAT ARE SHOWN ON PLANS ARE APPROXIMATED IN ACCORDANCE WITH AVAILABLE RECORDSLOCATOR'S MARKINGS, AND PHYSICAL EVIDENCE. OTHER UTILITIES MAY A BE PRESENT. EXACT LOCATIONS AND ELEVATIONS ARE TO BE DETERMINED BY CONTRACTOR.
7	<u>UTILITY LOCATIONS:</u> CONTRACTOR IS REQUIRED BY LAW TO NOTIFY INDIANA UNDERGROUND LOCATION SERVICE AT LEAST TWO WORKING DAYS PRIOR TO COMMENCING ANY EXCAVATION WORK.CONTACT NUMBER IS 811.OTHER LOCAL UTILITIES MAY NOT BE SUBSCRIBERS AND MUST BE CONTACTED INDIVIDUALLY FOR LOCATE REQUESTS.
8	STAKING: CONTRACTOR SHALL BE RESPONSIBLE FOR ALL STAKING.

MAINTENANCE OF TRAFFIC AND EROSION CONTROL ITEMS

	INDEX						
SHEET NO.	DRAWINGS INDEX						
1	TITLE SHEET						
2	INDEX / GENERAL NOTES / LEGEND / UTILITY DATA						
3 - 5	MISCELLANEOUS DETAILS						
6	MAINTENANCE OF TRAFFIC PLANS						
7	PLAN KEY - GREENWAY PLANS						
8 - 15	GREENWAY PLANS						

GENERAL LEGEND (EXISTING SCREENED, PROPOSED IN BOLD)

\(\frac{\dagger}{\dagger}\)	LIGHT POLE	WM	WATER METER
	WATER VALVE		GAS VALVE
	INLETS	GM	GAS METER
(FH)	HYDRANT	B	BOLLARD
		DS _o	DOWNSPOUT
	TREES	——————————————————————————————————————	STORM
0	SIGN	——————————————————————————————————————	UNDERGROUND ELECTRIC
	3.0.1	——————————————————————————————————————	UNDERGROUND TELEPHONE
\varnothing	POWER POLE	OHU	OVERHEAD UTILITY
(ST)(SA)	MANHOLE (STORM, SANITARY)	——————————————————————————————————————	WATERMAINS/WATER LINES
		——————————————————————————————————————	GAS MAINS/LINE
PH	TELECOM MANHOLES		GUARDRAIL
AC	AIR CONDITIONER	×	WOOD FENCE
Tel.	TELE. RISER		

(FORMERLY LEVEL 3 AND GTE)

ATTN: DEWAYNE HAMILTON

4625 WEST 86TH STREET

dewayne.hamilton@centurylink.com

INDIANAPOLIS, IN 46268

(317) 966-3356

<u>CABLE TELEVISION</u>

ATTN: STEVE MCARTOR

BLOOMINGTON, IN 47401

CENTERPOINT ENERGY

ATTN: ARIEL THOMAS

205 SOUTH MADISON

BLOOMINGTON, IN 47404

ariel.thomas@centerpoint.com

BLOOMINGTON DIGITAL UNDERGROUND

(812) 360-3090

(812) 330-4018

ATTN:: RICK DIETZ

401 N. MORTON ST.

SUITE 150

(812) 349-3485

ITS DEPT., CITY HALL

BLOOMINGTON, IN 47404

2450 SOUTH HENDERSON ST.

COMCAST

——— EXISTING R/W

PROPOSED ITEMS

CONCRETE CURB, MOUNTABLE (PROFILE TO MATCH EXISTING)

INDOT STANDARD DRUM

BARRICADE (TYPE III)

WITH STEADY BURN LIGHTS

ORANGE, ON TEMPORARY STANDS

TEMPORARY CONSTRUCTION FENCING, 48" MESH,

CONSTRUCTION SIGNS (SHAPE PER MUTCD)

CONCRETE CURB

REINFORCED CONCRETE CURB

MULCH SEEDED AREA - WITH CUSTOM SEED MIX (SEE TEXT BOX)

24" WHITE LINES FOR CROSSWALKS OR STOP BARS, THERMOPLASTIC

BIKE SYMBOLS, THERMOPLASTIC

45) WHITE CHEVRONS (FOR BIKE ROUTE), THERMOPLASTIC

SPEED CUSHION MARKINGS, THERMOPLASTIC

REMOVE EXISTING SIGN AND POST

RESET EXISTING SIGN ON NEW TYPE I POST WITH UNREINFORCED ANCHOR BASE

NEW SIGN ON TYPE I POST WITH UNREINFORCED ANCHOR BASE

CONSTRUCTION LIMITS

RAMP, CONCRETE.6" INCLUDING DETECTABLE WARNING PLATES (PER CITY'S APPROVED MATERIALS LIST) ON 4" COMPACTED AGGREGATE BASE NO. 53s

DETECTABLE WARNING PLATES (ON RADIUS, IF RADIUS LABELLED) - (MATERIAL PER CITY PRE-APPROVED MATERIAL LIST)

CONCRETE SIDEWALK, 4" ON 4" COMPACTED AGGREGATE, NO. 53s

PCCP FOR PATCHING, 12" WITH 1.5" HMA OVERLAY

MILL I.O" AND RESURFACE/WEDGE UP TO I.5" HMA SURFACE, B

NEW TREE, 2" MIN. CALIPER, AMELANCHIER X GRANDIFLORA (CROSS OF ALLEGHENY SERVICE BERRY AND DOWNY SERVICE BERRY)

TURNING SPACE, MAX. 2% SLOPE IN ANY DIRECTION

CONTRACTOR SHALL NOT USE PLASTIC LANDSCAPE NETTING OR MESH FOR ANY TYPE OF PERMANENT LANDSCAPING OR EROSION CONTROL.

TREES, MIN. 2.0"-2.5" CALIPER:

T2 - KENTUCKY COFFEETREE T3 - TULIP TREE

T4 - REDBUD - SINGLE STEM

HEIGHT/SIZE RESTRICTED LOCATIONS:

T5 - SERVICEBERRY - SINGLE STEM T6 - DOGWOOD - SINGLE STEM

T7 - AMERICAN HORNBEAM

UNRESTRICTED LOCATIONS:

TI - SWAMP WHITE OAK

SEED MIX REQUIREMENTS:

SEED MIXTURE SHALL BE 50 LBS/ACRE OF PERENNIAL RYEGRASS.

50 LBS/ACRE OF CERTIFIED COMMON KENTUCKY BLUEGRASS, AND

MAY BE APPROVED, BUT SHALL NOT CONTAIN ANY PROHIBITED

50 LBS/ACRE OF MERIT KENTUCKY BLUEGRASS. CONTRACTOR SHALL SEED AT A RATE OF 150 LBS/ACRE. EQUIVALENT SEED MIXTURES

PLANT SPECIES AS LISTED IN BLOOMINGTON MUNICIPAL CODE 20.04.080.

RAIN GARDEN PREFABRICATED STRUCTURE REQUIREMENTS:

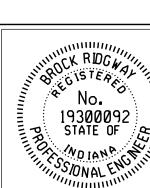
ELEC. RISER

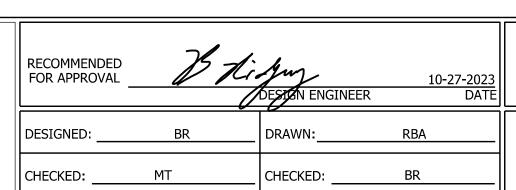
MAILBOX

TELECOM MANHOLES

PARKING METER

PROJECT INCLUDES 2 EACH PRETREATMENT SEDIMENT AND TRASH TRAPS.
THESE SHALL BE RAIN GUARDIAN "BUNKER" MODEL UNITS AS MANUFACTURED BY RINKER MATERIALS. FOR MORE INFORMATION www.RainGuardian.biz





CITY OF BLOOMINGTON DEPARTMENT OF ENGINEERING

UTILITY DATA

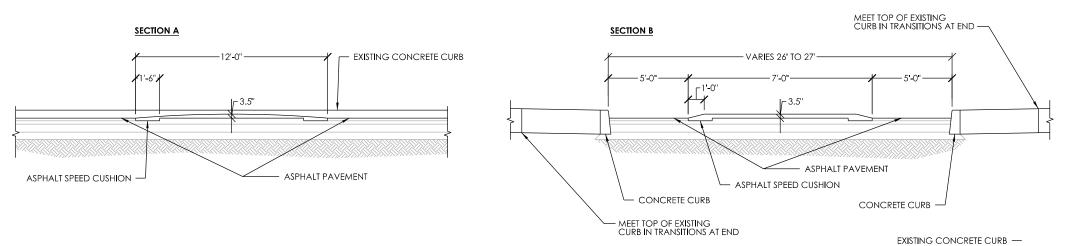
HORIZONTAL SCALE ETICA GROUP 230240 VERTICAL SCALE SHEET NUMBER

FOR INFO ONLY: ALL TREES AND PLANTS TO BE INSTALLED BY CONTRACTOR

8720 Castle Creek Pkwy E Dr, Suite 400, Indianapolis, IN 46250 https://eticagroup.com


19300092 STATE OF 25

INDEX / GENERAL NOTES / LEGEND /



ASPHALT SPEED CUSHION FOR FULLY CURBED ROADWAY - SECTION

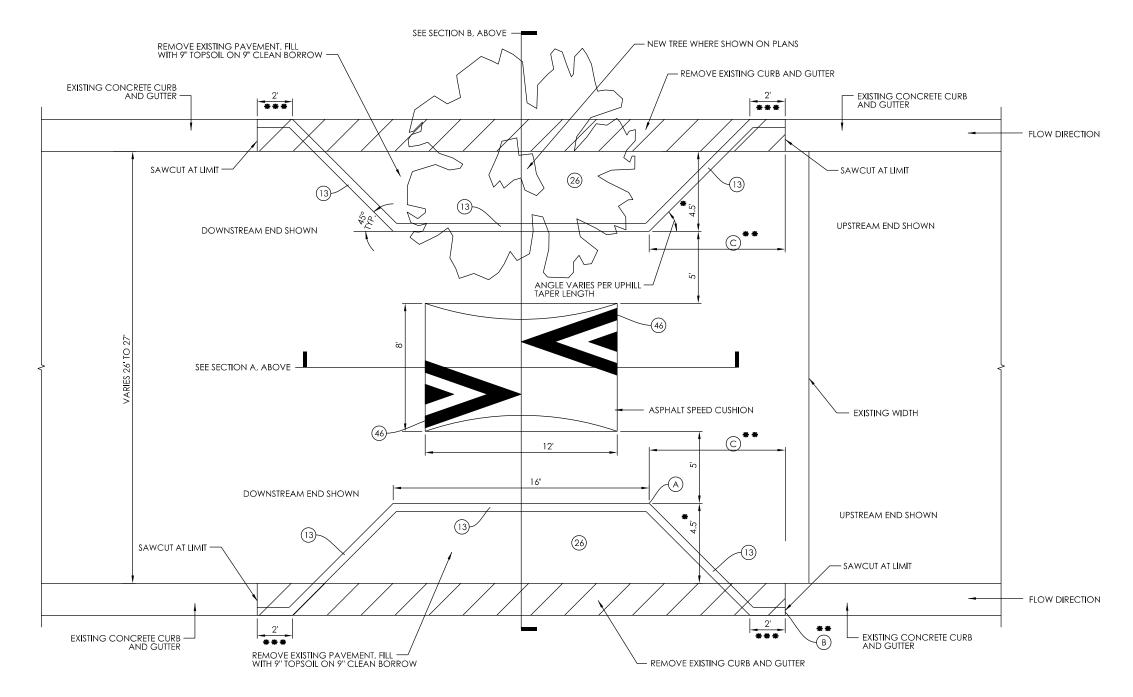NOT TO SCALE



SECTION A

SECTION B

12'

SECTION B

21'-6"

11'-6"

ASPHALT SPEED CUSHION

ASPHALT SPEED CUSHION

ASPHALT SPEED CUSHION

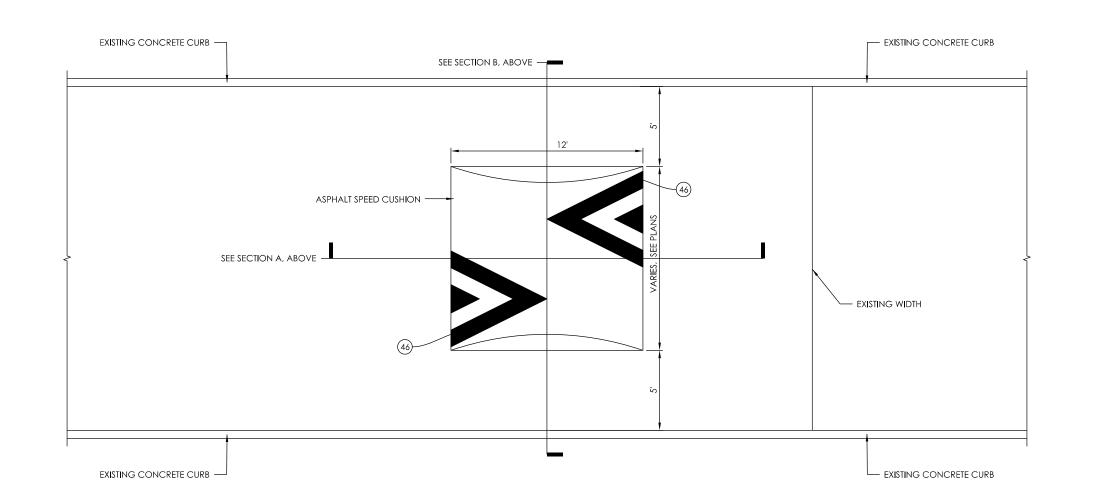
EXISTING CONCRETE CURB

EXISTING CONCRETE CURB

EXISTING CONCRETE CURB

SC6 ASPHALT SPEED CUSHION FOR FULLY CURBED ROADWAY - SECTION

NOT TO SCALE



Edge of pavement or white edge line

ASPHALT SPEED CUSHION FOR INSTALLATIONS
WITHOUT BUMPOUTS - TWIN CUSHION INSTALLATION

Edge of pavement or white edge line

CENTERLINE

MARKING (CENTER ON OUTSIDE EDGE OF CUSHION AS SHOWN)

SC6 ASPHALT SPEED CUSHION FOR FULLY CURBED ROADWAY - PLAN

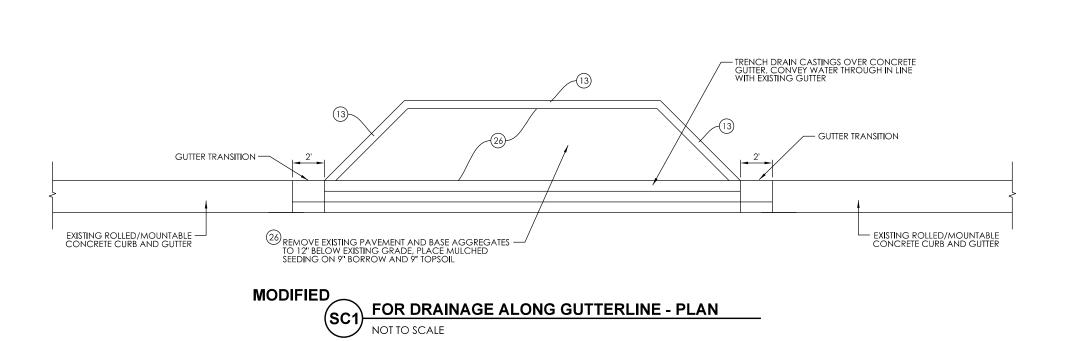
NOT TO SCALE

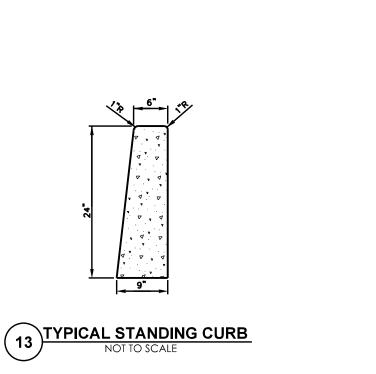
ASPHALT SPEED CUSHION FOR FULLY CURBED ROADWAY - PLAN
NOT TO SCALE

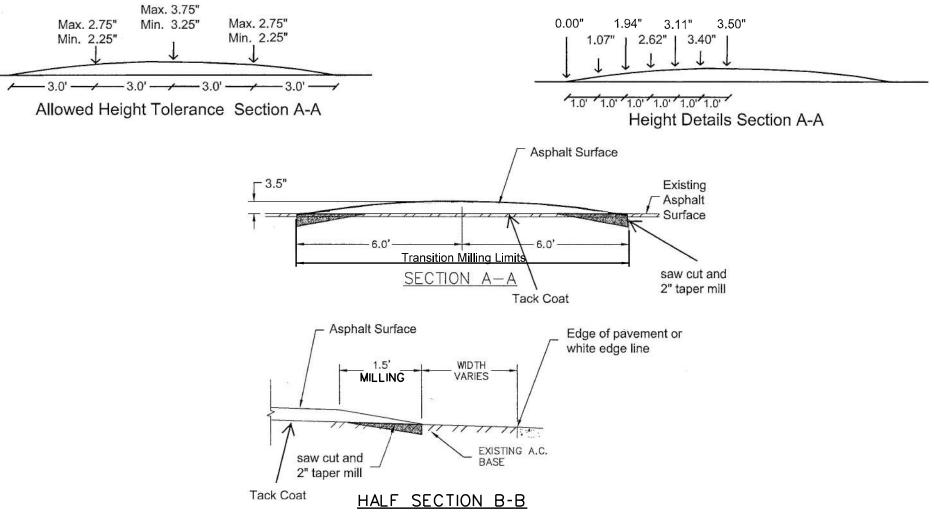
VARY THIS DIMENSION UP OR DOWN DEPENDING ON TRUE WIDTH OF STREET. EQUAL ON EACH SIDE OF STREET.

CONTRACTOR SHALL VERIFY POSITIVE DRAINAGE FROM UPSTREAM GUTTER TRANSITION B TO CORNER POINT ON THE UPHILL SIDE OF EACH BUMPOUT. SEE PLANS FOR UPHILL TAPER LENGTH (C).

2' TRANSITION SLOPED CURB AND GUTTER TO STANDARD CURB AND GUTTER SECTION







SC1 SC6 SC7 SPEED CUSHION HEIGHT TOLERANCES
NOT TO SCALE

Etica

No.

1930092
STATE OF
STONAL ENGINEERING

NO.

1930092
STATE OF
STONAL ENGINEERING

STONAL ENGINEERING

NO.

19300092
STATE OF
STONAL ENGINEERING

NO.


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STATE OF
STONAL ENGINEERING


NO.

19300092


111111111	RECOMMENDED FOR APPROVAL	B Li.	Juy DESTEN ENGINEER	10-27-2023 DATE	
ши	DESIGNED:	BR	DRAWN:	RBA	
	CHECKED:	MT	CHECKED:	BR	


	HORIZONTAL SCALE	ETICA GROUP
CITY OF BLOOMINGTON	AS NOTED	230240
DEPARTMENT OF ENGINEERING	VERTICAL SCALE	
MISCELLANEOUS DETAILS		SHEET NUMBER
MISCELLANEOUS DE IAILS		3

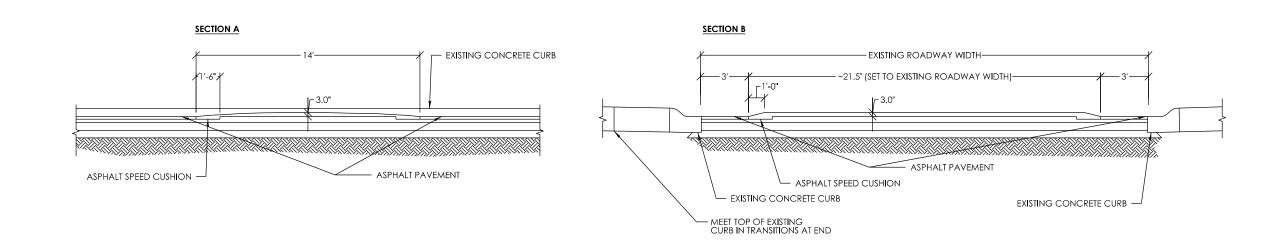

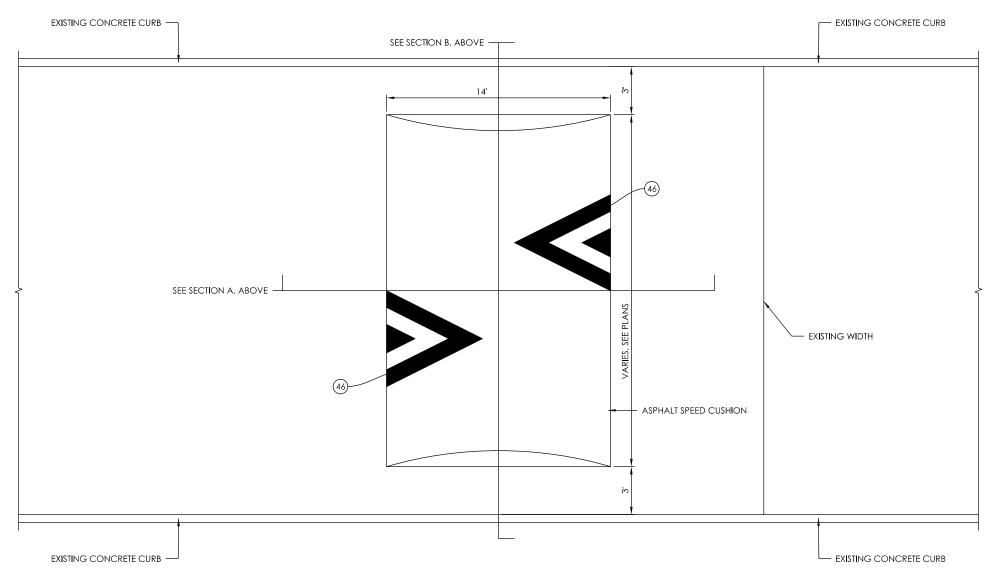


SC5 14' ASPHALT SPEED HUMP
NOT TO SCALE

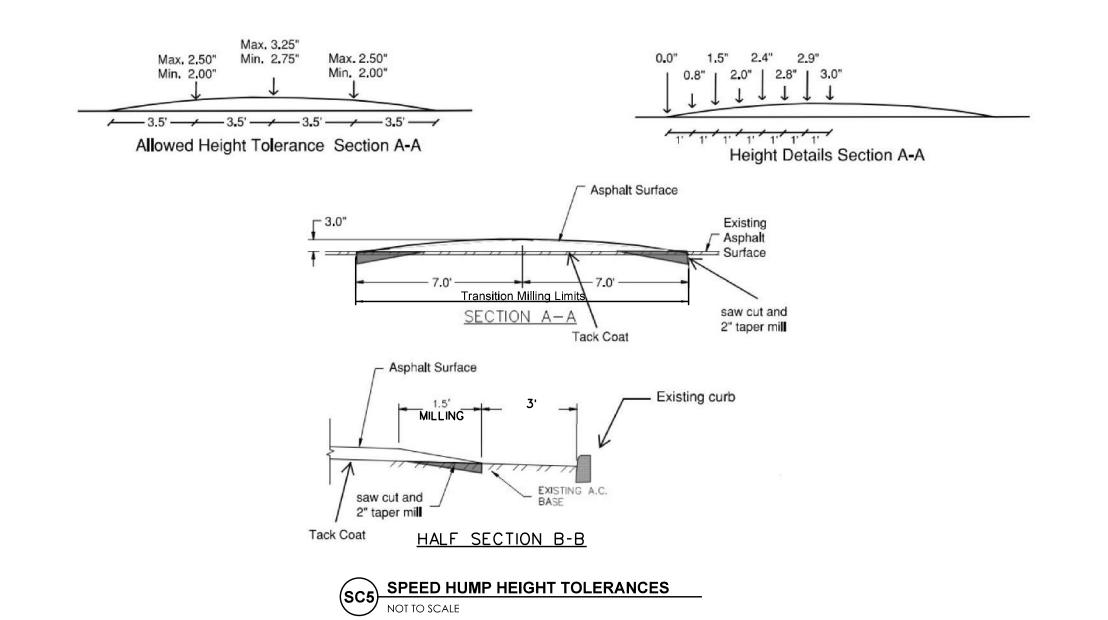

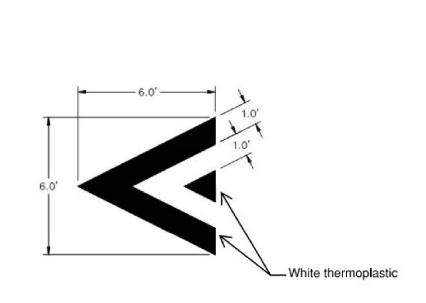


SPEED CUSHION MARKING
NOT TO SCALE

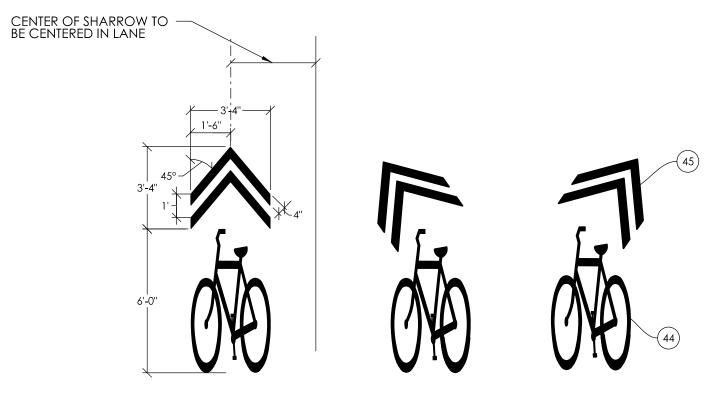


SHARED LANE MARKINGS AND CHEVRON DIMENSIONS

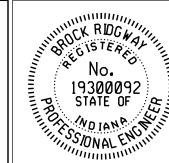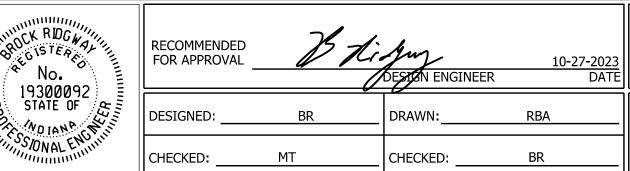NOT TO SCALE









	HORIZONTAL SCALE	ETICA GROUP
CITY OF BLOOMINGTON	AS NOTED	230240
DEPARTMENT OF ENGINEERING	VERTICAL SCALE	
MISCELLANEOUS DETAILS		SHEET NUMBER
WIISCELLANEOUS DE IAILS		4

SHEET SIGN SUMMARY TABLE																					
	SIGN DATA																				
	1001701														SIGN POST						
	LOCATION	1						SIGN	SIGN SIZE	RELOCATE EXISTING SIGN	REMOVE SIGN (Paid as Clearing)	NEW SIGN	ENCAPSU THI	LATED LEI CKNESS (in.)			1 x 12 ga. D ANCHOF	REMARKS		
STREET/SHEET	LOCATION	VICINITY ADDRES	NORTH	SOUTH	EAST	WEST	SIGN DESCRIPTION	CODE			SIGN SIZE	RE	REM (Paid	Ä	0.080			BASE		<u> </u>	- - -
		S	ž	S	ш	>			(in. x in.)	EACH	EACH		SFT	SFT	SFT	1	2	TOTAL	1		
Sheet 8 / Morningside	Btw. Smith and Saratoga	3908		Х			Existing 25 MPH	Existing	Existing		1										
Sheet 8 / Morningside	Btw. Smith and Saratoga	3908		X			7th / Longview Greenway	D11-1c	24 x 18			1	3.00			12		12			
Sheet 8 / Morningside	Btw. Smith and Saratoga	3908		Χ			Arrow Ahead	M6-1	12 x 9			1	0.75						Mount with Greenway		
Sheet 8 / Saratoga	South of Morningside	3926				Χ	Existing 25 MPH	Existing	Existing		1										
Sheet 8 / Morningside	East of Saratoga	4001		Х			SPEED HUMP	W17-1	30 x 30			1	6.25			12		12			
Sheet 8 / Morningside	East of Saratoga	4001		X			15 MPH (Advisory Plaque)	W13-1P	18 x 18			1	2.25						Mount with Speed Hump		
Sheet 10 / Morningside	East of Hampton Court	4223	X				Existing 25 MPH	Existing	Existing		1										
Sheet 10 / Morningside	East of Hampton Court	4301	X				SPEED HUMP	W17-1	30 x 30			1	6.25			12		12			
Sheet 10 / Morningside	East of Hampton Court	4301	X				15 MPH (Advisory Plaque)	W13-1P	18 x 18			1	2.25						Mount with Speed Hump		
Sheet 11 / Morningside	West of Park Ridge	4317		Х			Existing Park Speed Limit	Existing	Existing		1										
Sheet 11 / Morningside	West of Park Ridge	4317		Х			Existing 25 MPH	Existing	Existing		1										
Sheet 11 / Morningside	West of Park Ridge	4317		Х			Existing Greenway Sign	Existing	Existing	1									Move sign to top of existing post		
Sheet 11 / Morningside	West of Park Ridge	4317		Х			Arrow Ahead	M6-1	12 x 9			1	0.75						Move sign to top of existing post		
Sheet 11 / Park Ridge	Park Ridge, SE Corner	NA			Х		Existing Stop	Existing	Existing	1						12		12	Replace post with relocation		
Sheet 11 / Park Ridge	Park Ridge, SE Corner	NA			Х		Existing All Way	Existing	Existing	1									Mount with Stop		
Sheet 11 / Morningside	Park Ridge, NE Corner	NA	Х				Existing Stop	Existing	Existing	1											
Sheet 11 / Morningside	Park Ridge, NE Corner	NA	Х				Existing All Way	Existing	Existing	1									Mount with Stop		
Sheet 11 / Morningside	Park Ridge, NE Corner	NA	Х				Existing Bus Stop and Route Plaques	Existing	Existing	3									Mount under Stop		
Sheet 11 / Morningside	East of Park Ridge	NA		Х			Existing 25 MPH	Existing	Existing		1					1			·		
Sheet 11 / Morningside	East of Park Ridge	4416		X			SPEED HUMP	W17-1	30 x 30		-	1	6.25			12		12			
Sheet 11 / Morningside	East of Park Ridge	4416		X			15 MPH (Advisory Plaque)	W13-1P	18 x 18			1	2.25			Ì			Mount with Speed Hump		
Sheet 12 / Morningside	Btw. Indiana Bell Ct N &S	4488			Х		Existing Park Speed Limit	Existing	Existing		1										
Sheet 12 / Morningside	Btw. Indiana Bell Ct N &S	4488			Х		Existing 25 MPH	Existing	Existing		1										
Sheet 12 / Morningside	Btw. Indiana Bell Ct N &S	4488			X		Existing No Parking	Existing	Existing	1			1						Move sign to top of existing post		
Sheet 13 / Morningside	N. of SR 46	4517			X		Existing 25 MPH	Existing	Existing	<u> </u>	1		1								
Sheet 13 / Morningside	N. of SR 46	4517			X		SPEED HUMP	W17-1	30 x 30			1	6.25			12		12			
Sheet 13 / Morningside	N. of SR 46	4517			X		15 MPH (Advisory Plaque)	W13-1P				1	2.25					1	Mount with Speed Hump		
Sheet 14 / Saratoga	South of Morningside	3934				Х	SPEED HUMP	W17-1	30 x 30			1	6.25			12		12	1		
Sheet 14 / Saratoga	South of Morningside	3934				X	20 MPH (Advisory Plaque)	W13-1P	18 x 18			1	2.25			<u> </u>		1	Mount with Speed Hump		
Sheet 15 / Saratoga	West of Park Ridge	4233	X				SPEED HUMP	W17-1	30 x 30			1	6.25			12		12	'		
Sheet 15 / Saratoga	West of Park Ridge	4233	X				20 MPH (Advisory Plaque)	W13-1P	18 x 18			1	2.25						Mount with Speed Hump		
TOTALS										9	9		55.5					96			
PAY UNIT										EACH	EACH		SFT					LFT			

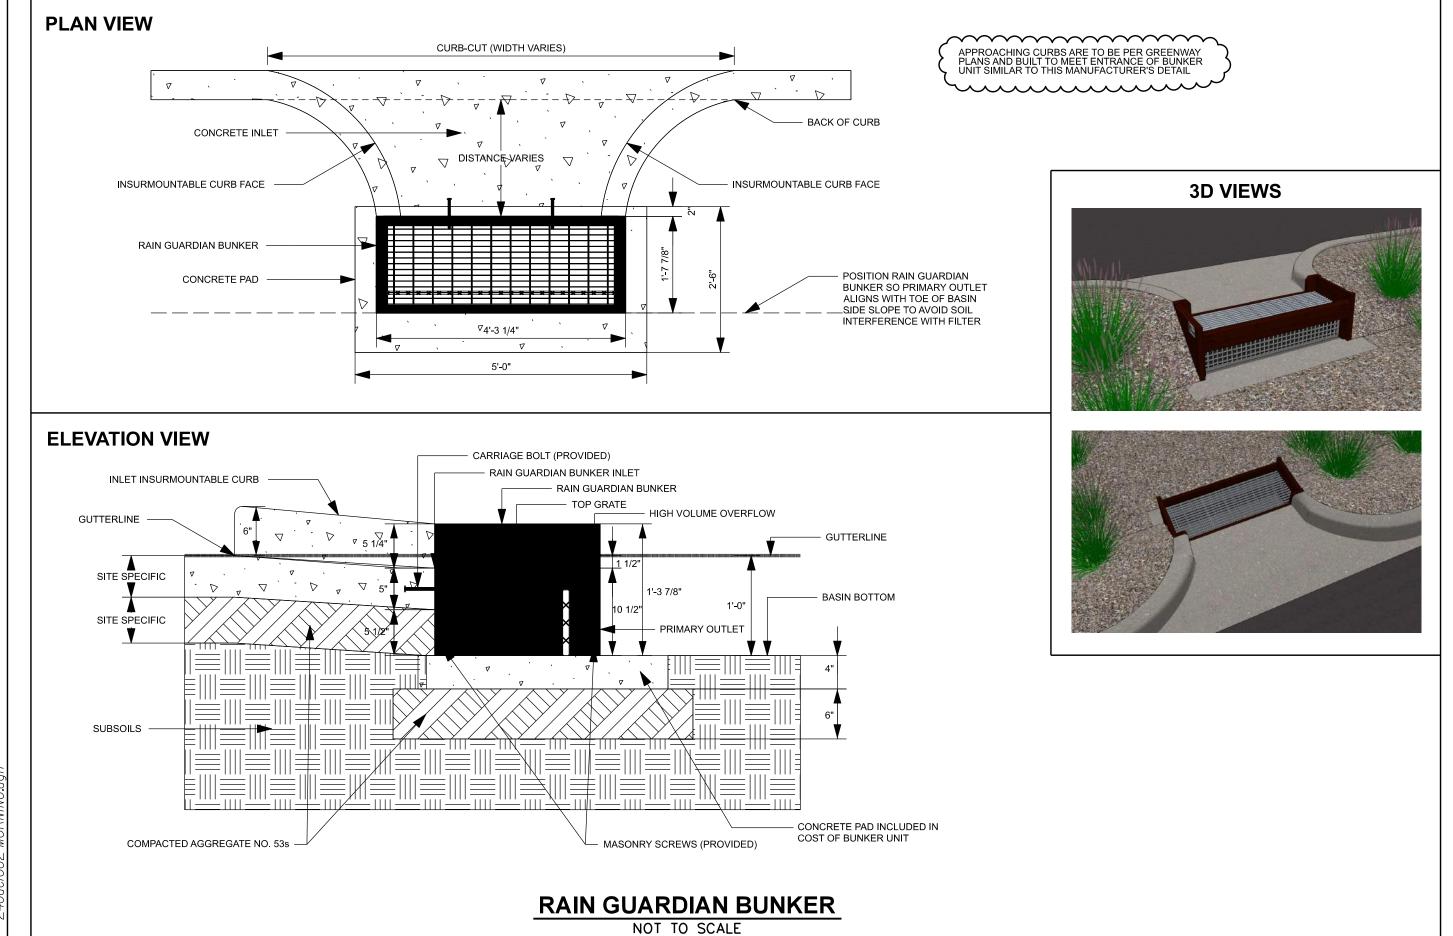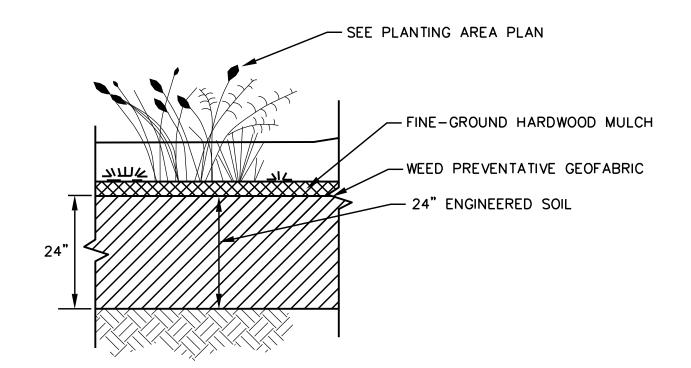PAVEMENT MARKINGS AND SIGNS SHALL BE INSTALLED BEFORE OPENING ANY LANE TO TRAFFIC THAT IS OCCUPIED BY A SPEED CUSHION. TEMPORARY MARKINGS MAY BE USED UP TO TWO WEEKS IN LIEU OF PERMANENT MARKINGS. NO ADDITIONAL PAYMENT WILL BE MADE FOR TEMPORARY MARKINGS.





RAINGARDEN SOIL PROFILE SECTION NOT TO SCALE

ENGINEERED SOIL SPECIFICATION:

ENGINEERED SOIL MIX SHALL BE 24" DEEP. BIORETENTION SOIL SHALL BE PROVIDED IN ACCORDANCE WITH APPENDIX F OF THE CITY OF BLOOMINGTON RAINWATER MANAGEMENT GUIDE - SHOULD GENERALLY BE LOAMY SAND WITH THE FOLLOWING COMPOSITION: 85% TO 88% WASHED, COARSE SAND, 8% TO 12% SOIL FINES AND 3% TO 5% ORGANIC MATTER FROM PINE BARK, WITH A P-INDEX BETWEEN 10 AND 30. A MINIMUM INFILTRATION RATE OF 0.5 INCHES PER HOUR, AND A CLAY CONTENT OF LESS THAN 6%. THE MIXTURE SHALL BE WELL BLENDED TO PRODUCE A HOMOGENEOUS MIX. THE FINAL MIX TO BE DETERMINED BY THE ENGINEER BASED ON SAMPLES AND TEST RESULTS SUBMITTED.

RAINGARDEN NOTES:

- 1. RAINGARDENS WITHOUT UNDERDRAINS OR OVERFLOW STRUCTURES SHALL INCLUDE ONLY THE 24" ENGINEERED SOIL OVERTOPPED WITH A WEED PREVENTATIVE GEOFABRIC AND 2"-3" OF RIVERROCK COVER.
- 2. GEOFABRIC TO BE CUT OUT FOR PLANTINGS.
- 3. RIPRAP-RIVER ROCK AT ENTRY AND EXIT POINTS SHALL BE LARGER AGGREGATE THAN LANDSCAPING RIVER ROCK BUT OF SAME COLORS AND SHAPE (COBBLE STONES, ETC.)

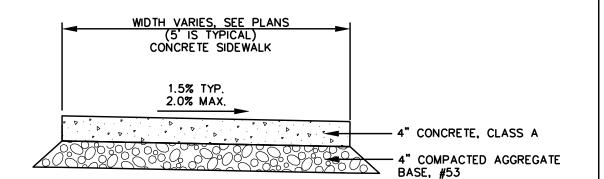
-3 EA. #5 BARS ON 9" VERTICAL CENTERS

LAP ALL BARS AROUND CORNERS,

ALL STEEL TO BE EPOXY COATED, BUT MAY BE FIELD BENT

CURVES AND BENDS 2' MIN.

4. HARDWOOD MULCH AND RIPRAP-RIVER ROCK TO BE APPROVED IN ADVANCE BY ENGINEER.



TYPICAL SIDEWALK DETAIL NOT TO SCALE

SIDEWALK JOINT NOTES:

- 1. INSTALL 1/2" PREFORMED JOINT FILLER BETWEEN SIDEWALKS AND ANY OTHER FIXED FEATURES (CURBS, STEPS, RAMPS, BUILDINGS, ETC.)
- 2. IN EACH SIDEWALK SEGMENT, TOOL CONSTRUCTION JOINTS AT EVEN SPACING BUT NO MORE THAN 6' MAXIMUM APART. INSTALL AN EXPANSION JOINT WITH 1/2" PREFORMED JOINT FILLER AT A MAXIMUM SPACING EVERY 30' IN SIDEWALKS, AND AT EACH SIDEWALK CONNECTION TO OTHER SIDEWALKS, AT CURBS, AND AT RAMPS.
- 3. CONTRACTION AND EXPANSION JOINTS SHALL BE INSTALLED BY TOOLING, BUT FINAL SURFACE SHALL BE BROOM FINISHED. NO "WINDOW-PANE" OR SIMILAR TOOLING SHALL BE USED.

CONCRETE SLAB JOINT NOTES:

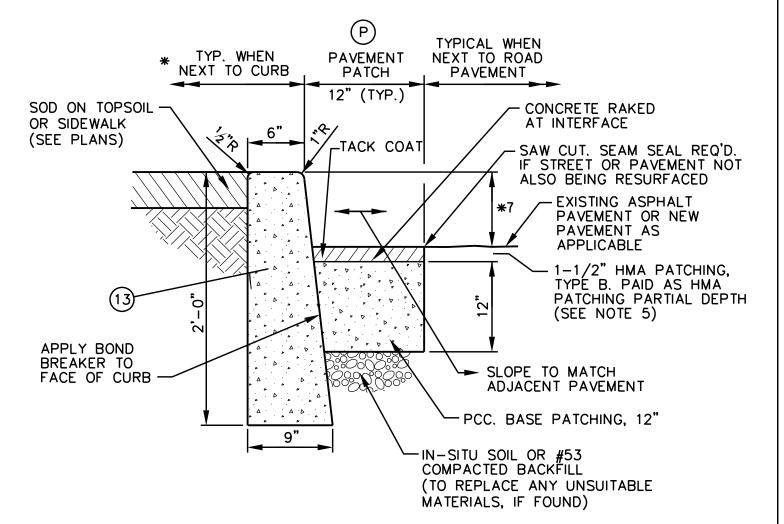
1. CONCRETE SLAB CONSTRUCTION AND EXPANSION JOINTS SHALL BE IN ACCORDANCE WITH INDOT STANDARDS.

CURB JOINT NOTES:

- 1. ALL CURBS SHALL RECEIVE A FULL DEPTH EXPANSION JOINT FORMED WITH 1/2" PREFORMED JOINT FILLER AT THE FOLLOWING LOCATIONS:
- EVERY EXPANSION JOINT IN ADJACENT SIDEWALKS OR MEDIAN BUFFER STRIP
- AT EACH RADIUS POINT - ON EITHER SIDE OF CURB INLETS OR OTHER CASTINGS
- AT SAWCUT, LIMITS OF REMOVAL TO ANY EXISTING CURB - AT 100' MAXIMUM INTERVALS, IF NO OTHER JOINTS NEEDED
- 2. CURBS & COMBINED CURB AND GUTTER SHALL RECEIVE A TOOLED CONTRACTION JOINT AT 20' MAXIMUM SPACING.


CURB RAMPS AND TRUNCATED DOMES:


1. RAMPS TO BE CONSTRUCTED AT A MAXIMUM 12:1 SLOPE TO A LANDING AREA FOR ENTRY ONTO ROADWAY PER PLANS.



PAVEMENT PATCH / CONCRETE CURB (VERTICAL)

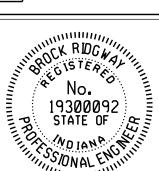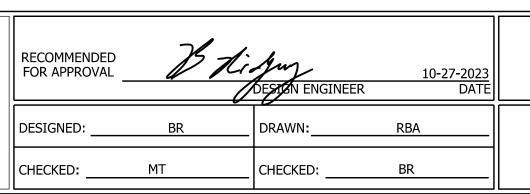- * 1. AREA BEHIND CURBS TO RECEIVE TREATMENT AS SHOWN ON PLANS.
- 2. REFER TO CURB JOINTS NOTES FOR CURB JOINTING.
- 3. PAVEMENT PATCHING MAY NOT BE REQUIRED IF EXISTING PAVEMENT CAN BE REMOVED TO A CLEAN AND STRAIGHT EDGE AT FRONT OF PROPOSED CURB OR GUTTER. OWNER APPROVAL IS REQUIRED.
- 4. PAVEMENT PATCHING REQUIRED WHEREVER PAVEMENT IS CUT, AND WHERE EXISTING PAVEMENT IS DAMAGED TO COMPLETE THE REQUIRED CURB, DRIVE OR SIDEWALK WORK.
- 5. CONTRACTOR SHALL ASSUME THEY ARE TO PLACE THE ASPHALT OVERLAY ON ALL PATCHED AREAS UNLESS OTHERWISE DIRECTED.
- 6. PATCHING PORTION OF THIS DETAIL TO ALSO BE USED WITH 14 REINFORCED CONCRETE CURB FOR RAINGARDENS.
- EXPOSED CURB HEIGHT VARIES, BUMPOUTS SHALL BE TYPICAL 4", RAINGARDENS 6", OTHER LOCATIONS MATCH EXISTING.






REINFORCED CONCRETE

CURB FOR RAINGARDENS

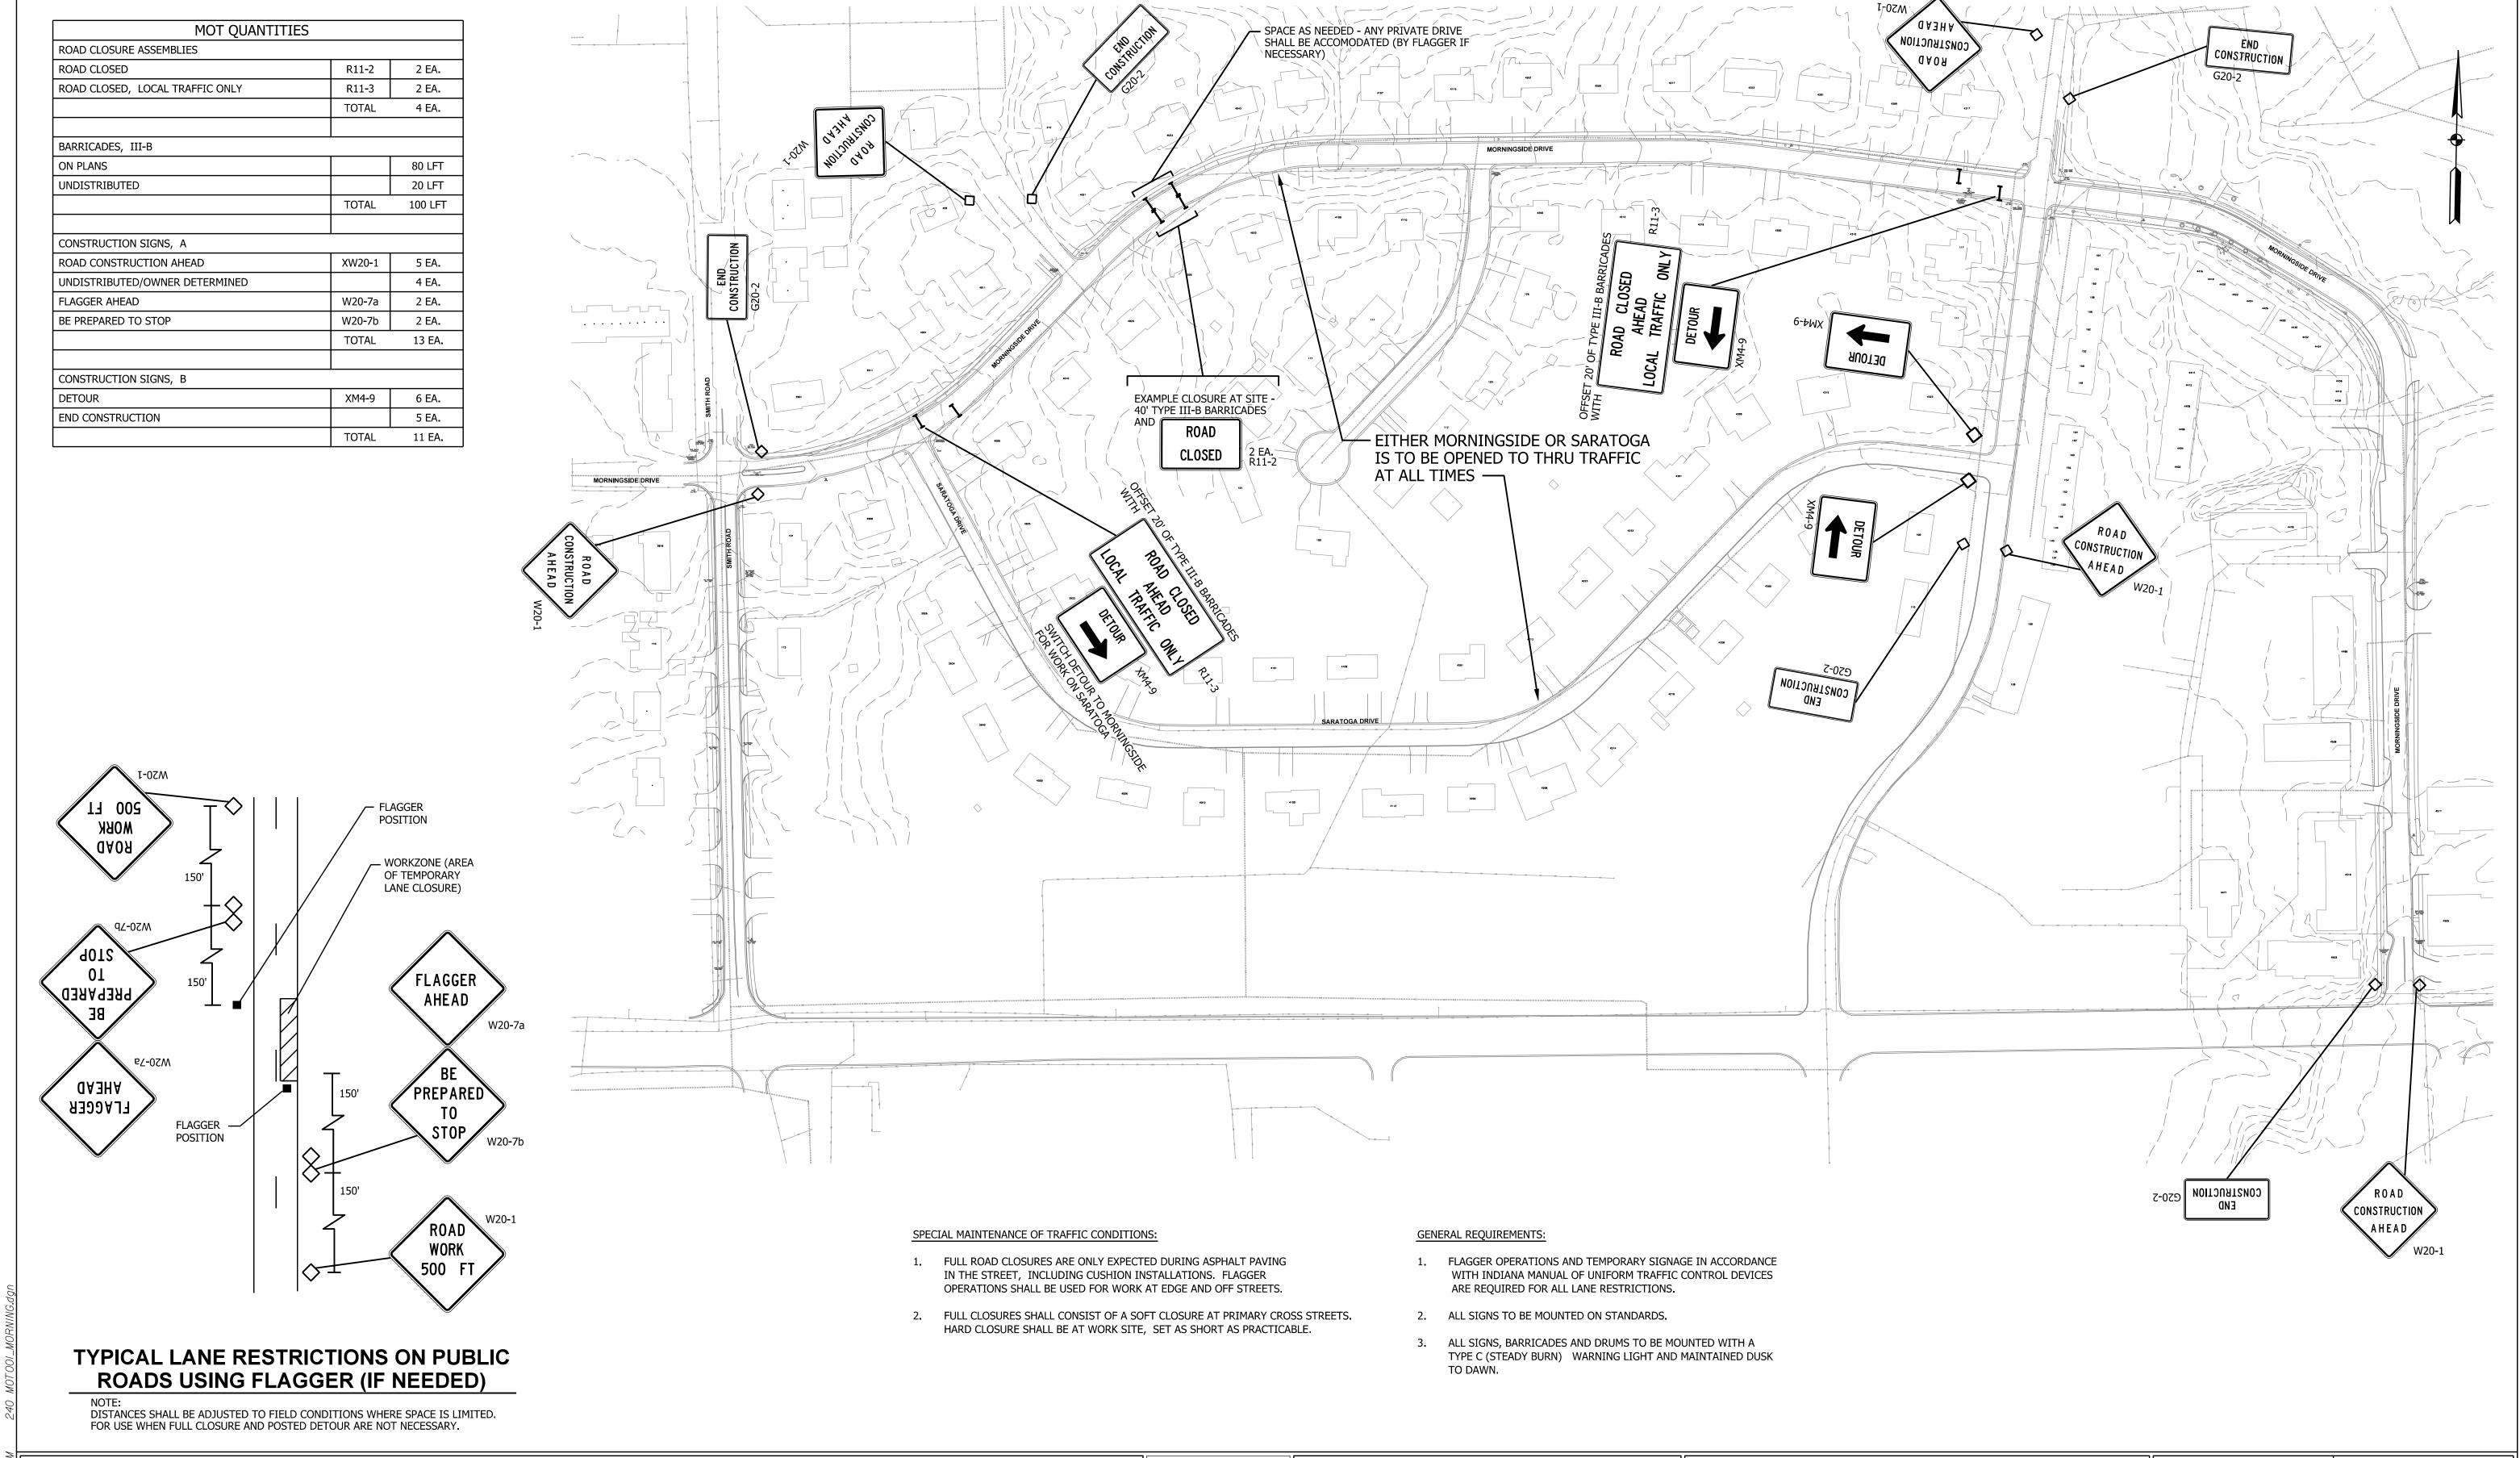NOT TO SCALE

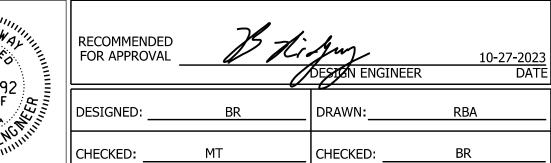
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DEPARTMENT OF ENGINEERING	VERTICAL SCALE	
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CITY OF BLOOMINGTON
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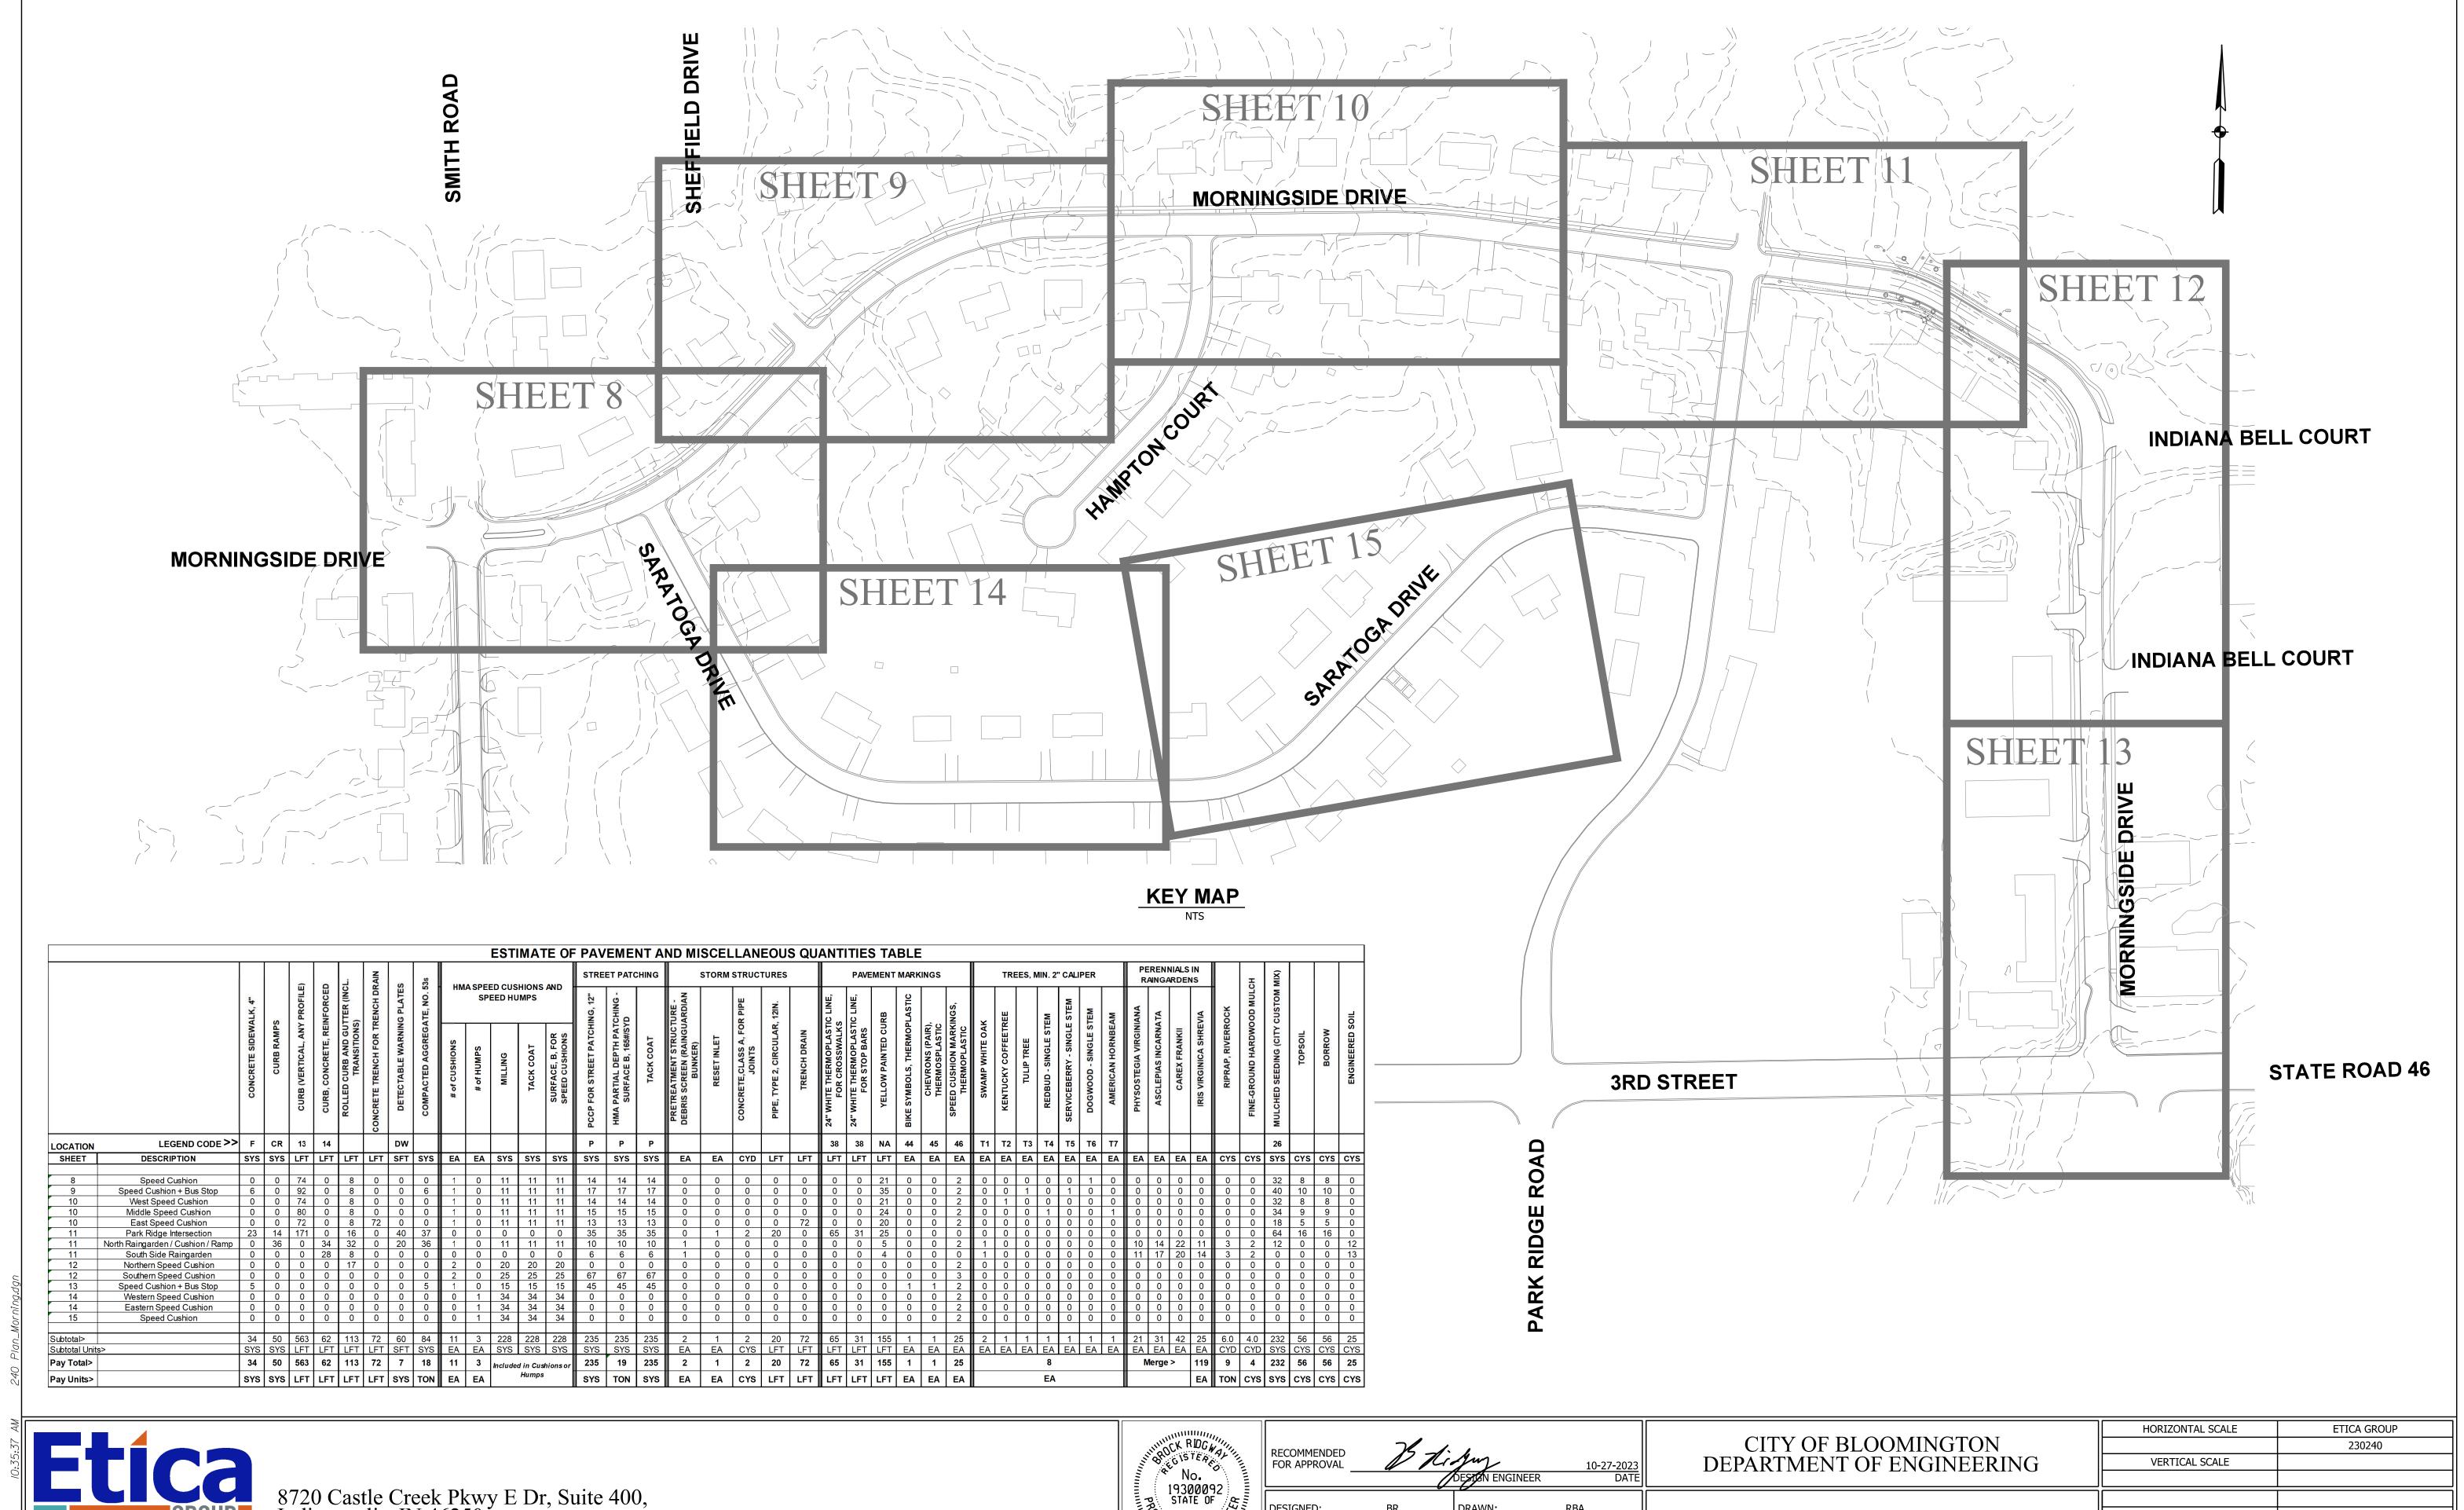
MAINTENANCE OF TRAFFIC PLAN

HORIZONTAL SCALE

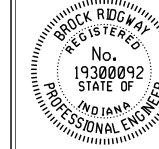
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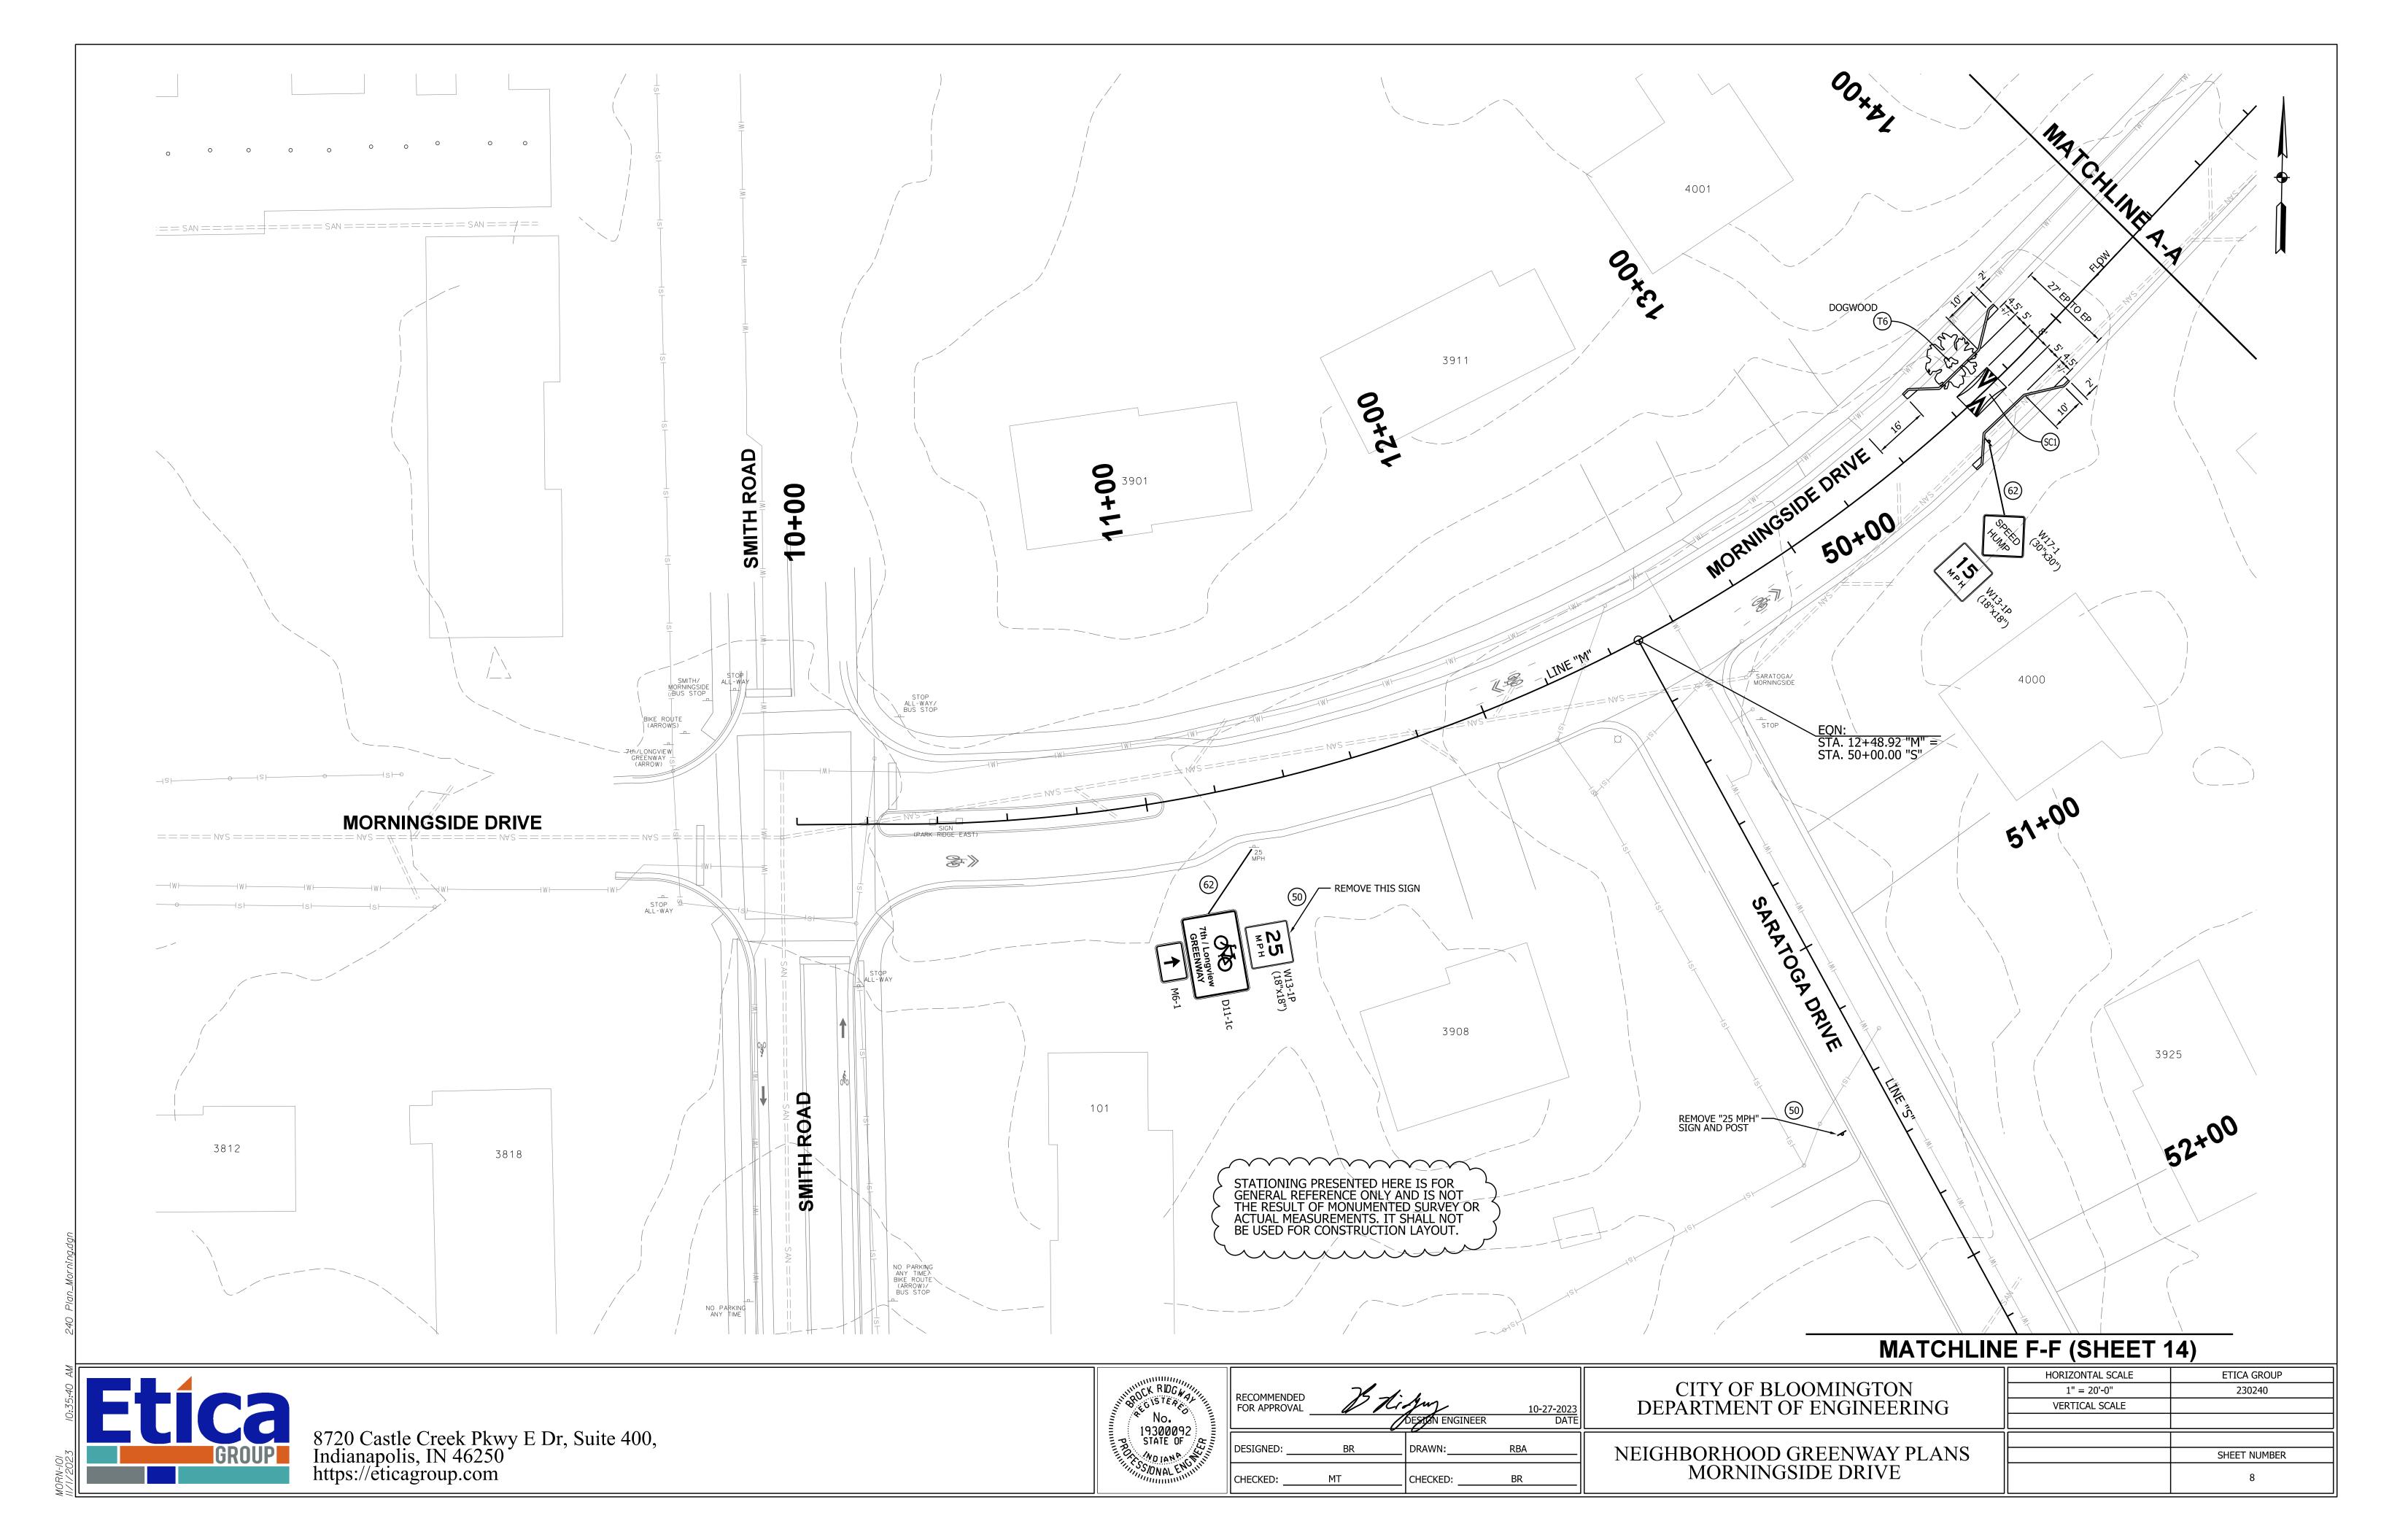


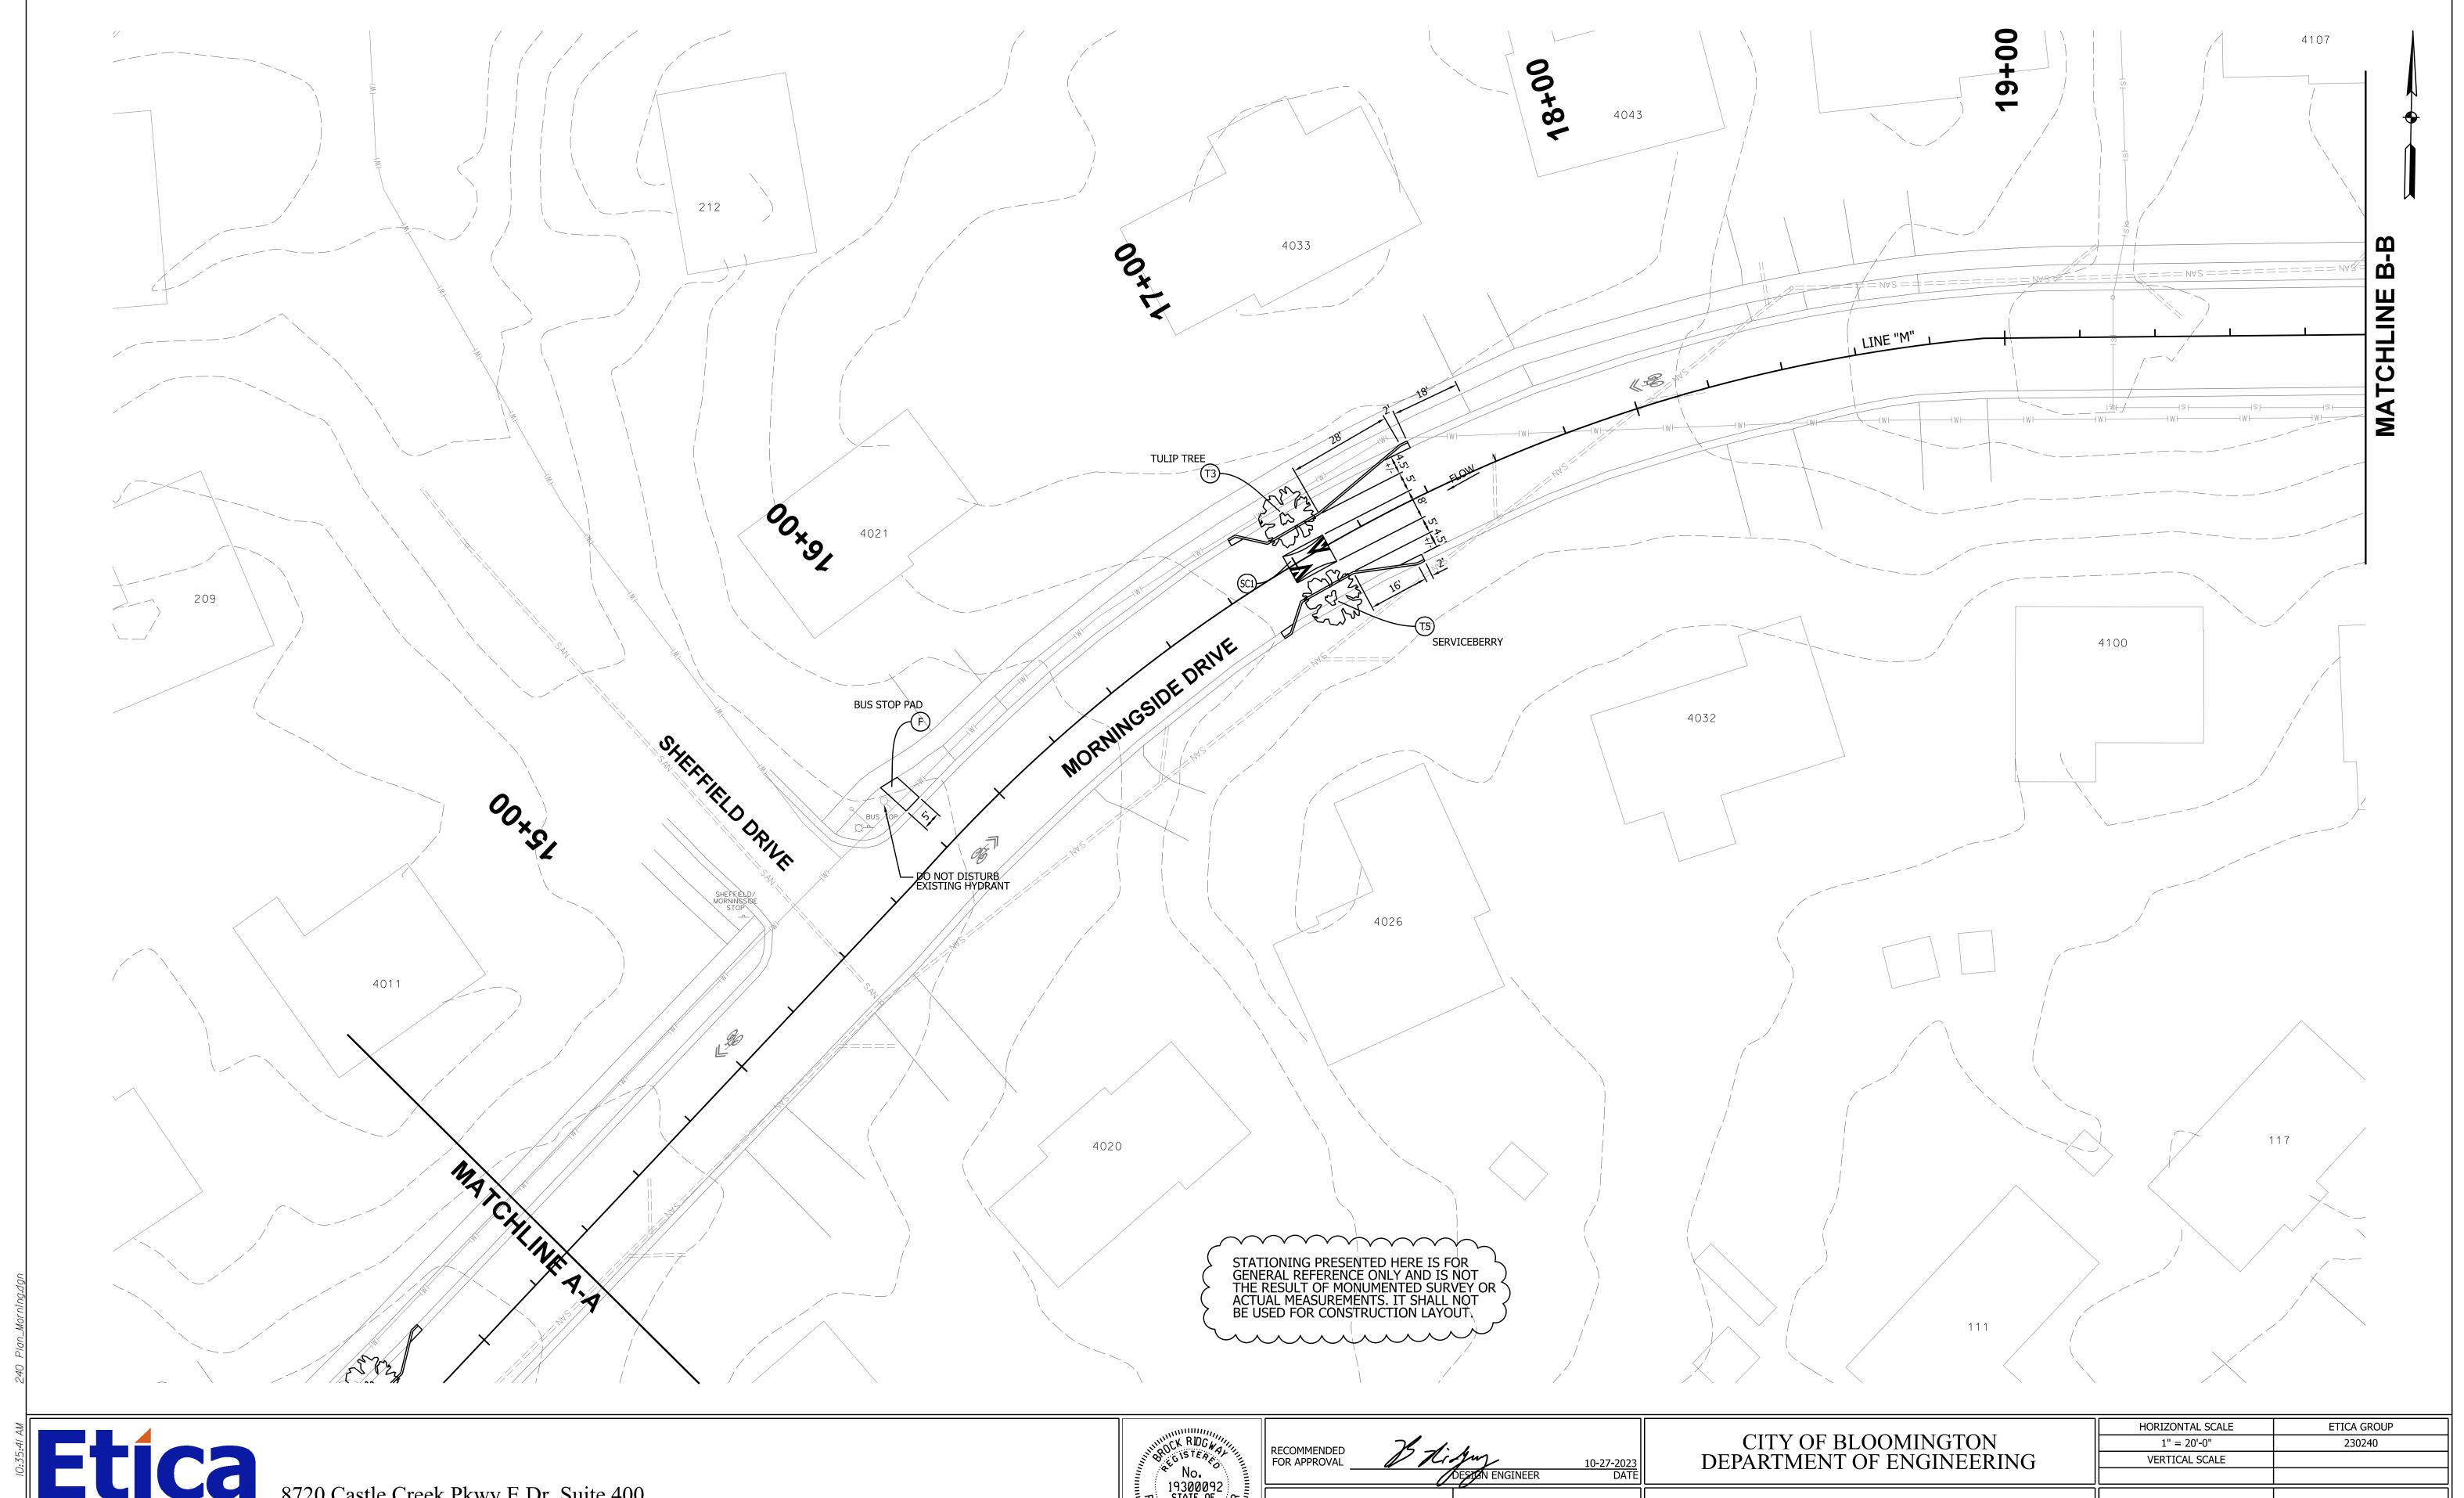




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	HORIZONTAL SCALE	ETICA GROUP
CITY OF BLOOMINGTON		230240
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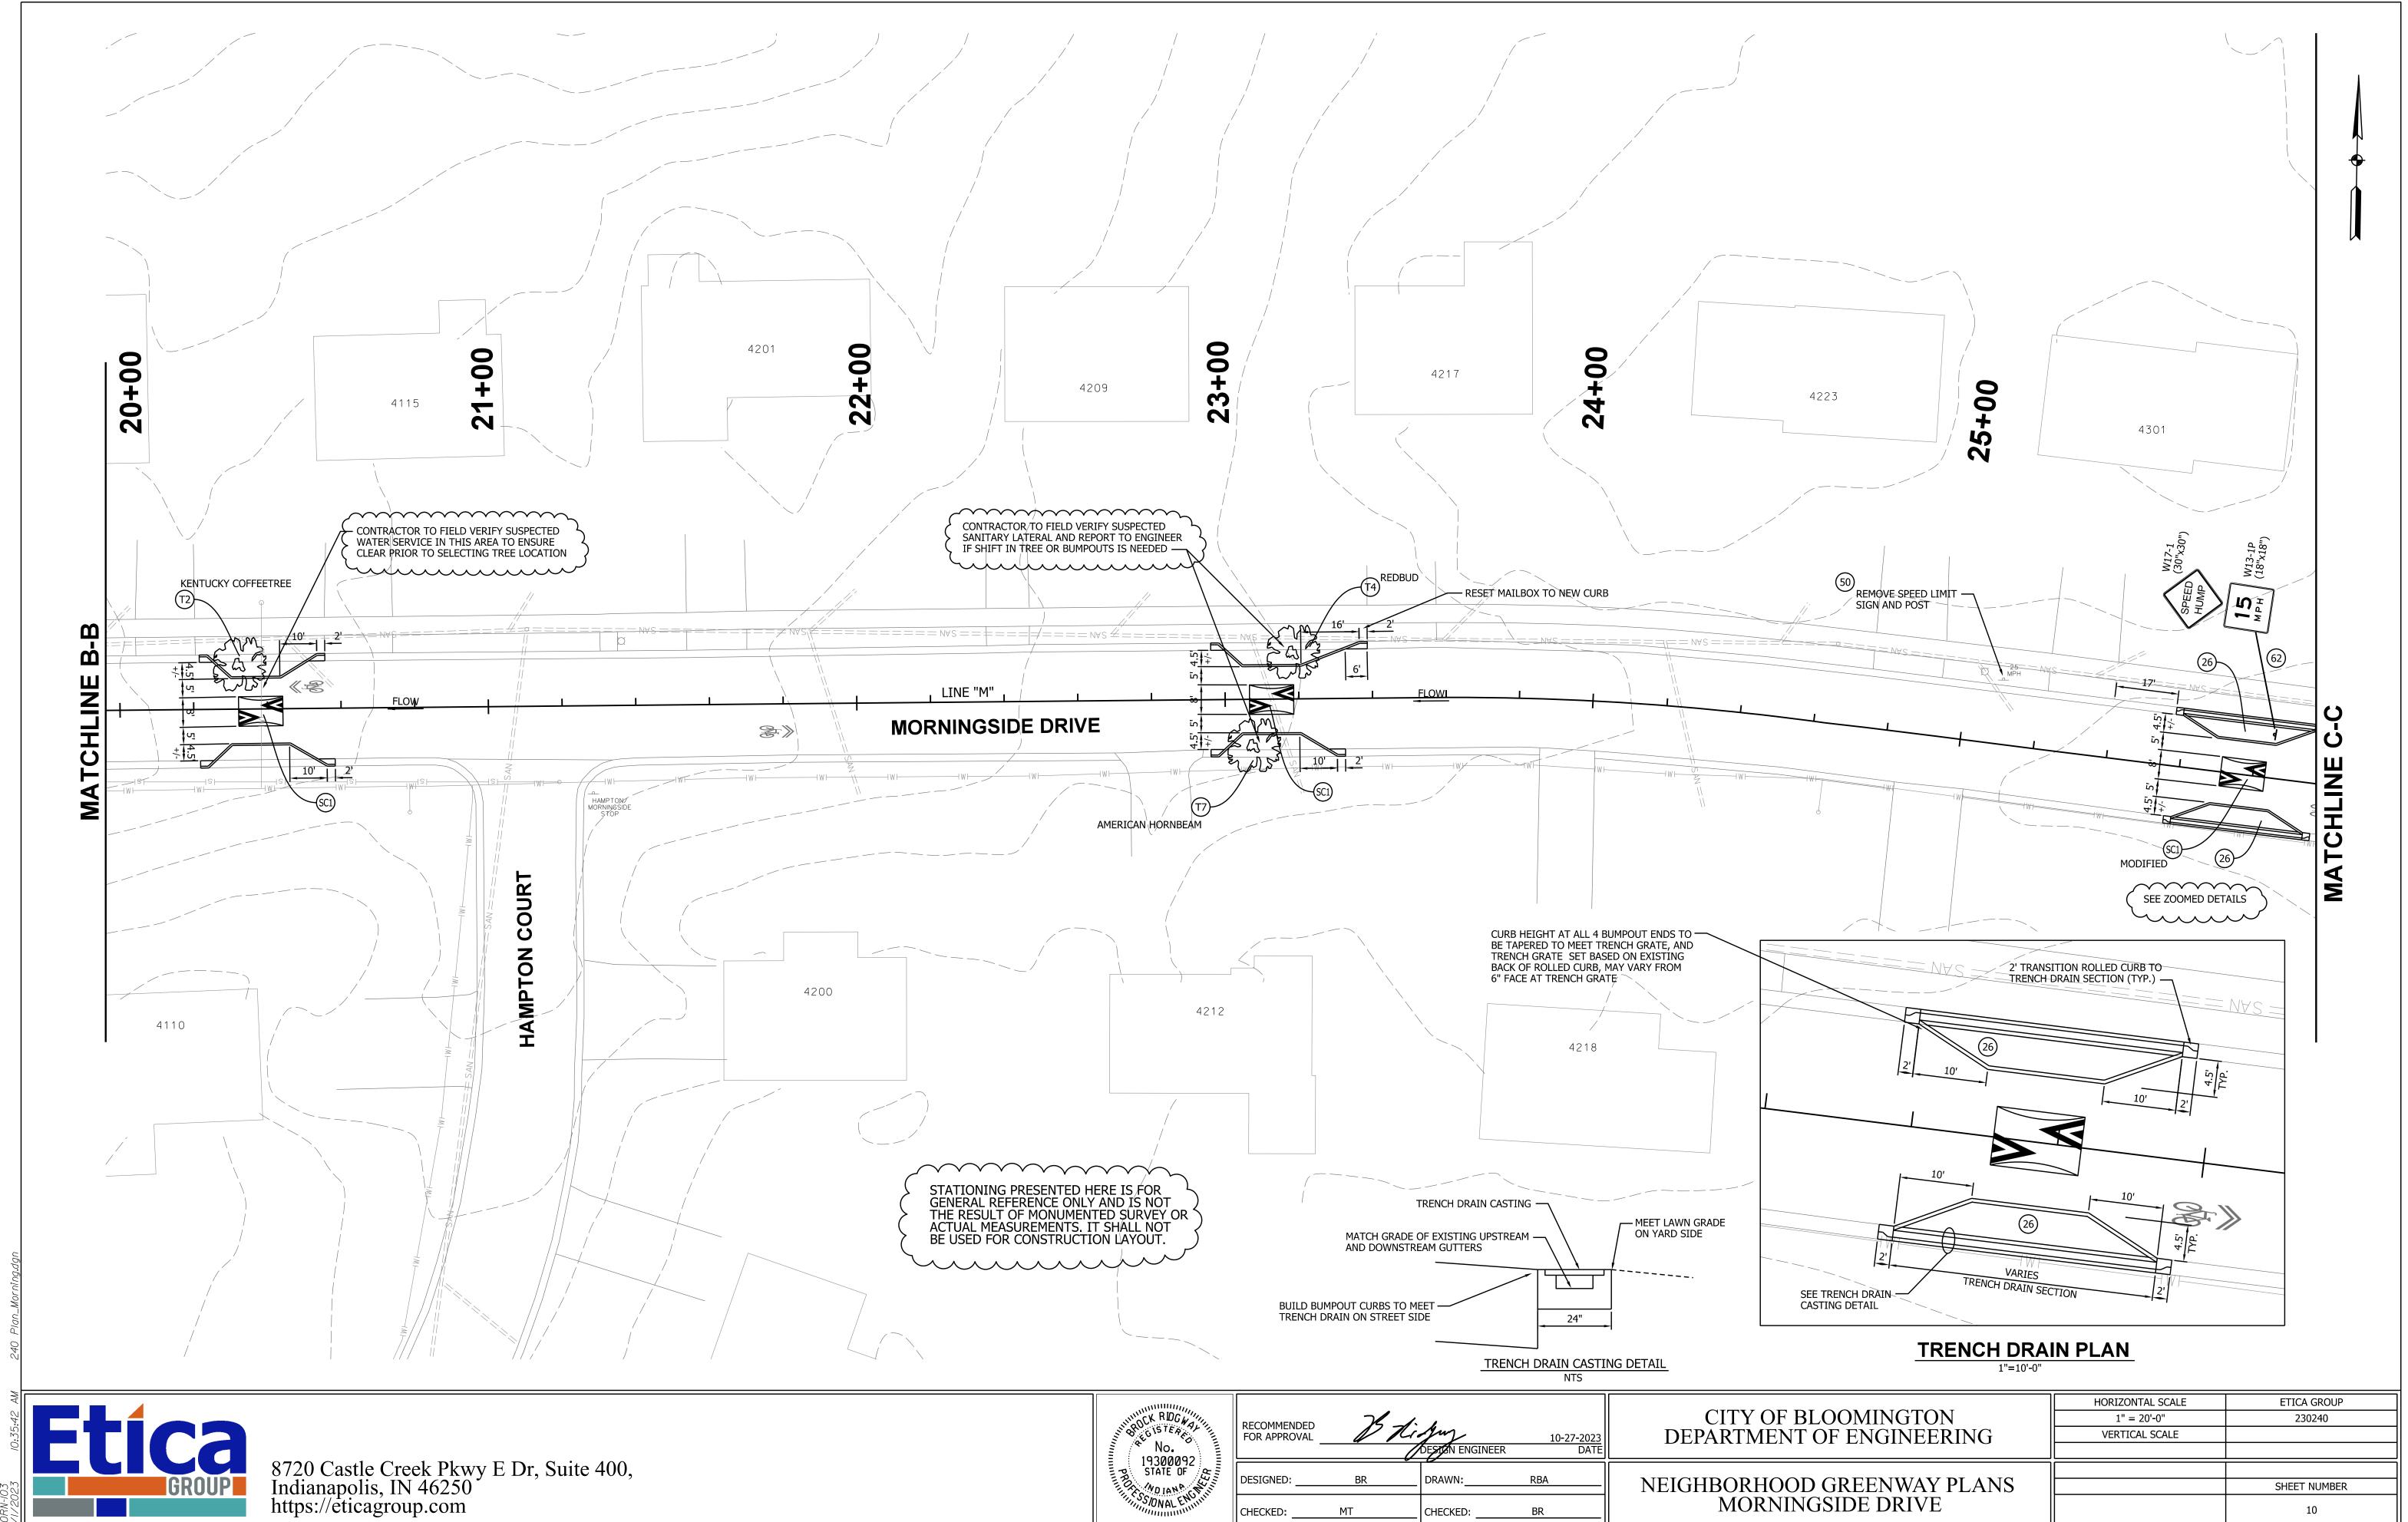




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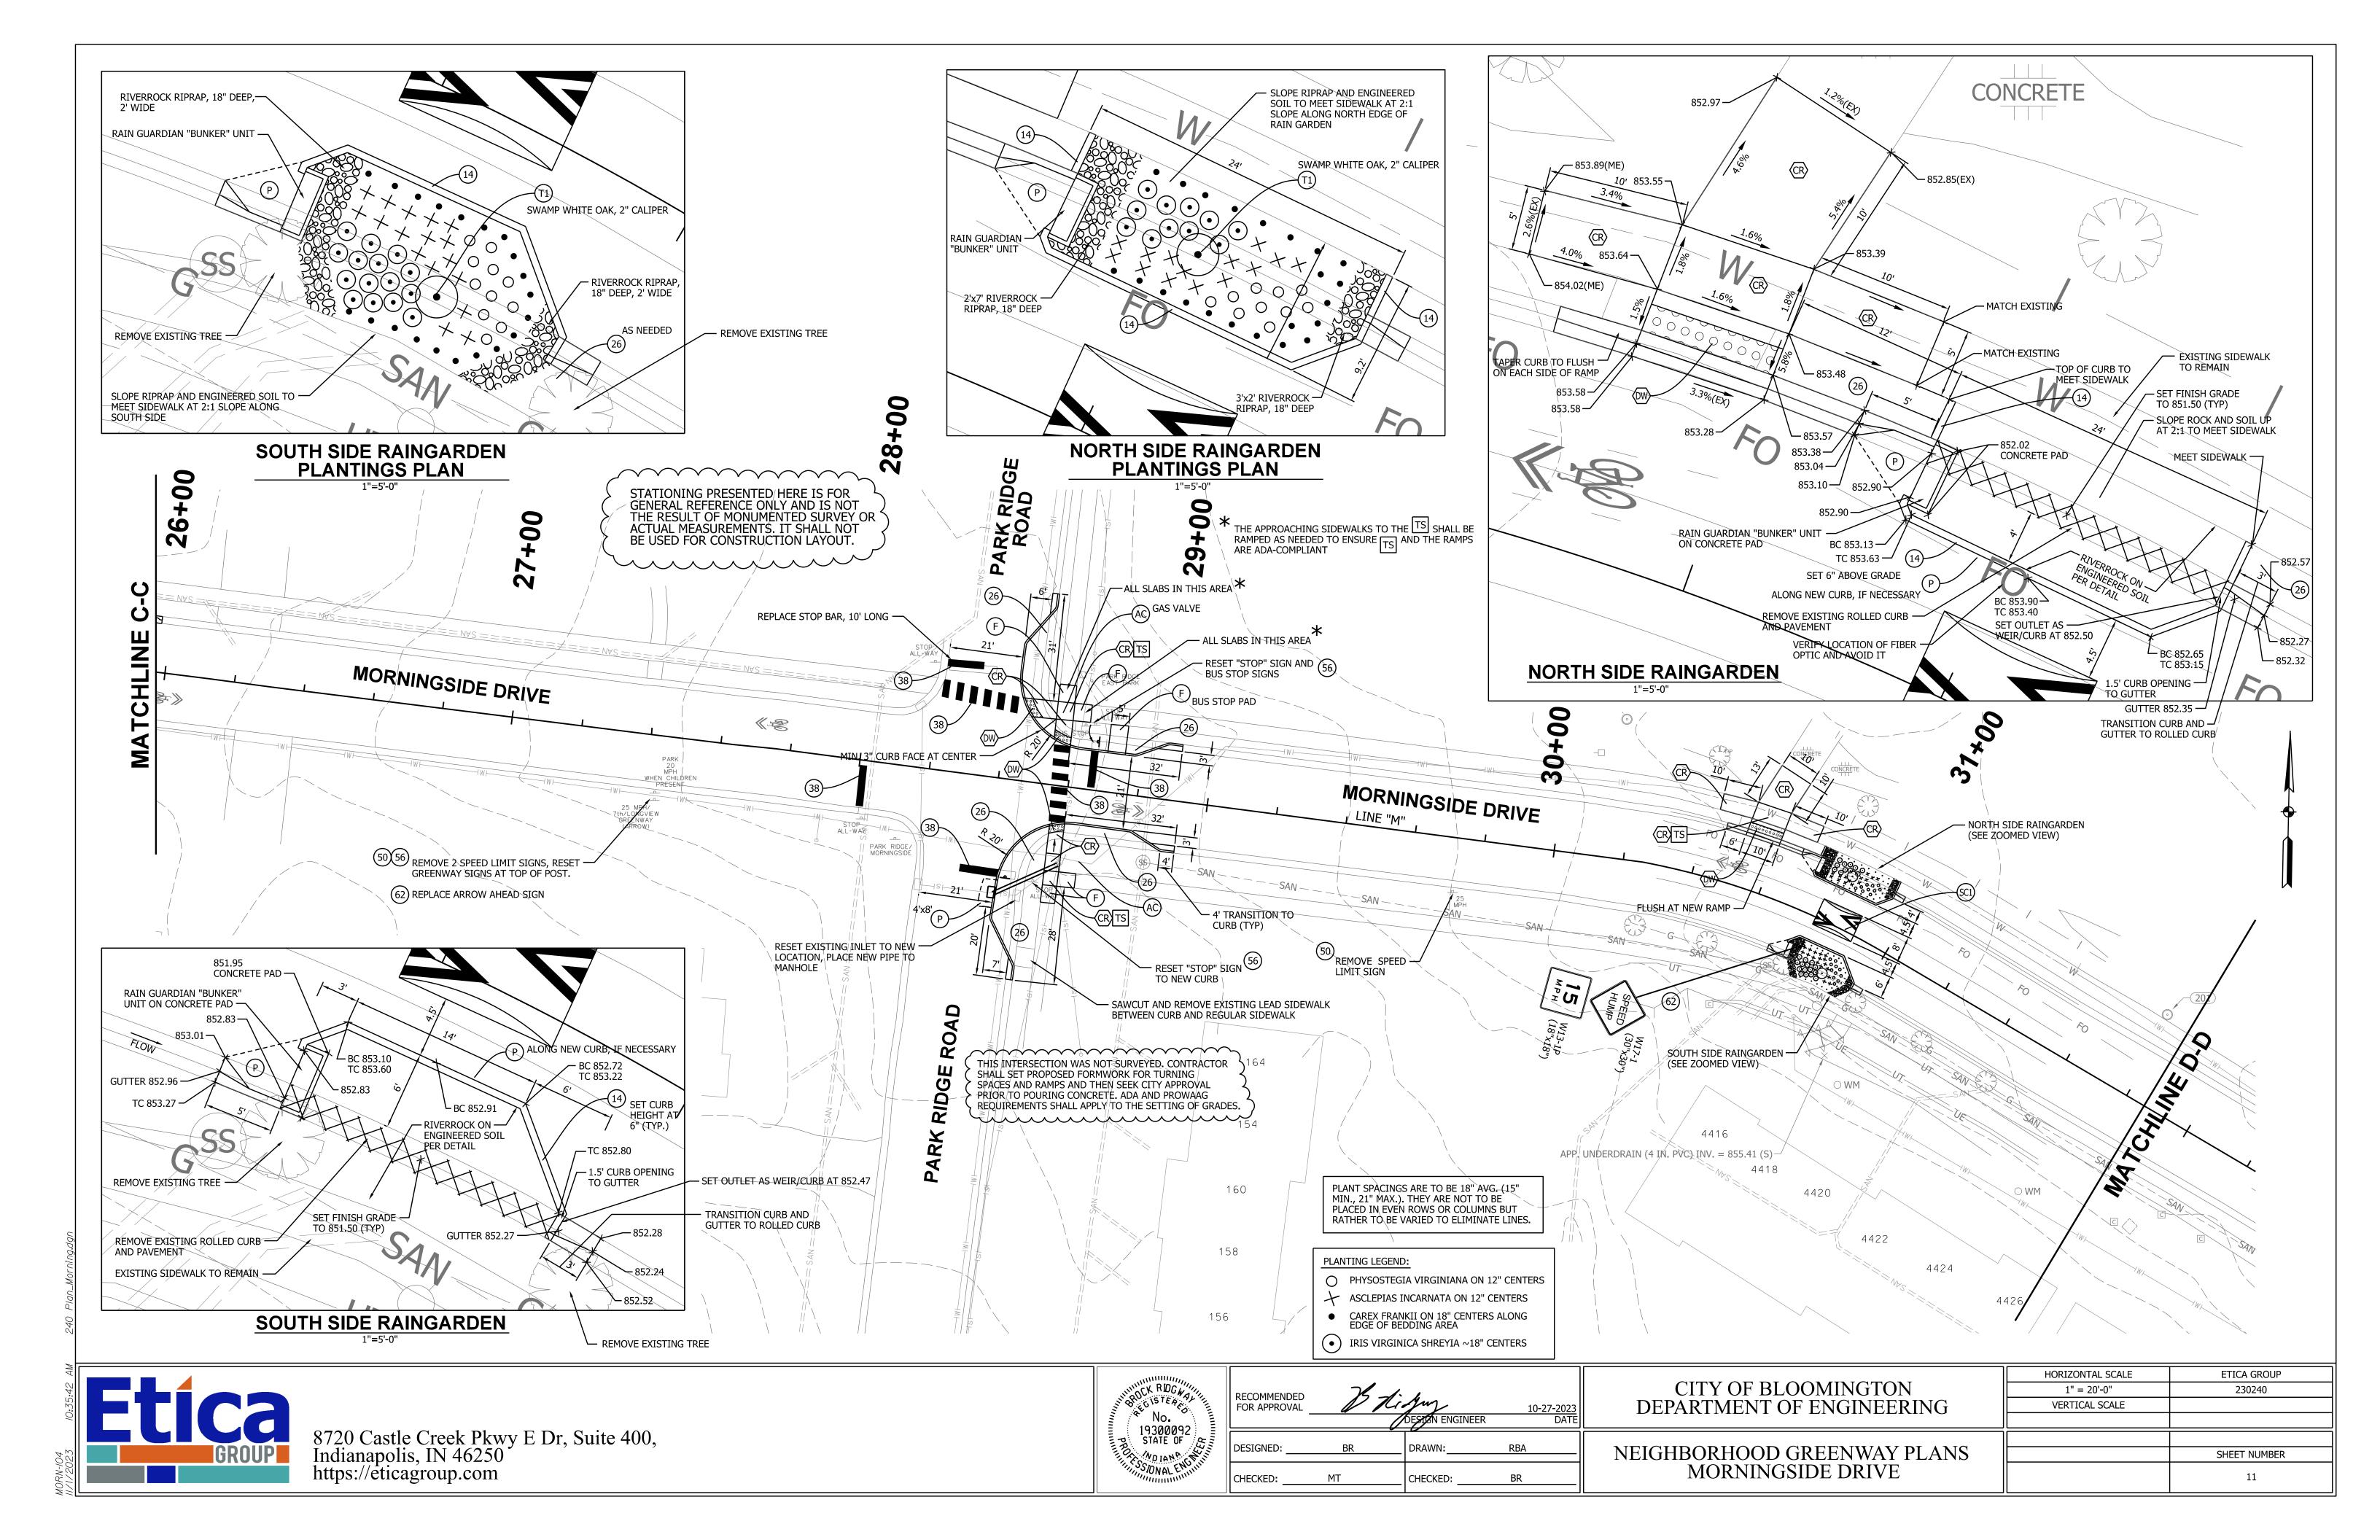
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NEIGHBORHOOD GREENWAY PLANS MORNINGSIDE DRIVE		

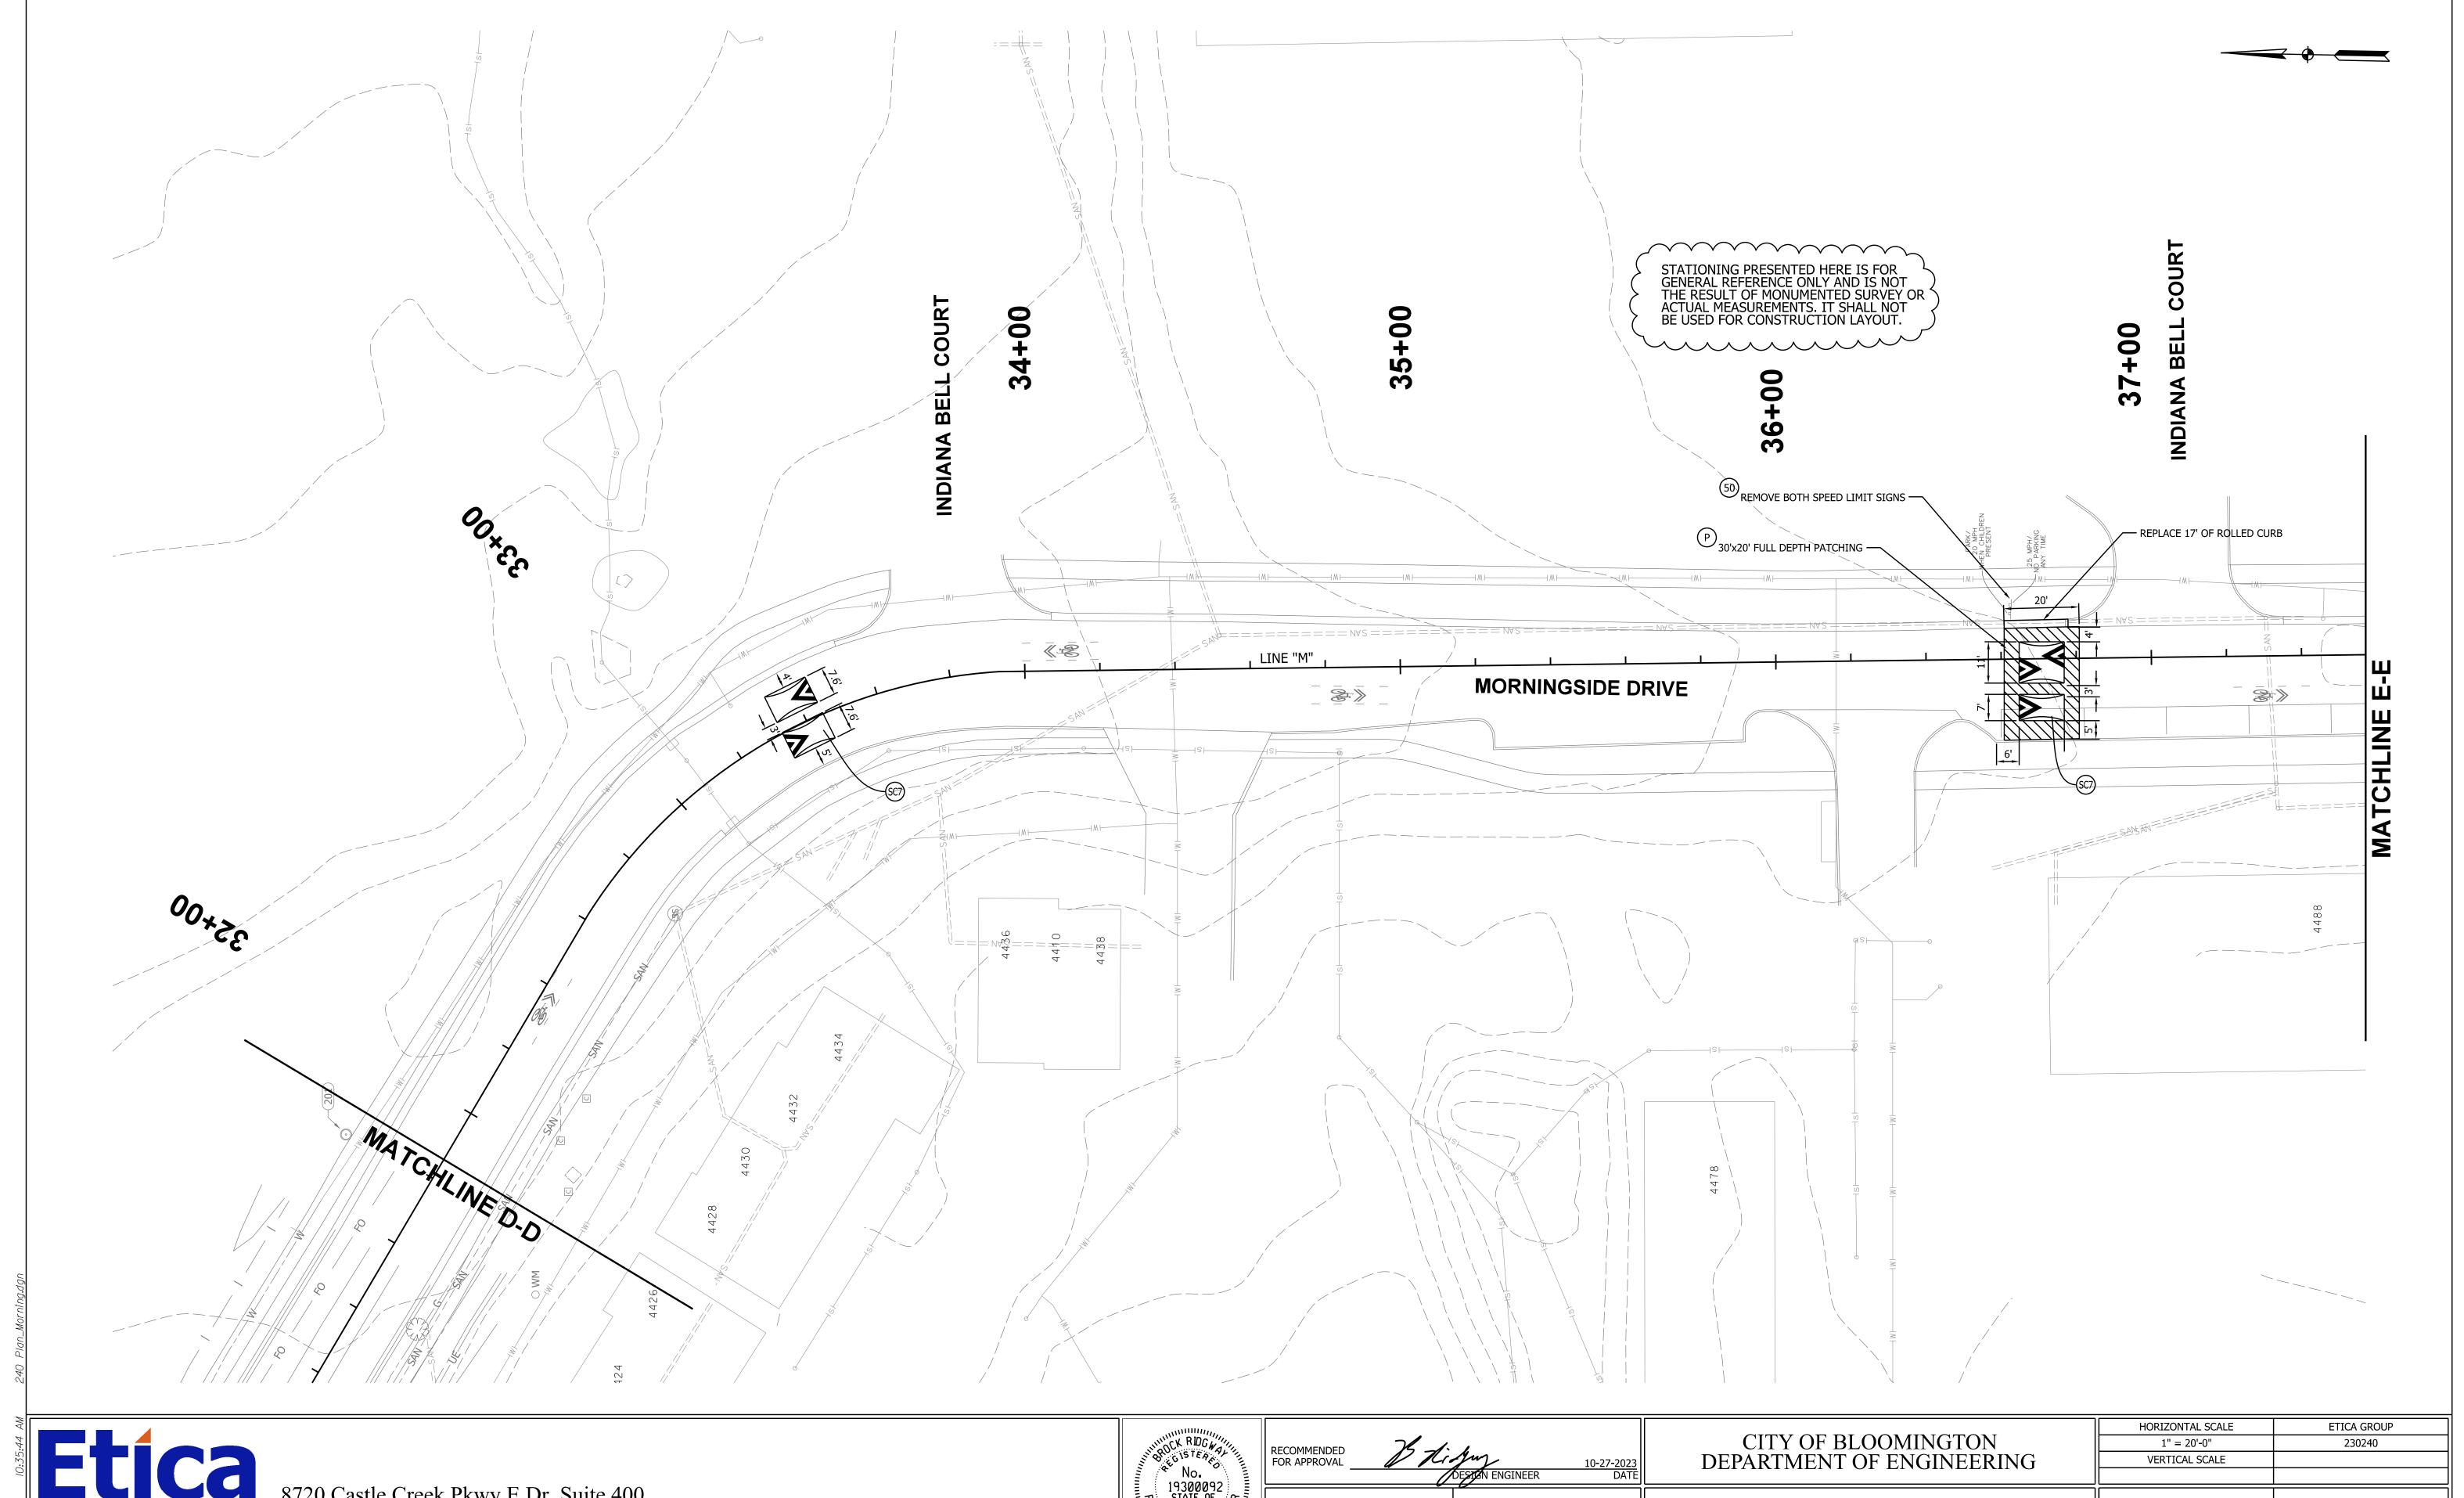
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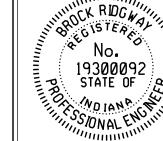


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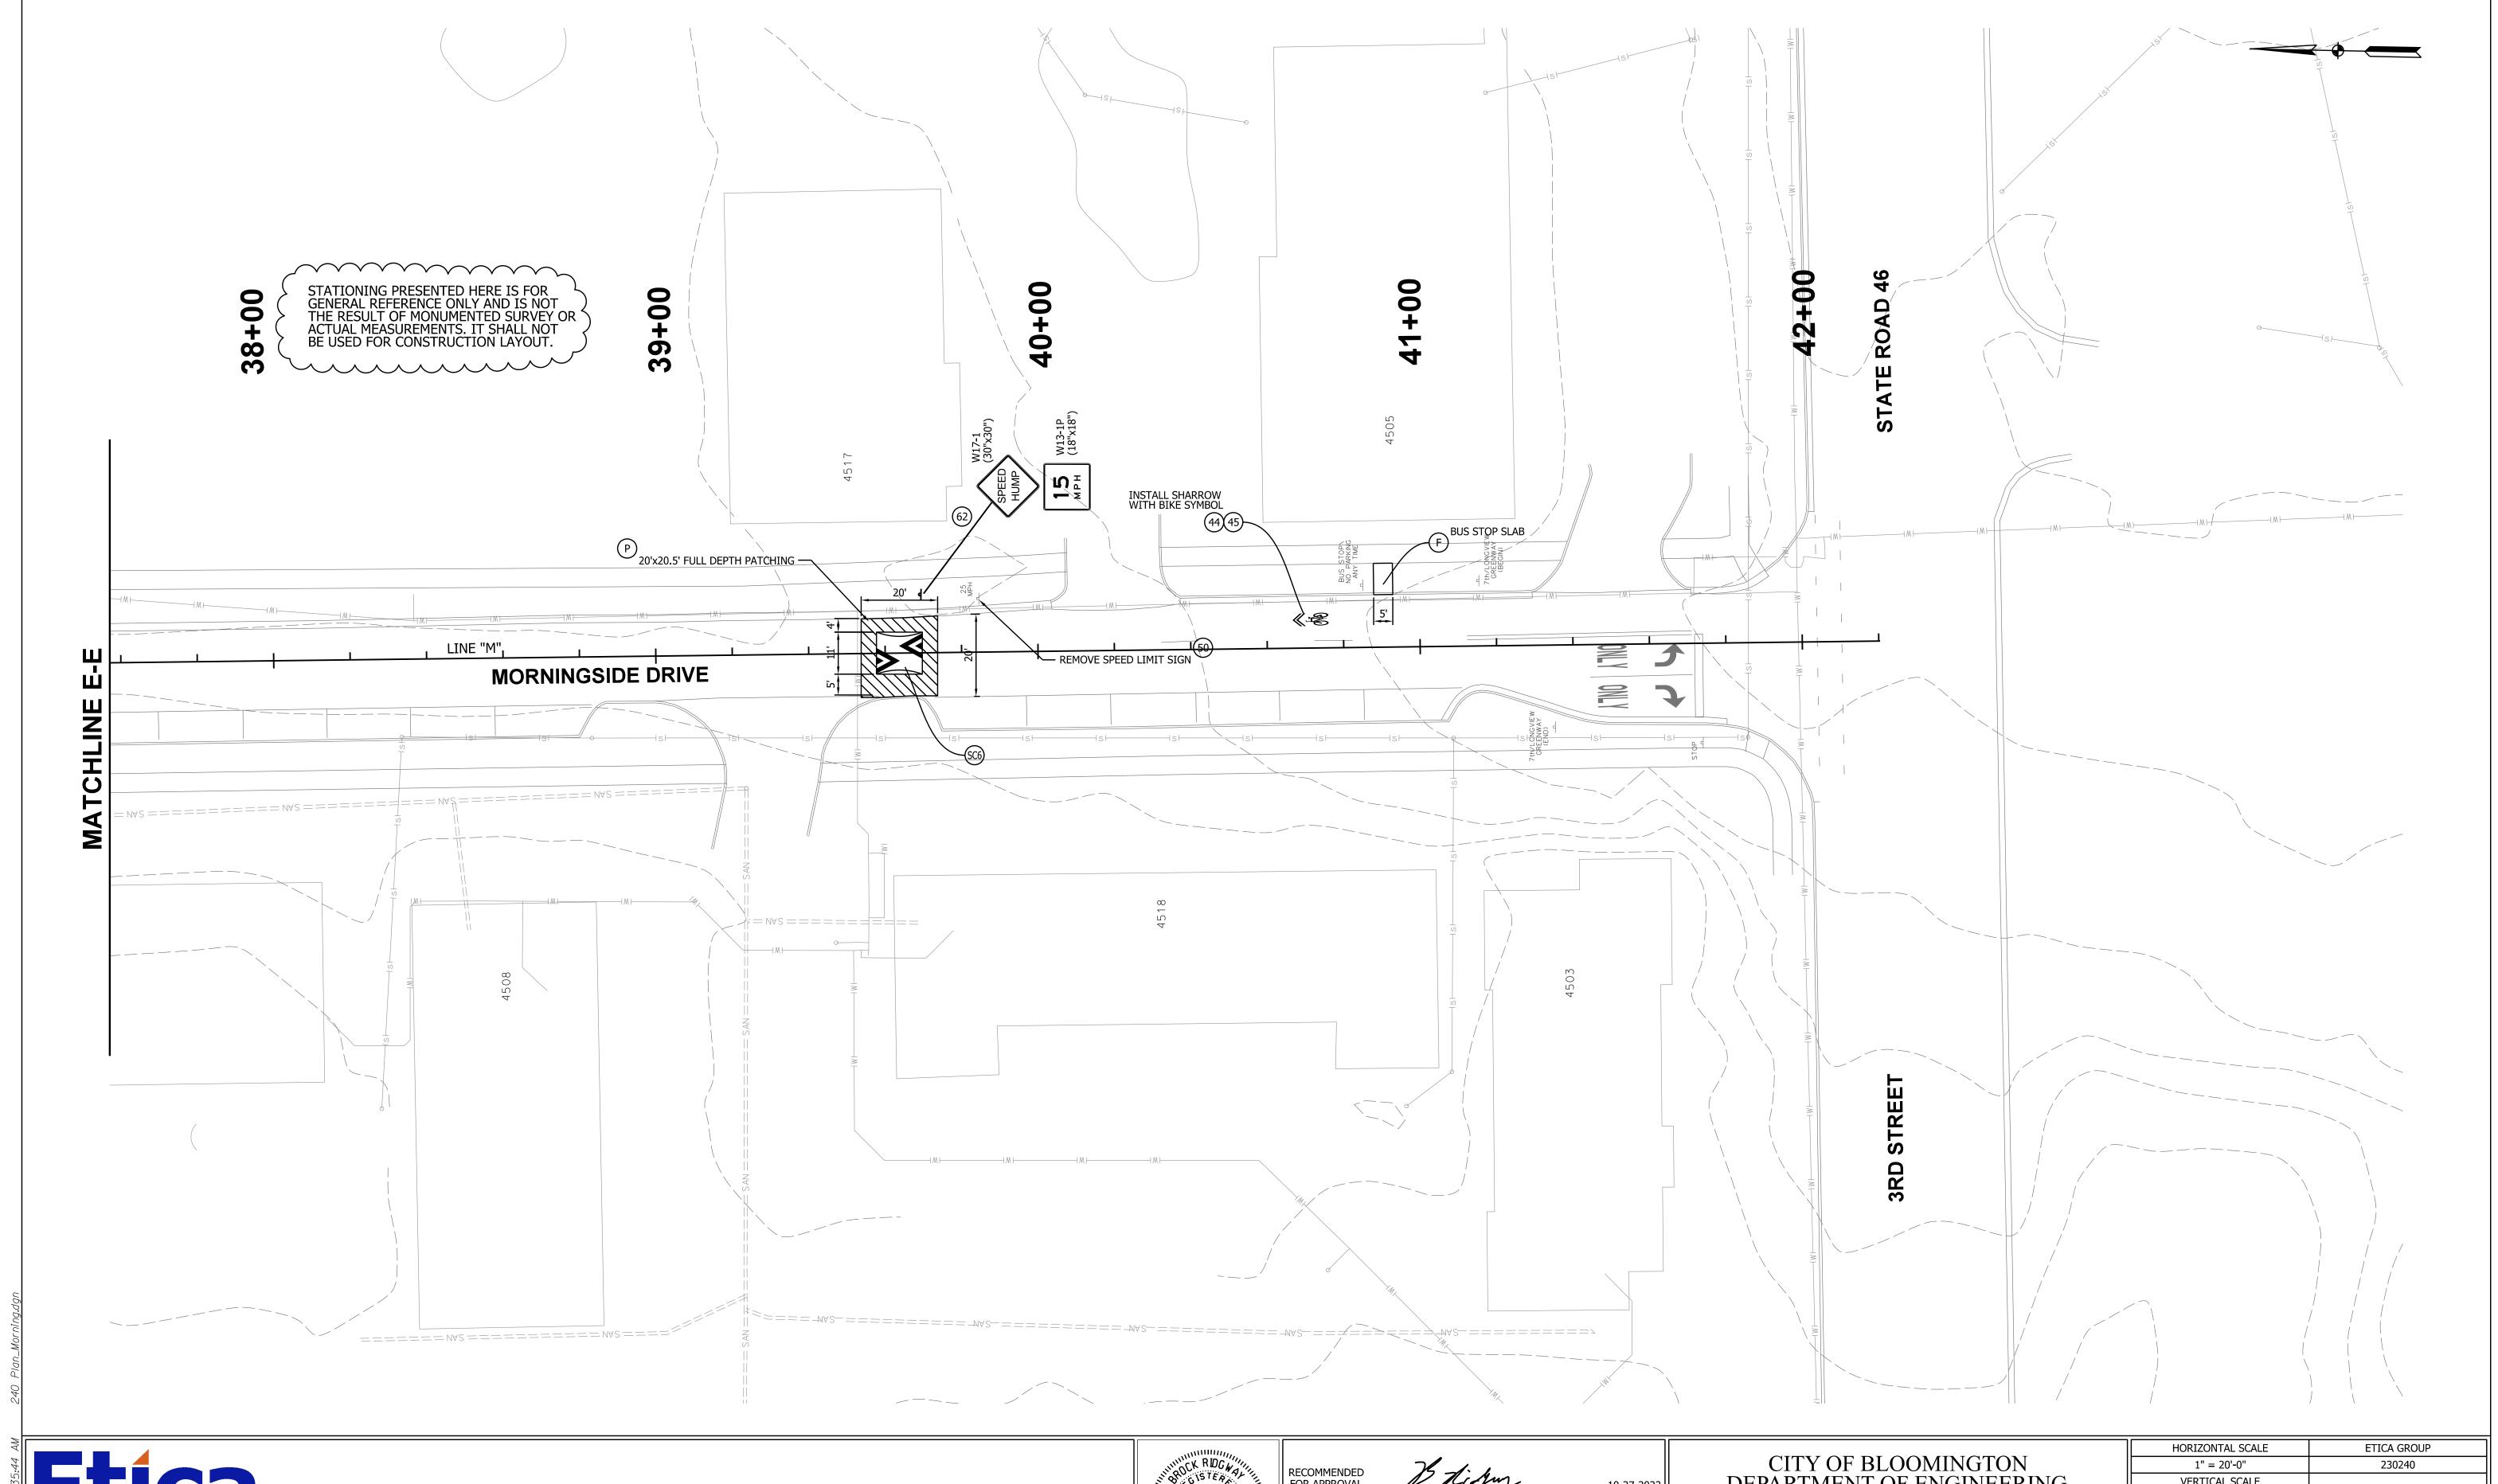







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CITY OF BLOOMINGTON
DEPARTMENT OF ENGINEERING

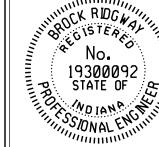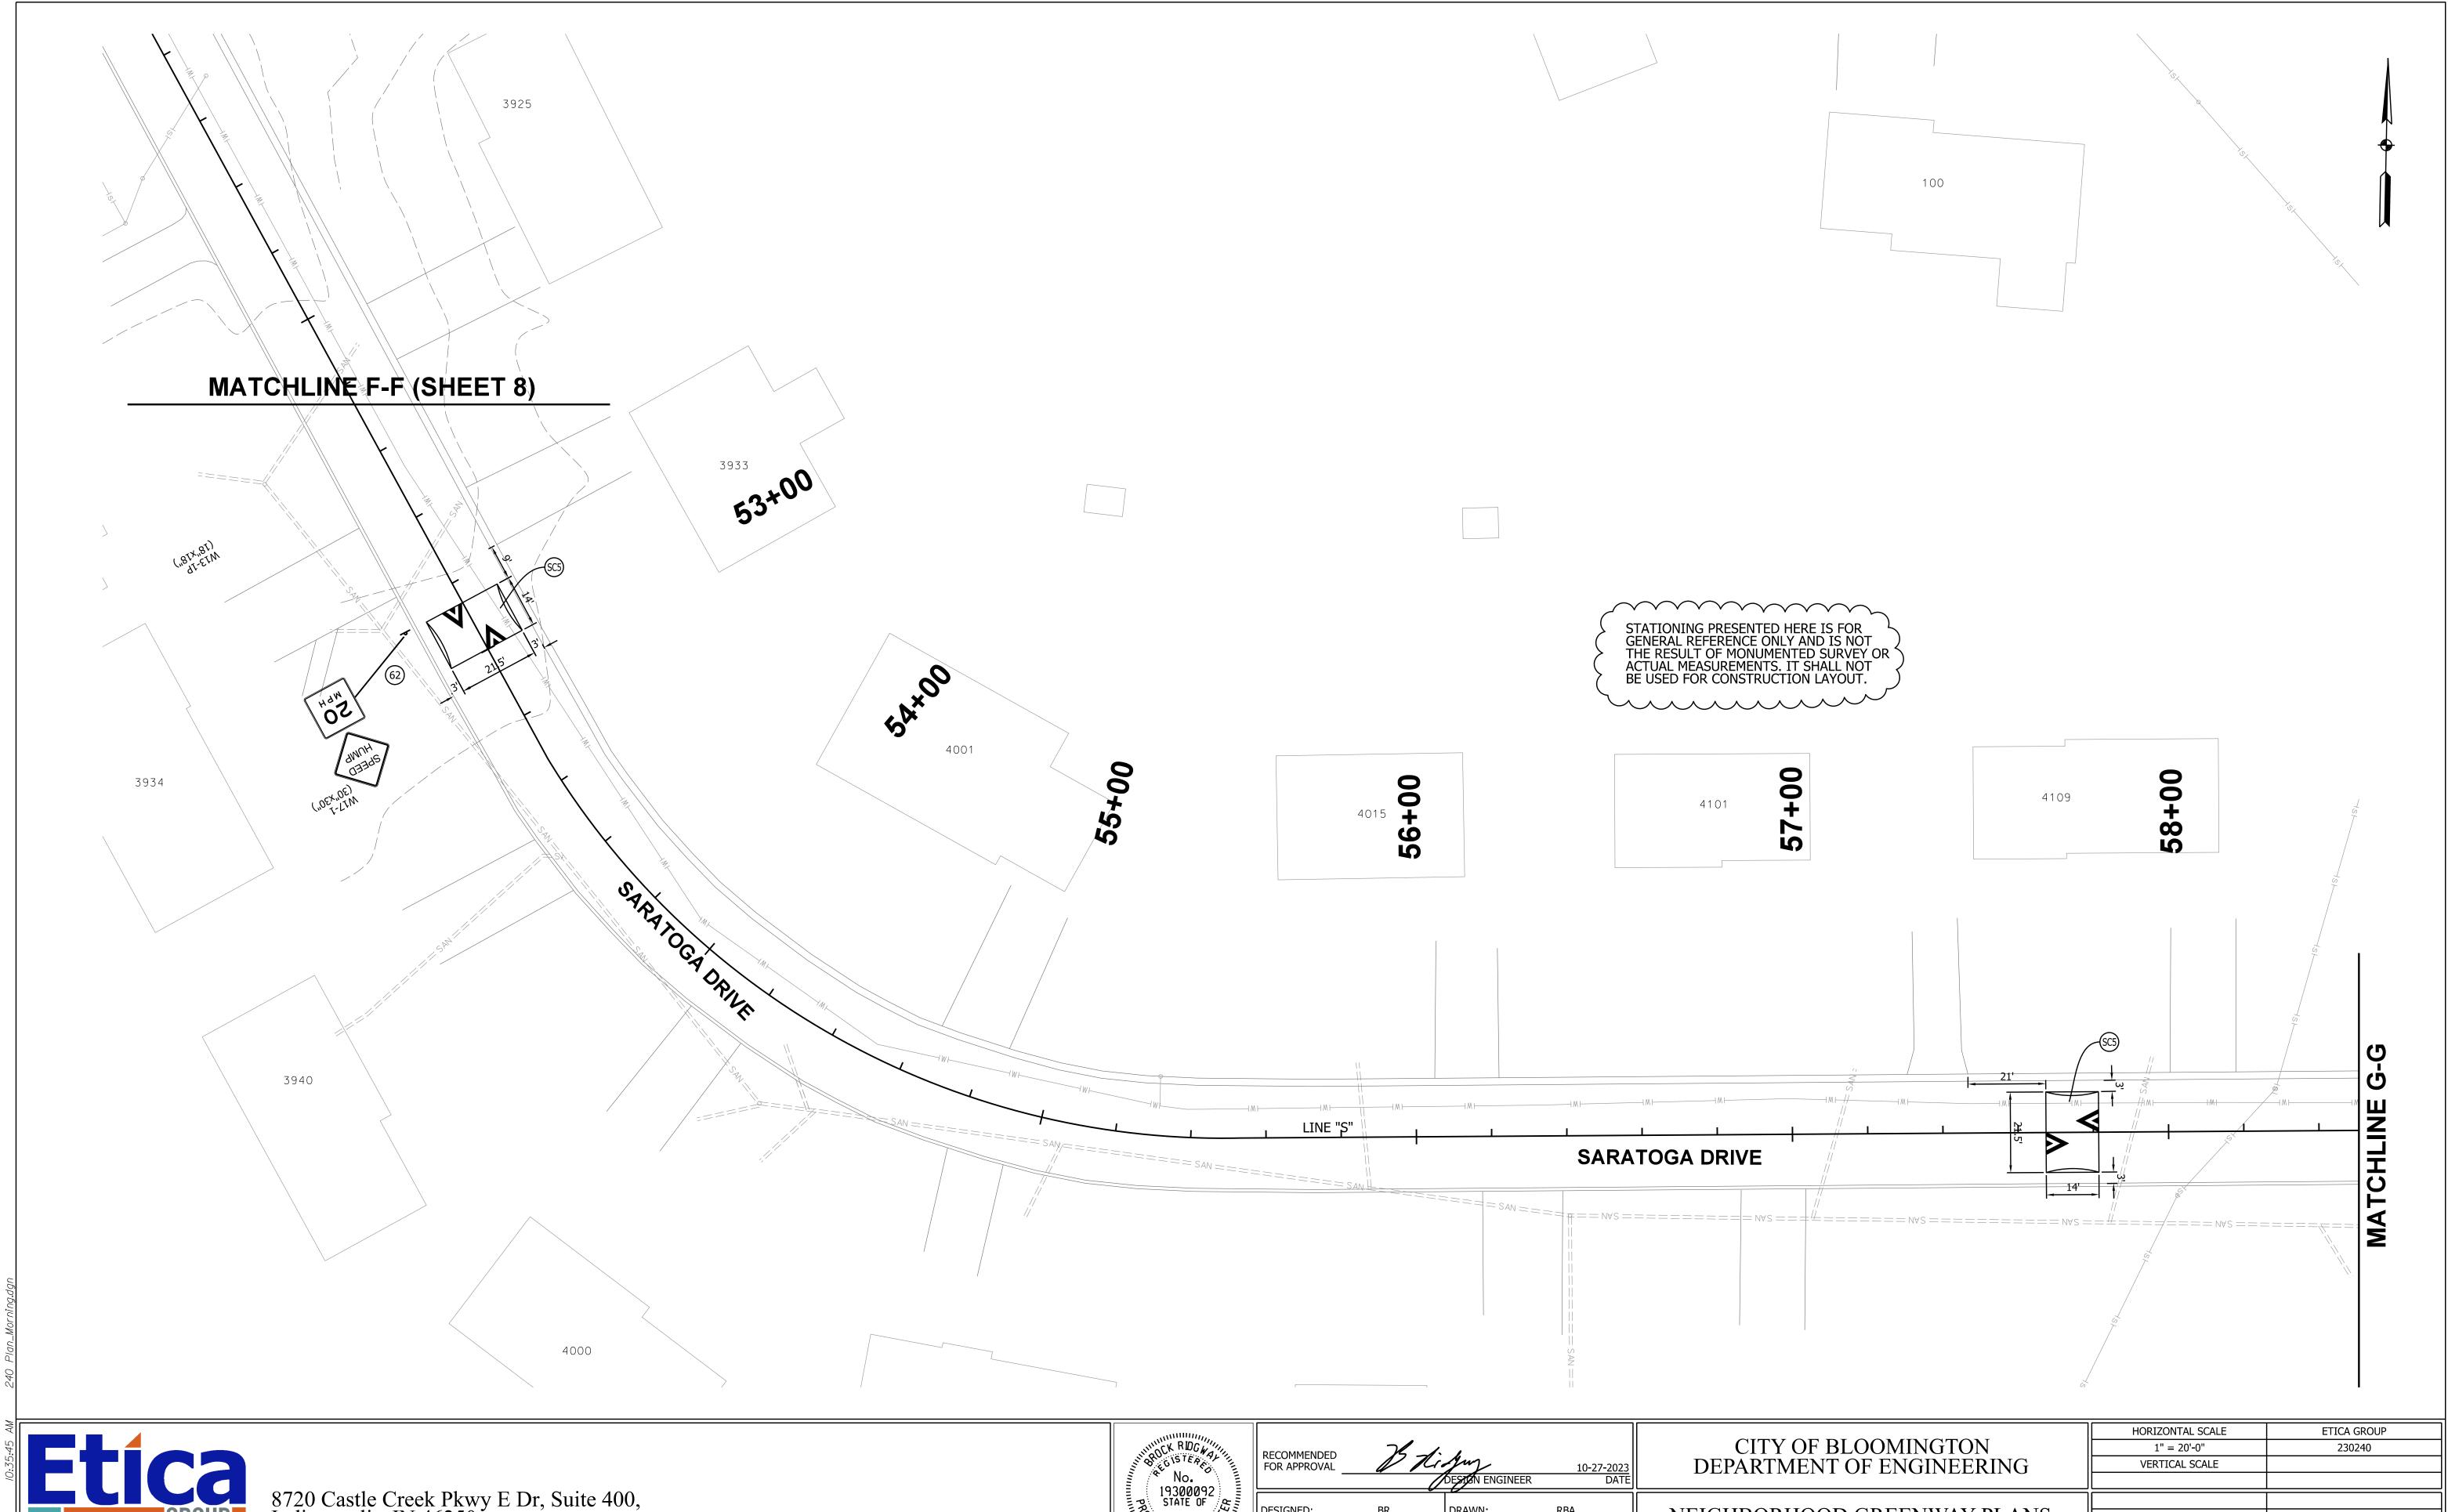
NEIGHBORHOOD GREENWAY PLANS
MORNINGSIDE DRIVE

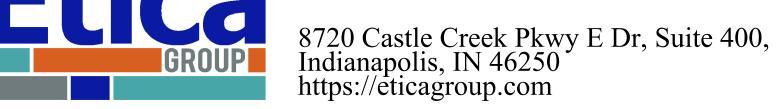
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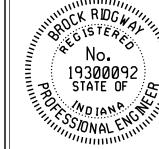
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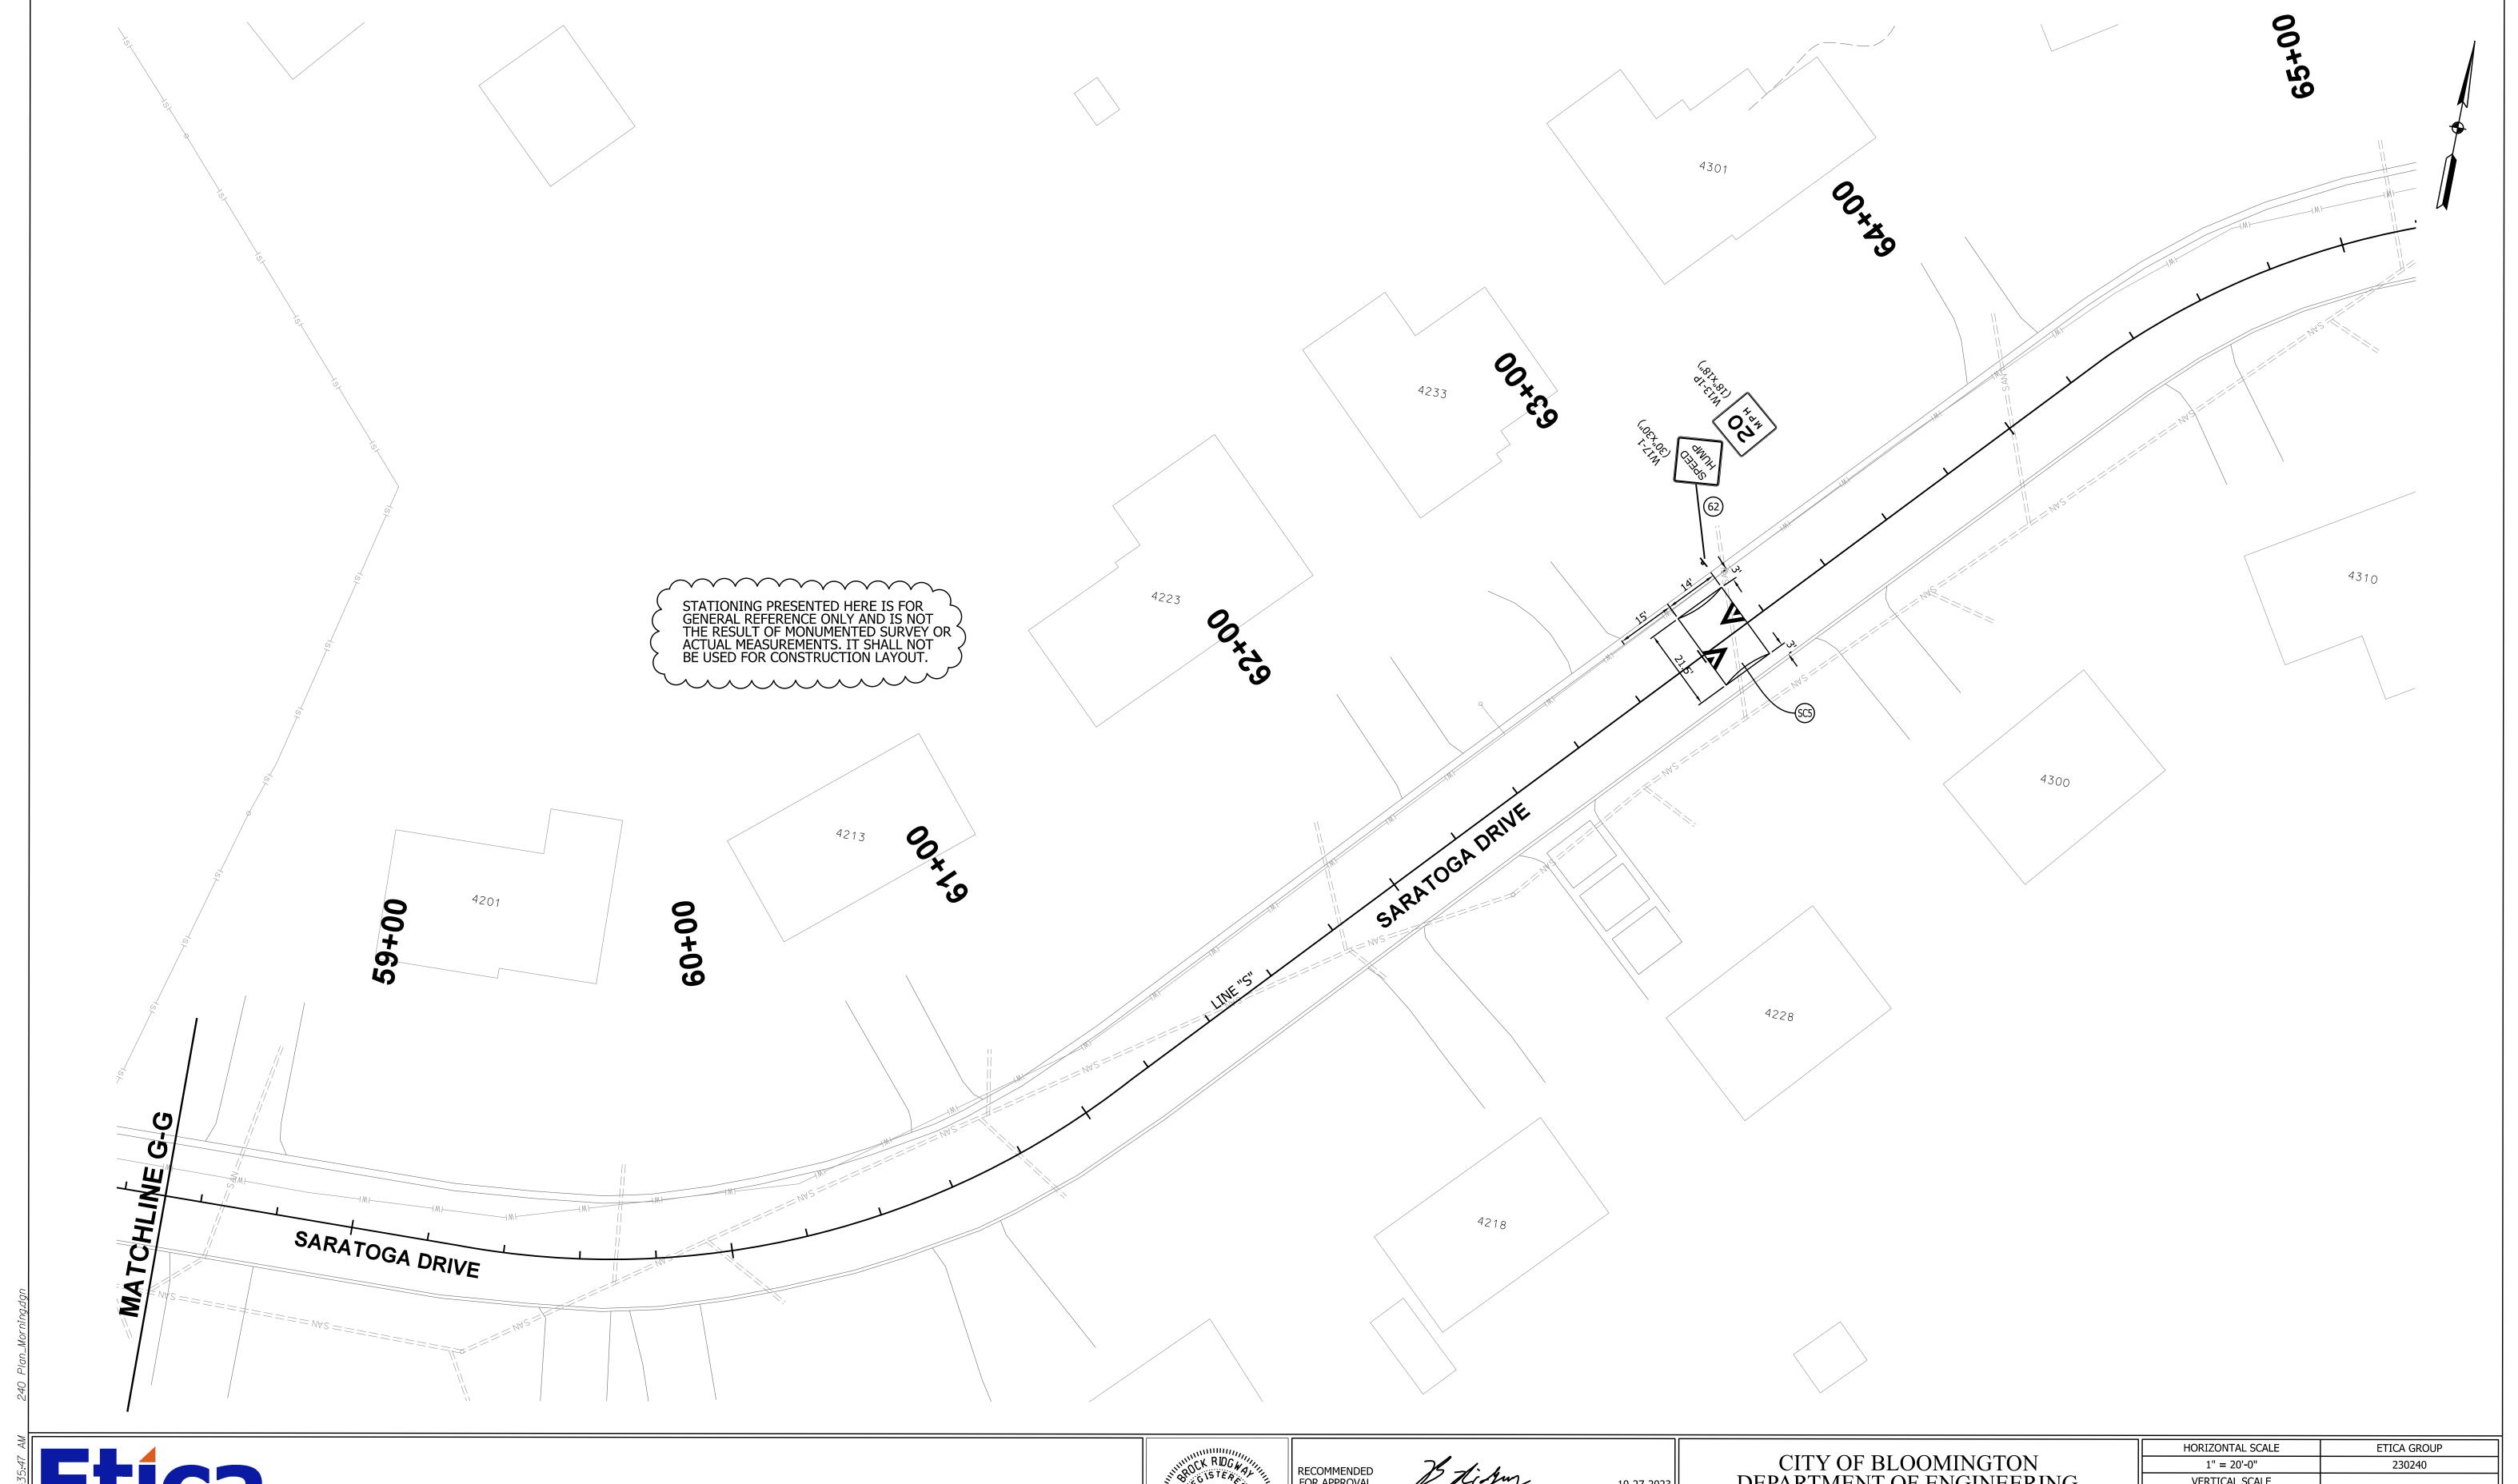




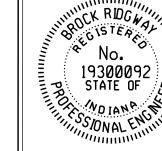


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CITY OF BLOOMINGTON	1" = 20'-0"	230240
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MORNINGSIDE DRIVE		15